CITY OF MARGATE

SANITARY FORCE MAIN INSTALLATION

LOCATION MAP






LESA PEERMAN MAYOR VICE MAYOR JOANNE SIMONE COMMISSIONER BRIAN DONAHUE


COMMISSIONER TOMMY RUZZANO

COMMISSIONER FRANK B TALERICO



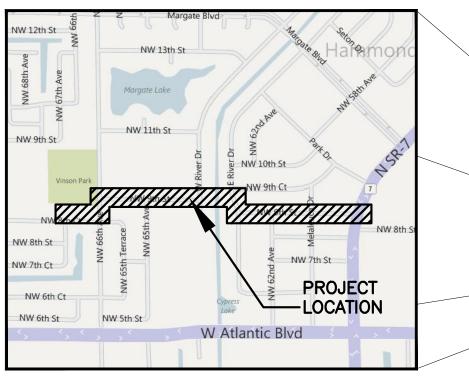



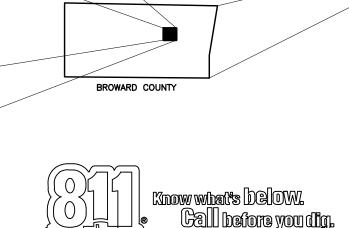

PREPARED FOR:

CITY OF MARGATE

PROJECT No. 11-1610



CRAIG A. SMITH & ASSOCIATES CONSULTING ENGINEERS-PLANNERS-SURVEYORS

7777 GLADES ROAD, SUITE 410 - BOCA RATON, FLORIDA 33434 (561) 791-9280 E-MAIL: CASASOC@CRAIGASMITH.COM CERTIFICATE OF AUTHORIZATION NUMBER: LB0003110



PETER A. KUNEN, P.E.

VICINITY MAP

SCALE: N.T.S.

FLORIDA PROFESSIONAL ENGINEER NO. 60730

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		GENERAL A	<u>3B</u>	REVIA	TIONS
	ABRV	DESCRIPTION		ABRV	
	AC	ASBESTOS CEMENT		MIN	MINIMUM
	ALUM	ALUMINUM		MJ	MECHAN
	ARV	AIR RELIEF VALVE		NPT	NATIONA
	BE	BURIED ELECTRIC		NTS	NOT TO
	BFV	BUTTERFLY VALVE		NRTS	NO REVI
	B/L	BASELINE		ос	ON CEN
	BSP	BACTERIOLOGICAL SAMPLE POINT BURIED		OE	OVERHE
	BT	BUREID TELEPHONE CABLE		OHW	OVERHEA
	CATV	CABLE TELEVISION		PC	POINT O
	СВ	CATCH BASIN		PHDPE	PERFORA
	CIP	CAST IRON PIPE		PL	PROPER ⁻
	Ģ.	CENTER LINE		PPD	POUNDS
	CONC	CONCRETE		PRB	POLLUTIO
	CV	CHECK VALVE		PROP	PROPOSI
	DIA	DIAMETER		PSI	POUNDS
	DIP	DUCTILE IRON PIPE		PV	PLUG VA
	DIPS	DUCTILE IRON PIPE SIZE		PVC	POLY VII
	EP	EXISTING PAVEMENT EDGE		RCP	REINFOR
	EXIST	EXISTING		R.E.	RIM ELE
	F&I	FURNISH AND INSTALL		RED	REDUCER
	FDEP	FLORIDA DEPT. OF ENVIRONMENTAL PROTECTION		REQD	REQUIRE
	FH	FIRE HYDRANT		RJ	RESTRAIN
	FM	FORCEMAIN		RWM	RAW WAT
	FPL	FLORIDA POWER & LIGHT		R/W	RIGHT-0
	G.E.	GRATE ELEVATION		SAN	SANITAR
	GV	GATE VALVE		SD	STORM
	HDPE	HIGH DENSITY POLYETHYLENE		TEL	TELEPHO
	I.E.	INVERT ELEVATION		TYP	TYPICAL
	LAT	LATERAL		UR	UTILITY
	LF	LINEAR FEET		BE	BURIED
	MAX	MAXIMUM		VCP	VITRIFIE
	MFGR	MANUFACTURER		WL	WATER L
	МН	MANHOLE		WM	WATER N

ABRV	DESCRIPTION
MIN	MINIMUM
MJ	MECHANICAL JOINT
NPT	NATIONAL PIPE THREAD
NTS	NOT TO SCALE
NRTS	NO REVISIONS THIS SHEET
OC	ON CENTER
OE	OVERHEAD ELECTRIC
OHW	OVERHEAD WIRE
PC	POINT OF CURVATURE
PHDPE	PERFORATED HIGH DENSITY POLYETHYLENE
PL	PROPERTY LINE
PPD	POUNDS PER DAY
PRB	POLLUTION RETARDANT BAFFLE
PROP	PROPOSED
PSI	POUNDS PER SQUARE INCH
PV	PLUG VALVE
PVC	POLY VINYL CHLORIDE
RCP REINFORCED CONCRETE PIPE	
R.E. RIM ELEVATION	
RED	REDUCER
REQD REQUIRED	
RJ	RESTRAINED JOINT
RWM	RAW WATER MAIN
R/W	RIGHT-OF-WAY LINE
SAN	SANITARY SEWER PIPE
SD	STORM DRAIN
TEL	TELEPHONE
TYP	TYPICAL
UR	UTILITY RISER
BE	BURIED ELECTRIC
VCP	VITRIFIED CLAY PIPE
WL	WATER LINE
WM	WATER METER

	<u>STANDARD SUR</u>	<u>VEY LINETYPE</u>	<u>S</u>
SYMBOL	DESCRIPTION	SYMBOL	DESCRIPTION
	BASELINE	BCTV BCTV	BURIED CABLE TV
	PARCEL LINE	FOC FOC	FIBER OPTIC CABLE
	BOUNDARY LINE	BT	BURIED TELEPHONE
	EASEMENT LINE	BCT BCT	BURIED TRAFFIC CONTROL
	LOT LINE	—— ОНЖ ———	OVERHEAD WIRE
	RIGHT OF WAY LINE	ВЕ ВЕ	BURIED ELECTRIC
	CENTER LINE	——— FM ———	FORCE MAIN
	SECTION LINE	SAN	SANITARY SEWER
. ~ , , , , , , , , , , , , , , , , , ,	LANDSCAPE LINE	SL	SANITARY LATERAL
	EDGE OF WATER	vs vs	VACUUM SEWER
+++++++++++++++++++++++++++++++++++++++	RR TRACKS	SD	STORM DRAIN
	PLAT LINE	WL WL	WATER MAIN
	CURB & GUTTER	ws	WATER SERVICE
_ x - x - x - x _	FENCE LINE	IRR	IRRIGATION LINE
	GUARD RAIL	GAS	GAS LINE ABOVE GROUND
UNK UNK	UNKNOWN UTILITY	BG BG	BURIED GAS LINE
— FIRE — FIRE —	FIRE LINE	— FUEL—— FUEL—	FUEL LINE

SURVEY SYMBOL LEGEND SYM. DESCRIPTION SYM. DESCRIPTION			
O ARV	AIR RELEASE VALVE	0	MANHOLE (UNKNOWN)
×	AERIAL TARGET	M	MONITORING WELL
N	BACKFLOW PREVENTOR	0	NAIL & DISC
•	BORING HOLE	₩ РМ	PARKING METER
4	BENCH MARK	Дмв	MAIL BOX
⋈BO	BLOW OFF	TEL	TELEPHONE RISER
®	BOLLARD	X	SATELLITE DISH
OCATV	CATV RISER	-	SIGN (1 POSTS)
	CATCH BASIN	SMH	SANITARY MANHOLE
$\overline{\mathcal{A}}$	CURB INLET	O S0	STUB OUT
•	CONCRETE MONUMENT	O _{SPR}	SPRINKLER
O 00	CLEAN OUT	SPR SP	SAMPLE POINT
	COLUMN	SDMH	STORM DRAIN MANHOLE
-0-	CONCRETE POWER POLE	O _{SNS}	SANITARY SERVICE
⊠ EJB	ELECTRIC JUNCTION BOX	Ø STP	STAND PIPE
EM	ELECTRIC METER	⊠ sv	SANITARY VALVE
ЕМН	ELECTRIC MANHOLE	Отмн	TELEPHONE MANHOLE
© EMTR	ELECTRIC MOTOR	<u> </u>	TRAVERSE POINT
Ф	ELECTRICAL OUTLET	O 12	CITRUS TREE
♥ FH	FIRE HYDRANT	₹ % 3 12	GENERIC TREE
• FP	FLAG POLE	€ 3 12	OAK TREE
€-	GUY WIRE	₩ 12	PINE TREE
⊡ GM	GAS METER	4 2'	PALM TREE
Gмн	GAS MANHOLE	\bigcirc	MANGROVE
4	GROUND LIGHT	UB	UTILITY BOX
-⊙-	GUY POLE	☐ UR	UTILITY RISER
⊠ _{GSV}	GAS VALVE	O ws	WATER LINE SERVICE
گر	HANDICAP MARKER	□ _{WM}	WATER METER
□ ICV	IRRIGATION CONTROL VALVE	<i>-</i>	WOOD POWER POLE
0	IRON PIPE	\triangleright	WATER LINE REDUCER
•	IRON ROD	⋈ wv	WATER VALVE
本	LIGHT POLE CONCRETE	⊕ YD	YARD DRAIN
\$	LIGHT POLE METAL	×10,30	GRADE EXISTING
\rightarrow	LIGHT POLE WOOD	19.25	GRADE PROPOSED
	ANDARD SURVEY		
SYM	DESCRIPTION	SYM	DESCRIPTION
	CONCRETE		STONE
	BRICK		

SHEET INDEX DESCRIPTION

NUMBER / SHEET		DESCRIPTION	
00 G-00		COVER SHEET	
01	G-01	CIVIL ABBREVIATIONS, INDEX & LEGEND SHEET	
02	G-02	KEY SHEET	
03	G-03	GENERAL NOTES	
04	G-04	EXIST. FORCEMAIN ABANDONMENT PLAN	
05-18	C-01 TO C-11	PLAN AND PROFILE	
19-23	C-12 TO C-16	STANDARD DETAILS	

LINE WEIGHTS

EXISTING SHADED SOLID LINES & TEXT DENOTE EXISTING EQUIPMENT, STRUCTURES AND WORK.


NON-SHADED DASHED LINES & TEXT DENOTE FUTURE EQUIPMENT, STRUCTURES AND

WOTAK.

PROPOSED


NON-SHADED, BOLD, SOLID LINES & TEXT DENOTE PROPOSED EQUIPMENT, STRUCTURES AND WORK. NOTE:
FOR GRAPHICAL CLARIFICATION ON PLANS CONTAINING BACKGROUND AERIAL PHOTOS EXISTING ITEMS ARE SHOWN HOLLOW WHERE AS PROPOSED ARE SHOWN SOLID.

EXISTING PROPOSED

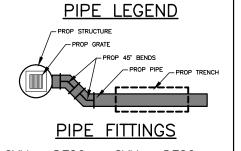

SYM	DESC	SYM	DESC
I	11.25° BEND	Ż	45° BEND
I	22.5° BEND	L	90° BEND
H	TEE	M	WYE
\blacksquare	REDUCER		PLUG
]	CAP		

NOTE: THE LEGEND SHOWN HEREON IS REPRESENTATIVE OF ALL CAS DRAFTING STANDARDS AND IS NOT PROJECT SPECIFIC.

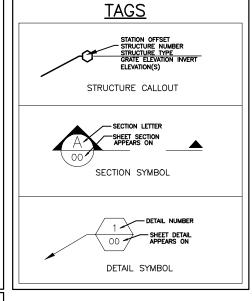

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1	11/18/13	REVISED PER CITY COMMENTS	ММ

| Date: _____11/01/12 |
| Designed: _____AC |
| Drawn: ____MM |
| Checked: ____PAK |

APPROVED BY: PETER A. KUNEN, P.E.

DATE
FLORIDA PROFESSIONAL ENGINEER NO. 60730

CRAIG A. SMITH & ASSOCIATES

CONSULTING ENGINEERS-PLANNERS-SURVEYORS

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CERTIFICATE. NO. LB0003110


CITY OF MARGATE BROWARD COUNTY, FL SANITARY FORCE MAIN INSTALLATION CIVIL ABBREVIATIONS, INDEX AND LEGEND SHEET FILE NAME: 01-1610-G-01-LGND.dwg LAST SAVED: 12/27/13 - 1:43pm

11-1610

G-01





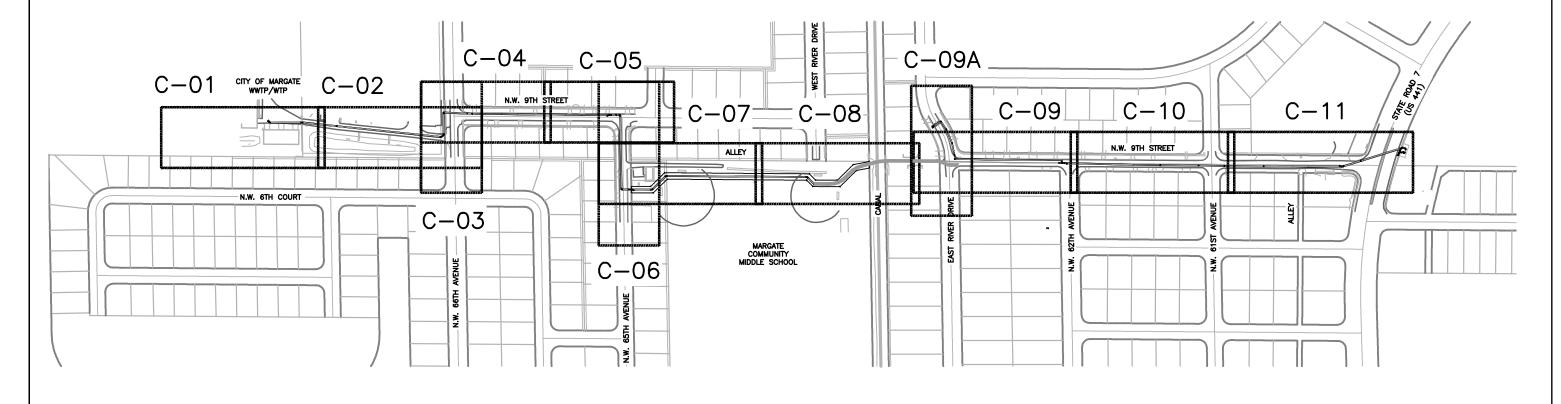

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APPROVED BY: PETER A. KUNEN, P.E. Date: ___11/01/12 esigned: AC Drawn: MM hecked: PAK FLORIDA PROFESSIONAL ENGINEER NO. 60730 CRAIG A. SMITH & ASSOCIATES

CONSULTING ENGINEERS-PLANNERS-SURVEYORS

7777 GLADES ROAD, SUITE 410
BOCA RATON, FLORIDA 33434
(561) 314-4445
CERTIFICATE. NO. LB0003110

CITY OF MARGATE BROWARD COUNTY, FL SANITARY FORCE MAIN INSTALLATION KEY SHEET

FILE NAME: 02-1610-G-02-KEY.dwg LAST SAVED: 09/27/13 - 3:18pm

G-02

11-1610

GENERAL NOTES

- . THE MAINTENANCE OF TRAFFIC FOR THIS PROJECT SHALL BE IN ACCORDANCE WITH THE MANUAL OF UNIFORM TRAFFIC CONTROL DEVICES FOR STREET AND HIGHWAYS, U.S. DOT, F.H.W.A. AND THE STATE OF FLORIDA MANUAL OF ROADWAY TRAFFIC DESIGN STANDARDS.
- THE CONTRACTOR SHALL SUBMIT A MAINTENANCE OF TRAFFIC PLAN FOR APPROVAL TO THE CITY OF MARGATE PRIOR TO CONSTRUCTION.
- CONTRACTOR IS RESPONSIBLE FOR OBTAINING ALL NECESSARY PERMITS, INCLUDING PREPARATION OF ALL PLANS REQUIRED TO OBTAIN THESE PERMITS
- 4. ANY PUBLIC LAND CORNER WITHIN THE LIMITS OF CONSTRUCTION IS TO BE PROTECTED.
- THE CONTRACTOR IS WARNED TO USE EXTREME CAUTION WHEN CONSTRUCTION IS NEAR OR AROUND ANY EXISTING FACILITIES, PARTICULARLY ELECTRICAL. GAS. AND PRESSURIZED PIPE.
- 6. IF ABANDONED GAS, WATER AND SEWER SERVICE LATERALS ARE ENCOUNTERED (AND THEIR ABANDONMENT CONFIRMED) DURING EXCAVATION, THE SECTION IN THE EXCAVATED ENVELOPE WILL BE REMOVED AND THE STUB ON THE SIDE CONNECTED TO THE MAIN WILL BE CAPPED. PLUGGED OR OTHERWISE SEALED.
- STABILIZED SUBGRADE IN RIGHTS-OF-WAY SHALL BE COMPACTED TO 98% FDOT MAXIMUM DENSITY AS DETERMINED BY AASHTO T-99(C) IN 8+ MAXIMUM LAYERS WITH A MINIMUM LIMEROCK BEARING RATIO (LBR) OF 40.
- LIMEROCK BASE MATERIAL SHALL CONFORM TO THE REQUIREMENTS OF SECTION 911 OF FDOT STANDARD SPECIFICATIONS FOR ROADS AND BRIDGES (2010).
- ASPHALTIC CONCRETE SURFACE COURSE SHALL CONFORM TO THE REQUIREMENTS OF SECTION 331 OF FDOT STANDARD SPECIFICATIONS (2010)
- 10. PRIME COAT AND TACK COAT FOR BASE COURSE SHALL CONFORM TO THE REQUIREMENTS OF SECTION 300-1 THROUGH 300-7 OF FDOT STANDARD SPECIFICATIONS. PRIME COAT SHALL BE APPLIED AT A RATE OF 0.25 GALLONS PER SQUARE YARD UNLESS A VARIATION RATE IS APPROVED BY THE FINGINFER.
- 1. THE LOCATIONS OF ALL EXISTING UTILITIES SHOWN ARE APPROXIMATE. IN ORDER TO PREVENT DELAY THE CONTRACTOR SHALL LOCATE AND EXPOSE ALL EXISTING UTILITIES SUFFICIENTLY AHEAD OF CONSTRUCTION TO ALLOW REDESIGN BY THE ENGINEER IF SUCH UTILITIES ARE FOUND TO BE DIFFERENT THAN SHOWN ON THESE PLANS.
- 12. CONTRACTOR SHALL CONTACT FDOT, THE CITY OF MARGATE AND THE UNDER GROUND UTILITIES NOTIFICATION CENTER 48 HOURS PRIOR TO COMMENCEMENT OF CONSTRUCTION.
- 13. CONTRACTOR SHALL NOTIFY CRAIG A. SMITH & ASSOCIATES AT (561) 791-9280 AT LEAST 48 HOURS PRIOR TO COMMENCING CONSTRUCTION.
- 14. THE CONTRACTOR SHALL NOTIFY FLORIDA POWER AND LIGHT CO., AT&T BROADBAND, LEVEL 3, TECO PEOPLES GAS, ATLANTIC BROADBAND, AND ANY OTHER UTILITY COMPANY WHICH MAY HAVE THEIR UTILITIES WITHIN THE CONSTRUCTION AREAS BEFORE BEGINNING CONSTRUCTION.
- 15. A PRE-CONSTRUCTION MEETING IS TO BE HELD BETWEEN FDOT, THE ENGINEER OF RECORD, THE CONTRACTOR, AND ALL OTHER INTERESTED PARTIES PRIOR TO COMMENCEMENT OF CONSTRUCTION.
- 16. SHOP DRAWINGS FOR ALL MATERIALS BEING USED SHALL BE SUBMITTED TO THE ENGINEER FOR APPROVAL PRIOR TO INSTALLATION. ANY ITEMS INSTALLED WITHOUT PRIOR APPROVAL BY THE ENGINEER SHALL BE SOLELY AT THE CONTRACTORS RISK. SHOULD THE AT RISK ITEM BE FOUND INSUFFICIENT OR BE REJECTED BY THE ENGINEER, THE CONTRACTOR WILL IMMEDIATELY REMOVE THE REJECTED ITEM AND REPLACE IT WITH A PROPERLY APPROVED ITEM AT NO COST TO THE CITY. IN ADDITION, THE COSTS OF ALL RELATED RE—INSPECTION, RE—EVALUATION AND ANY REQUIRED SURVEY, WILL BE THE RESPONSIBILITY OF THE CONTRACTOR, AND SUFFICIENT AMOUNTS TO COVER SUCH CHARGES WILL BE WITHHELD FROM ANY MONIES OWED TO THE CONTRACTOR.
- 17. ALL LABOR, MATERIALS, AND METHODS OF CONSTRUCTION SHALL BE IN STRICT ACCORDANCE WITH THE PLANS AND CONSTRUCTION STANDARDS AND SPECIFICATIONS. SUBSTITUTIONS AND DEVIATIONS FROM PLANS AND SPECIFICATIONS SHALL BE PERMITTED ONLY WHEN WRITTEN APPROVAL HAS BEEN ISSUED BY THE ENGINEER.
- 18. CONSTRUCTION INSPECTION WILL BE PERFORMED BY THE ENGINEER AND IS REQUIRED. THE CONTRACTOR SHALL NOTIFY THE ENGINEER AT LEAST 48 HOURS BEFORE BEGINNING CONSTRUCTION AND AT LEAST 48 HOURS BEFORE REQUIRING INSPECTION OF EACH AND EVERY PHASE OF WORK.

- 19. THE CONTRACTOR SHALL MAINTAIN A CURRENT SET OF APPROVED CONSTRUCTION PLANS ON THE JOB SITE DURING ALL PHASES OF CONSTRUCTION AND SHALL NOTE ANY AREAS WHERE THE CONSTRUCTION DEVIATED FROM THE DESIGN.
- 20. ANY AND ALL PAVEMENT MARKINGS, SIGNS, MESSAGES OR RAISED PAVEMENT MARKERS DISTURBED OR DESTROYED AS A RESULT OF CONSTRUCTION OR CONTRACTORS OPERATIONS SHALL BE IMMEDIATELY REPLACED IN ACCORDANCE WITH FDOT STANDARDS. COSTS FOR THIS WORK ARE UNDERSTOOD TO BE INCLUDED IN THE LUMP SUM M.O.T. ITEM. PERMANENT THERMOPLASTIC STRIPING SHALL BE PLACED AT THE DIRECTION OF THE ENGINEER AND PAID FOR IN THE APPROPRIATE BID ITEMS.
- 21. CONTRACTOR TO MAINTAIN ACCESS TO BUSINESS AND RESIDENTIAL LOCATIONS BY NORMAL MEANS AND METHODS I.E. TEMPORARY STEEL PLATES, TEMP LIMEROCK, ETC. ALL ASSOCIATED COSTS TO BE INCLUDED IN M.O.T. ITEM.
- 2. THE CONTRACTOR SHALL BE RESPONSIBLE AT ALL TIMES THROUGHOUT THE DURATION OF CONSTRUCTION FOR THE PROTECTION OF EXISTING AND NEWLY INSTALLED UTILITIES FROM DAMAGE OR DISRUPTION OF SERVICE. THE CONTRACTOR SHALL BE RESPONSIBLE FOR TAKING SUCH MEASURES AS NECESSARY TO PROTECT THE HEALTH, SAFETY AND WELFARE OF THOSE PERSONS HAVING ACCESS TO THE WORK SITE.
- 23. THE CONTRACTOR SHALL BE RESPONSIBLE FOR OBTAINING LOCATIONS FROM ALL OTHER UTILITY FACILITIES.
- THE CONTRACTOR SHALL SCHEDULE INSPECTION AND TESTS A MINIMUM OF 24-48 HOURS IN ADVANCE.
- 25. ALL FITTINGS SHALL BE DUCTILE IRON WITH MECHANICAL JOINTS AND CERAMIC EPOXY LINING FOR FORCEMAINS.
- 6. ALL TRENCHING, PIPE—LAYING, BACKFILL AND PRESSURE TESTING MUST COMPLY WITH THE CITY OF MARGATE, BROWARD COUNTY PLANNING AND ENVIRONMENTAL REGULATIONS DIVISION AND FDEP STANDARDS. DISINFECTION SHALL NOT BE REQUIRED FOR SEWAGE FORCEMAINS.
- 27. ALL ELEVATIONS ARE BASED ON NGVD OF 1929, UNLESS OTHERWISE
- 28. THE CONTRACTOR SHALL REPLACE ALL PAVING, STABILIZED EARTH, CURBS, DRIVEWAYS, SIDEWALKS, FENCES, MAIL BOXES, SIGNS, PAVEMENT MARKINGS AND OTHER IMPROVEMENTS WITH THE SAME TYPE OF MATERIAL THAT WAS REMOVED DURING THE CONSTRUCTION OR AS DIRECTED BY THE ENGINEER. SOD, FENCES, WALLS, ETC.SHALL BE REPLACED WITHIN 14 DAYS. CONCRETE DRIVEWAYS SHALL BE REPLACED FROM THE ADJACENT ROAD TO 2 FEET PAST CONSTRUCTION.
- 29. CONTRACTOR SHALL PROVIDE ALL WARNING SIGNALS, SIGNS, LIGHTS AND FLAG PERSONS AS REQUIRED BY F.D.O.T. IN THE "MANUAL ON TRAFFIC CONTROL AND SAFE PRACTICES".
- 30. CONTRACTOR SHALL SOD OR SEED & MULCH ENTIRE AREA DISTURBED BY CONSTRUCTION ACTIVITIES AS PER THE SPECIFICATIONS WITHIN 7 DAYS OF THE COMPLETION OF CONSTRUCTION IN THE AREA.
- 31. ALL STRUCTURES, ROADWAYS, SIGNS, FENCES, AND AREAS AFFECTED BY THE WORK SHALL BE RESTORED TO ORIGINAL CONDITIONS.
- 32. ALL WORK TO BE PERFORMED IN ACCORDANCE WITH UTILITY OWNER STANDARDS.
- 33. ALL CONSTRUCTION AND RESTORATION WORK WITHIN FDOT RIGHT-OF-WAY SHALL CONFORM TO ALL PARTS FDOT DESIGN STANDARDS INDEX (2010), FDOT STANDARD SPECIFICATIONS FOR ROAD AND BRIDGE CONSTRUCTION (2010), AND THE FDOT UTILITY ACCOMMODATION MANUAL (2010).
- 34. ALL EXISTING DRAINAGE SYSTEMS SHALL BE PROTECTED AT ALL TIMES BY THE CONTRACTOR. ANY DAMAGE TO THE DRAINAGE SYSTEMS (STRUCTURES OR PIPES) SHALL BE REPAIRED/REPLACED BY THE CONTRACTOR AT NO COST TO THE CITY.
- 35. THE CONTRACTOR SHALL CONTACT FDOT PRIOR TO ANY SUBSURFACE ACTIVITIES AND SHALL PROTECT EXISTING TRAFFIC SIGNAL POLES AND EQUIPMENT AND/OR EXISTING STREET LIGHTING, POLES, EQUIPMENT, AND CONDUIT AT ALL TIMES DURING CONSTRUCTION ACTIVITIES. ANY DAMAGES TO EXISTING EQUIPMENT SHALL BE THE SOLE RESPONSIBILITY OF THE CONTRACTOR TO REPAIR AT THEIR OWN COST, AND ALL RESTORATION WORK SHALL BE CORDINATED WITH FDOT.
- 56. PRIOR TO CONSTRUCTION THE CONTRACTOR SHALL COORDINATE WITH LEVEL 3 SERVICE FOR LOCATIONS OF ALL EXISTING FIBER OPTIC UTILITIES WITHIN THE STATE ROAD 7 CORRIDOR.
- 37. ALL WORK LOCATED WITHIN THE LIMITS OF THE MARGATE SCHOOL PROPERTY SHALL ONLY BE PERFORMED WITHIN SUMMER MONTHS.

GENERAL PIPELINE NOTES

- ALL MATERIALS, INSTALLATION, TESTING AND SPECIFICATIONS SHALL BE IN ACCORDANCE WITH THE REQUIREMENTS APPLICABLE TO PUBLIC RIGHT OF WAY UNDER FLORIDA DEPARTMENT OF TRANSPORTATION JURISDICTION AND BROWARD COUNTY PERD, FDEP MINIMUM STANDARDS AND THE TECHNICAL SPECIFICATIONS (WHEN APPLICABLE).
- 2. LOCATION OF EXISTING UNDERGROUND UTILITIES HAS BEEN PREPARED FROM THE MOST RELIABLE INFORMATION AVAILABLE TO THE ENGINEER. THE CONTRACTOR SHALL BE RESPONSIBLE TO VERIFY LOCATION AND DEPTH OF ALL PERTINENT UTILITIES PRIOR TO COMMENCEMENT OF CONSTRUCTION WORK.
- 3. PIPE AND FITTINGS SHALL CONFORM TO THE CONTRACT SPECIFICATIONS SECTION 15105 PIPES AND TUBES.
- 4. MINIMUM COVER FOR DUCTILE IRON PIPE SHALL BE 36". MINIMUM COVER FOR P.V.C. AND H.D.P.E. PIPE IS 36".
- 6. ALL PRESSURE MAINS SHALL BE HYDROSTATICALLY PRESSURE TESTED FOR A PERIOD OF NOT LESS THAN 2 HOURS AT 150 PSI WITH AN ALLOWABLE LEAKAGE NOT TO EXCEED THE FORMULA, L = SD 1/2P/ 148,000

IN WHICH -I - FOUALS ALLOWABLE LEAKAGE IN GALLONS/HOUR

- -S- EQUALS LENGTH OF PIPE IN FEET,
- -D- EQUALS NOMINAL DIAMETER OF PIPE IN INCHES,
- -P- EQUALS AVERAGE TEST PRESSURE DURING TEST IN LBS/SQ. IN. ALL TESTING SHALL BE MADE IN ACCORDANCE WITH ANSI/AWWA C600-LATEST EDITION (HYDROSTATIC TESTS).
- 6. COMPLETE "AS—BUILT" INFORMATION RELATIVE TO METERS, VALVES, FITTINGS, LENGTH OF PIPE AND ELEVATIONS, SHALL BE ACCURATELY RECORDED BY A PROFESSIONAL SURVEYOR REGISTERED IN THE STATE OF FLORIDA AND SUBMITTED TO THE ENGINEER PRIOR TO FINAL ACCEPTANCE OF THE WORK AS SPECIFIED IN SECTION 01720. FINAL APPROVAL OF THE PROJECT IS SUBJECT TO THE FINAL REVIEW AND APPROVAL OF THE "AS—BUILT" INFORMATION BY THE ENGINEER AND REGULATORY AGENCIES.
- 7. ALL MECHANICAL JOINTS SHALL BE RESTRAINED IN ACCORDANCE WITH THE PLANS, SPECIFICATIONS AND IN COMPLIANCE WITH AWWA STANDARDS.
- 8. WHERE FORCE MAIN REQUIRES DEFLECTION, THE AMOUNT OF DEFLECTION PER PIPE JOINT SHALL NOT EXCEED 75% OF THE MANUFACTURES RECOMMENDED DEFLECTION. THE LENGTH OF EXISTING PIPE TO BE DEFLECTED SHALL BE APPROVED BY THE ENGINEER.
- 9. THE CONTRACTOR SHALL VERIFY ALL DIMENSIONS, QUANTITIES AND DETAILS SHOWN ON THE DRAWINGS, SUPPLEMENTARY DRAWINGS, SCHEDULES OR OTHER DATA RECEIVED FROM THE ENGINEER AND SHALL NOTIFY HIM OF ALL OMISSIONS, ERRORS, CONFLICTS, AND DISCREPANCIES FOUND THEREIN. FAILURE TO DISCOVER OR TO CORRECT ERRORS, CONFLICTS OR DISCREPANCIES SHALL NOT RELIEVE THE CONTRACTOR OF FULL RESPONSIBILITY FOR UNSATISFACTORY WORK, FAULTY CONSTRUCTION OR IMPROPER OPERATION RESULTING THEREFROM. NOR FROM RECTIFYING SUCH CONDITION. AT HIS OWN EXPENSE.
- 10. WHERE THE PROPOSED FORCE MAIN IS IN CONFLICT WITH OTHER EXISTING OR PROPOSED UTILITIES, THE NEW MAIN SHALL BE DEFLECTED IN ACCORDANCE WITH THE STANDARD UTILITY CROSSING DETAIL. THE SPECIAL UTILITY CROSSING DETAIL WITH BENDS SHALL ONLY BE USED WHEN APPROVED BY THE FNGINFFR
- 11. COMPLIANCE TO "TRENCH SAFETY ACT" IS REQUIRED FOR ALL EXCAVATIONS IN EXCESS OF 5 FEET DEEP.
- 12. ALL GATE VALVES AND AIR RELEASE VALVES TO CONFORM TO CITY, COUNTY AND STATE STANDARDS AND SPECIFICATIONS.
- 13. ALL DIRECTIONALLY DRILLED PIPE SHALL BE HIGH DENSITY POLYETHYLENE PIPE (DIPS) WITH AN DR OF 11.
- 14. CONTRACTOR TO GROUT FILL AND ABANDON IN PLACE EXISTING 12" FORCE MAIN. THE MAIN IS TO REMAIN ACTIVE UNTIL THE PROPOSED 20" FORCE MAIN IS INSTALLED, CERTIFIED, AND ACTIVATED.
- 15. THE CONTRACTOR SHALL USE CAUTION WHILE REMOVING ANY ASBESTOS—CEMENT PIPE (ACP) AND FOLLOW CURRENT EPA AND OSHA GUIDELINES. PIPE SHALL BE DISCONNECTED AT JOINTS AND REMOVED AND DISPOSED OF WITHOUT BREAKING. IF THE EXISTING PIPE IS FRIABLE OR REQUIRES CUTTING, THE CONTRACTOR SHALL REMOVE AND DISPOSE OF THE PIPE IN ACCORDANCE WITH EPA REGULATIONS. DISPOSAL OF ASBESTOS—CEMENT PIPE IS TO BE DONE IN ACCORDANCE WITH EPA REGULATIONS.
- THE CONTRACTOR IS RESPONSIBLE FOR ALL DEWATERING ACTIVITIES REQUIRED FOR CONSTRUCTION OF THIS PROJECT.

NOTES ON WATER-SEWER INSTALLATION

- 1. A HORIZONTAL DISTANCE OF AT LEAST 6 FEET, AND PREFERABLY 10 FEET (OUTSIDE TO OUTSIDE), SHALL BE MAINTAINED BETWEEN GRAVITY OR PRESSURE SEWER PIPES AND WATER PIPES. THE MINIMUM HORIZONTAL SEPARATION CAN BE REDUCED TO 3 FEET FOR VACUUM—TYPE SEWERS OR FOR GRAVITY SEWERS WHERE THE BOTTOM OF THE SEWER PIPE IS AT LEAST 6 INCHES BELOW THE BOTTOM OF THE WATER PIPE. WHEN THE ABOVE SPECIFIED HORIZONTAL DISTANCE CRITERIA CANNOT BE MET DUE TO AN EXISTING UNDERGROUND FACILITY CONFLICT, SMALLER SEPARATIONS ARE ALLOWED IF:
 - A- THE SEWER PIPES ARE DESIGNED AND CONSTRUCTED EQUAL TO THE WATER PIPE AND PRESSURE TESTED AT 150 PSI.
 - B- THE SEWER IS ENCASED IN A WATERTIGHT CARRIER PIPE OR CONCRETE.
- C- THE TOP OF THE SEWER IS AT LEAST 18 INCHES BELOW THE BOTTOM OF THE WATER PIPE
- 2. A VERTICAL DISTANCE OF AT LEAST 12 INCHES (OUTSIDE TO OUTSIDE) SHALL BE MAINTAINED BETWEEN ANY WATER AND SEWER MAINS WITH SEWER PIPES PREFERABLY CROSSING UNDER WATER MAINS. THE MINIMUM VERTICAL SEPARATION CAN BE REDUCED TO 6 INCHES FOR VACUUM—TYPE SEWERS OR GRAVITY SEWERS WHERE THE SEWER PIPE IS BELOW THE WATER MAIN. THE CROSSING SHALL BE ARRANGED SO THAT ALL WATER MAIN JOINTS ARE AT LEAST 6 FEET FROM ALL JOINTS IN GRAVITY AND PRESSURE SEWER PIPES. THE DISTANCE CAN BE REDUCED TO 3 FEET FOR VACUUM—TYPE SEWERS. WHEN THE ABOVE SPECIFIED VERTICAL DISTANCE CRITERIA CANNOT BE MET DUE TO AN EXISTING UNDERGROUND FACILITY CONFLICT, SMALLER SEPARATIONS ARE ALLOWED IF:
 - A- THE SEWER PIPES ARE DESIGNED AND CONSTRUCTED EQUAL TO THE WATER PIPE AND PRESSURE TESTED AT 150 PSI.
- B- THE SEWER IS ENCASED IN A WATERTIGHT CARRIER PIPE OR CONCRETE.
- 3. IN HIGHLY CONGESTED AREAS, WHERE EITHER WATER OR SEWER FACILITIES ARE EXISTING AND THE SEPARATION REQUIREMENTS CANNOT BE MET, SPECIAL CONSIDERATION MAY BE GIVEN SUBJECT TO SUBMITTAL OF DOCUMENTATION SHOWING THAT THE PROPOSED ALTERNATIVE WILL RESULT IN AN EQUIVALENT LEVEL OF RELIABILITY AND PUBLIC HEALTH PROTECTION.
- 4. FORCE MAIN SEWERS CONSTRUCTED IN A PUBLIC WELLFIELD PROTECTION AREA SHALL BE EITHER DUCTILE IRON OR REINFORCED CONCRETE PRESSURE SEWER PIPES. FOR DUCTILE IRON PIPE EXFILTRATION RATE SHALL NOT BE GREATER THAN THE ALLOWABLE LEAKAGE RATE SPECIFIED IN AMERICA WATER WORKS ASSOCIATION STANDARD (AWWAS) C600-82 AT A TEST PRESSURE OF 100 PSI. FOR REINFORCED CONCRETE PRESSURE SANITARY SEWER EXFILTRATION RATE SHALL NOT BE GREATER THAN HALF (1/2) THE ALLOWABLE LEAKAGE RATE SPECIFIED IN AWWA C600-82 AT A TEST PRESSURE OF 100 PSI.
- THE CONTRACTOR SHALL VERIFY NATURE, DEPTH, AND CHARACTER OF EXISTING UNDERGROUND UTILITIES PRIOR TO START OF CONSTRUCTION.
- ALL OTHER PUBLIC OR PRIVATE UTILITY FACILITIES SHALL BE CONSTRUCTED AT LEAST 5 FEET FROM ANY WATER AND SEWER MAIN AS MEASURED FROM THE OUTSIDE BELL OF THE WATER OF THE UTILITY PIPE.
- 7. WHEN THE 5 FEET SEPARATION BETWEEN PROPOSED AND EXISTING LINE IS NOT POSSIBLE, THE CONTRACTOR SHALL HAND DIG OR EXPOSE THE WATER AND SEWER PIPES BEFORE PROCEEDING WITH POWER EQUIPMENT EXCAVATION.
- 8. IN NO CASE SHALL A CONTRACTOR INSTALL UTILITY PIPES, CONDUITS, CABLES, ETC. IN THE SAME TRENCH PARALLEL AND ABOVE AN EXISTING WATER OR SEWER PIPE EXCEPT WHERE THEY CROSS. ANY DEVIATION FROM NOTES 6, 7 AND 8 SHALL BE APPROVED IN WRITING BY THE RESPONSIBLE WATER AND SEWER UTILITY.

1 11/18/13 REVISED PER CITY COMMENTS MM NO. DATE REVISION BY

APPROVED BY: PETER A. KUNEN, P.E.

DATE

FLORIDA PROFESSIONAL ENGINEER NO. 60730

CRAIG A. SMITH & ASSOCIATES

CONSULTING ENGINEERS-PLANNERS-SURVEYORS

7777 GLADES ROAD, SUITE 410

BOCA RATON, FORIDA 33434


CERTIFICATE. NO. LB0003110


PREPARED FOR:
CITY OF
MARGATE
BROWARD COUNTY, FL


SANITARY FORCE MAIN INSTALLATION GENERAL NOTES FILE NAME: 03-1610-G-03-NOTE.dwg LAST SAVED: 12/26/13 - 2:23pm


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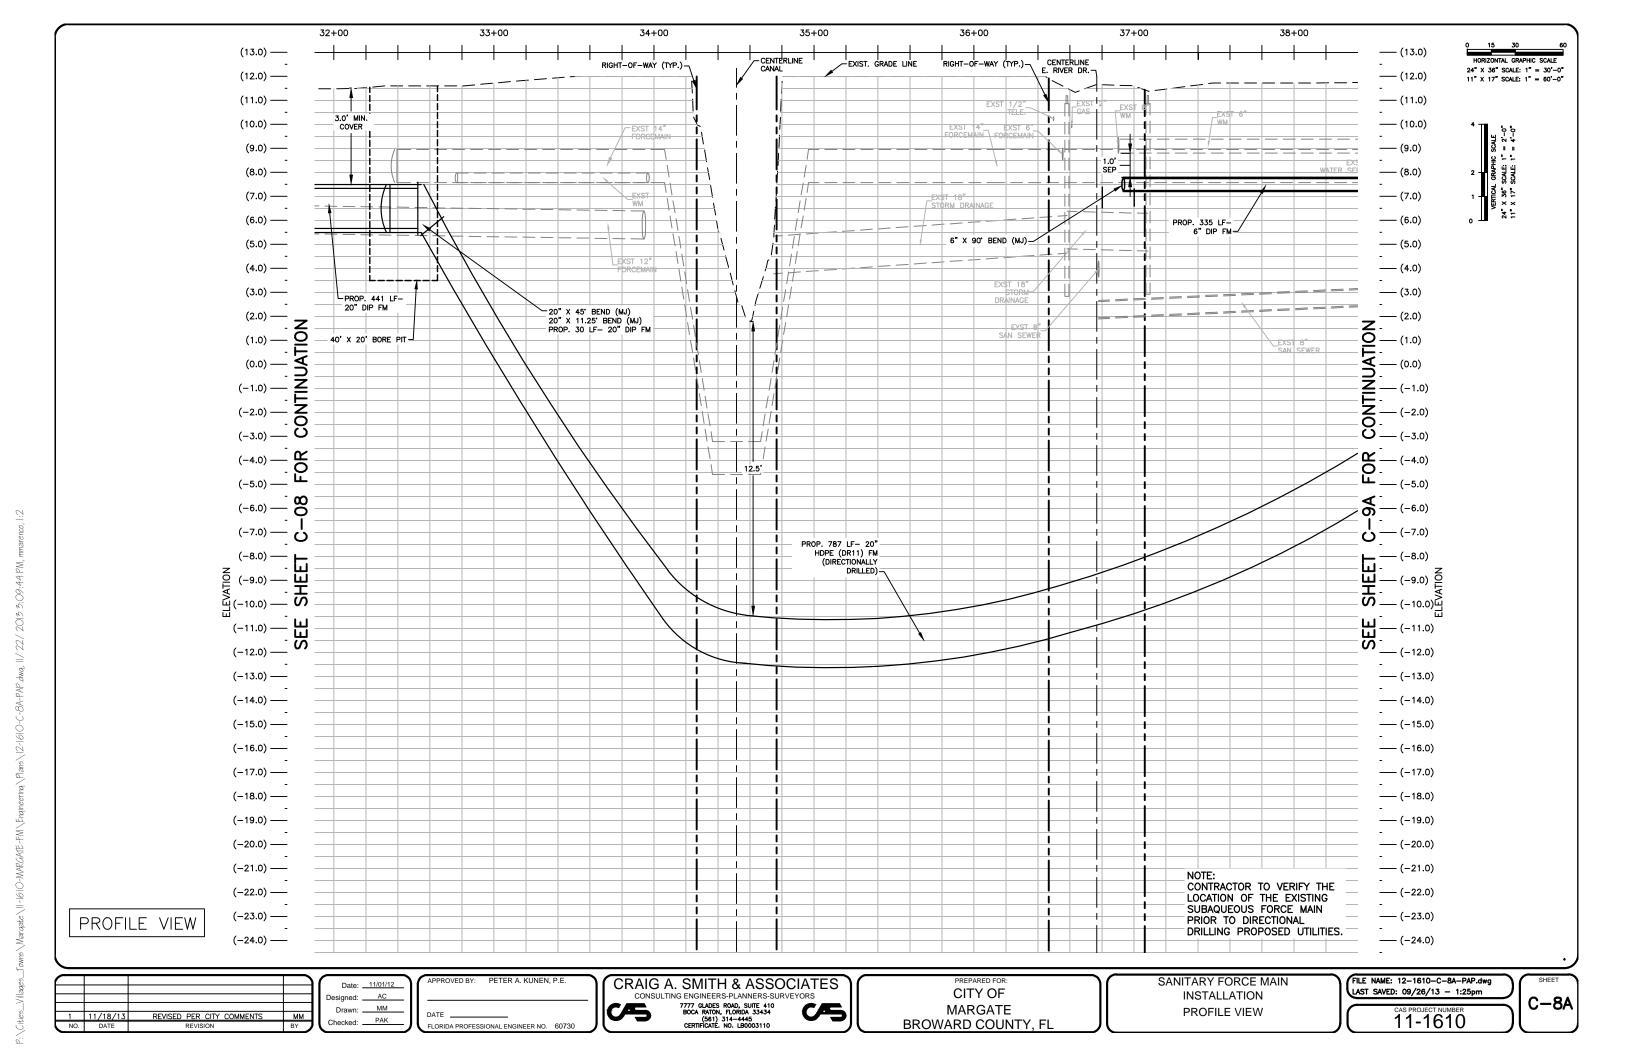
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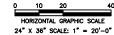




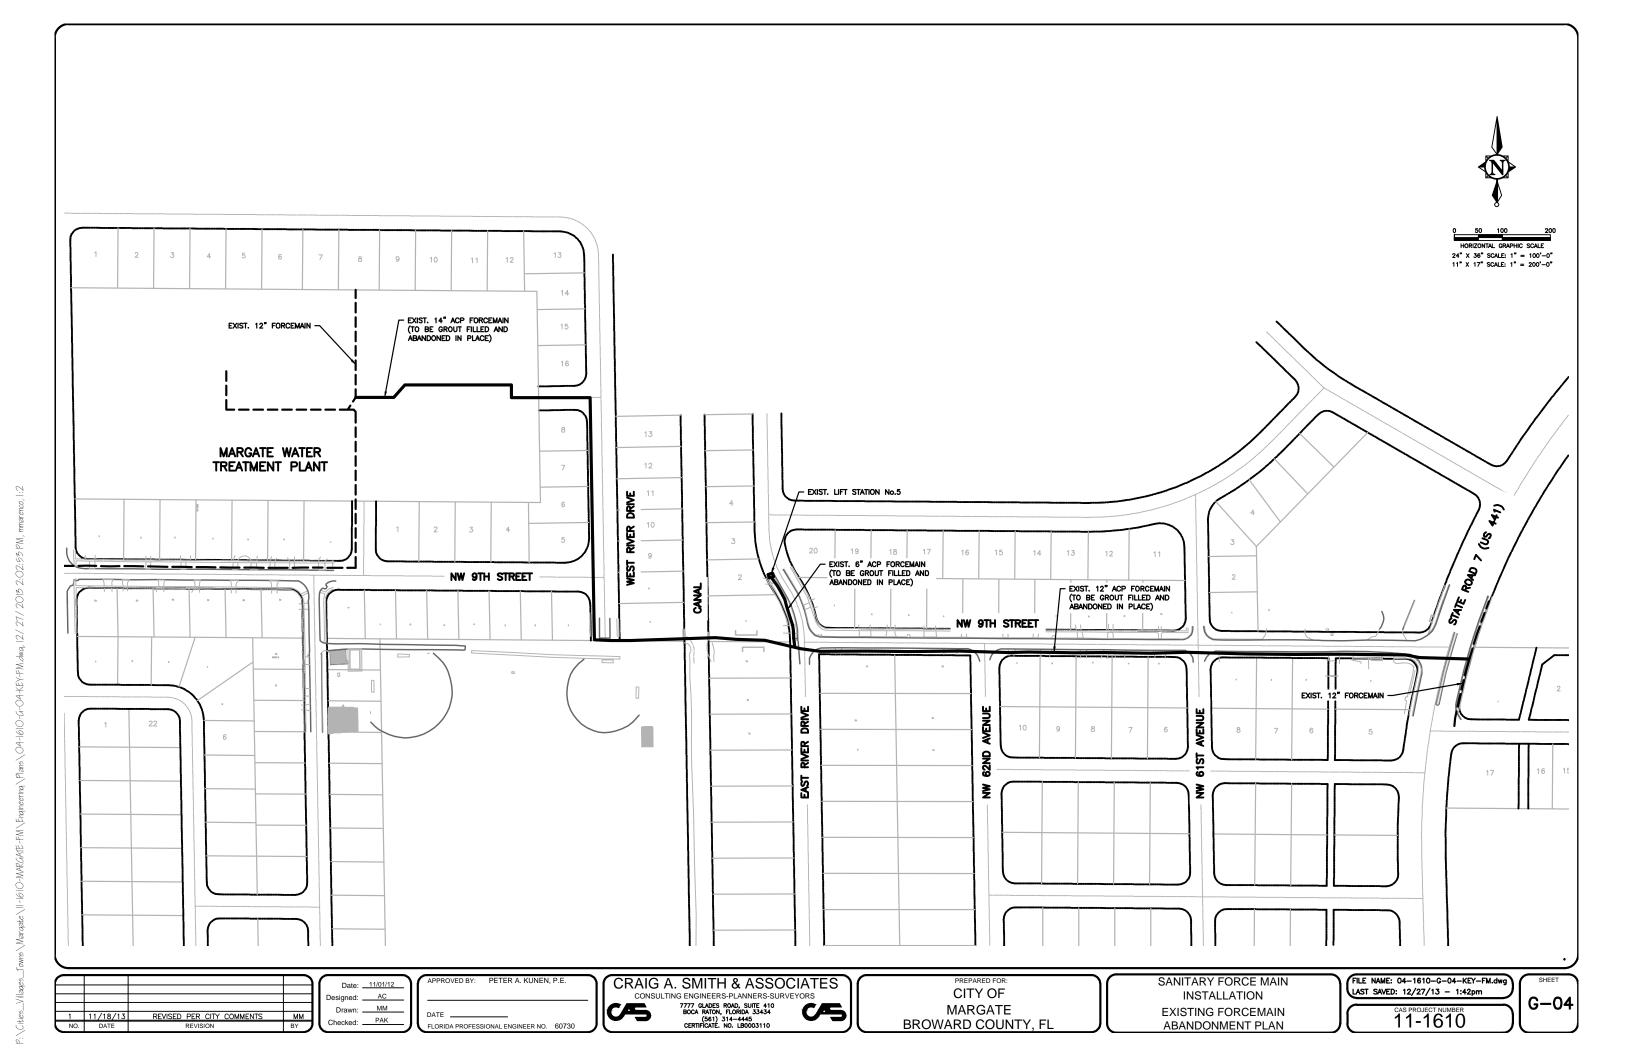

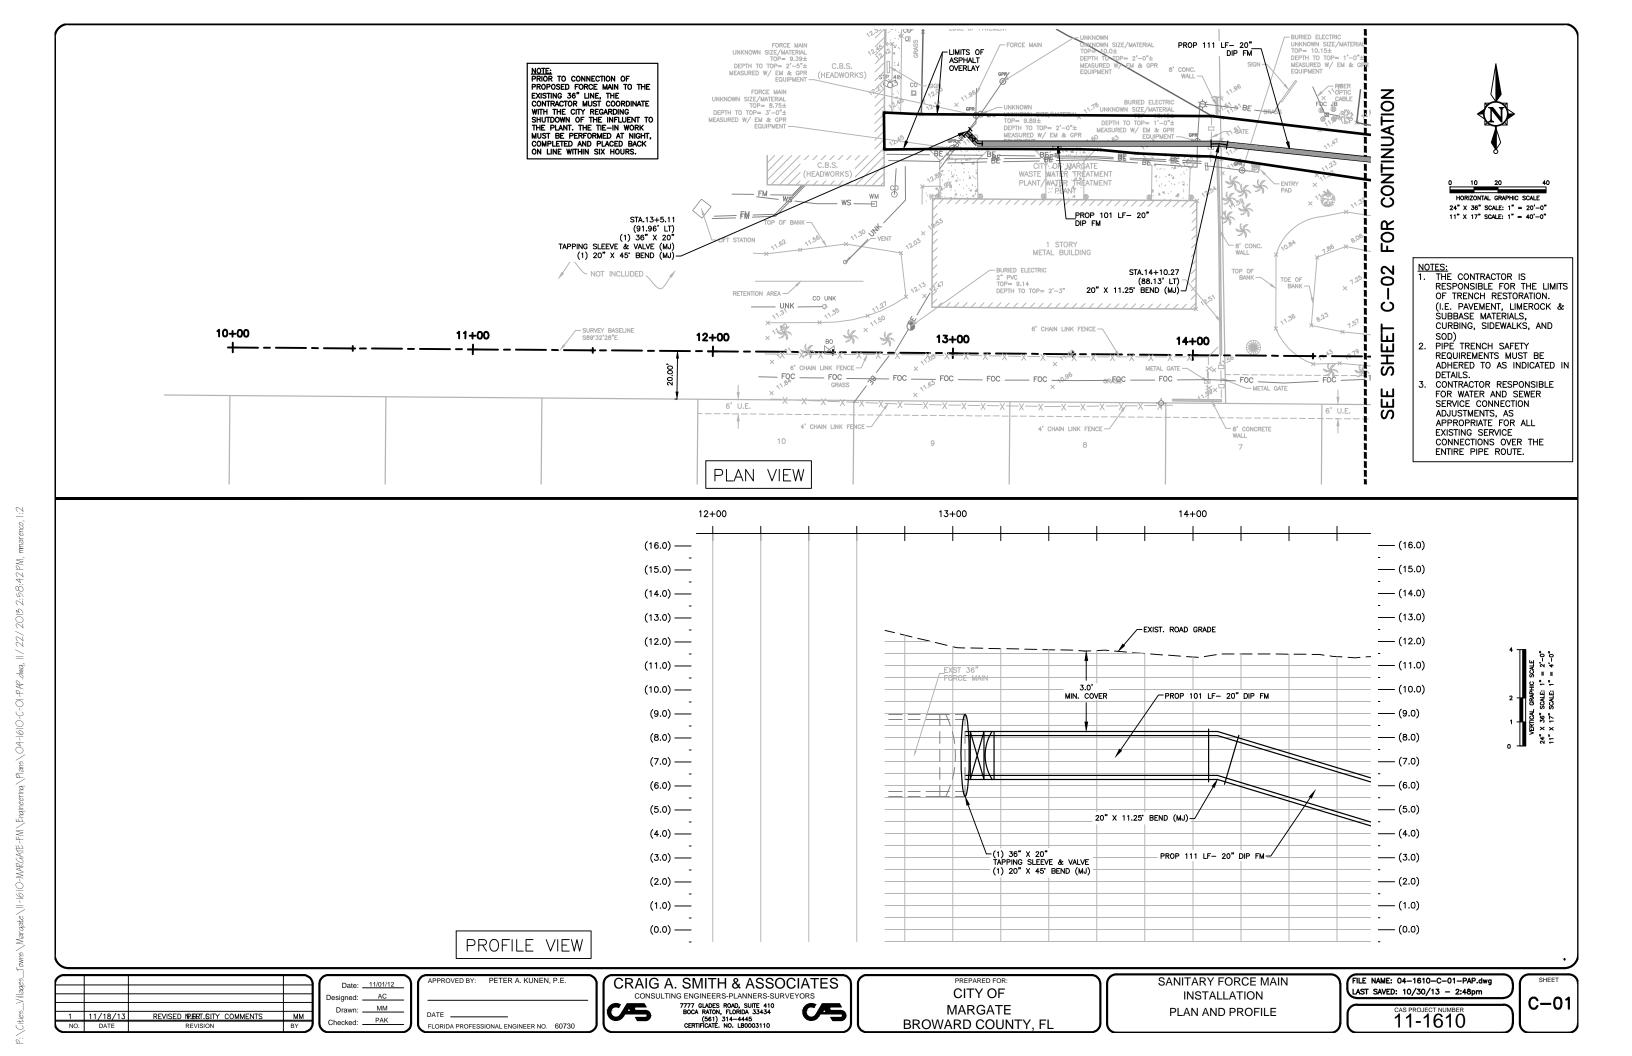

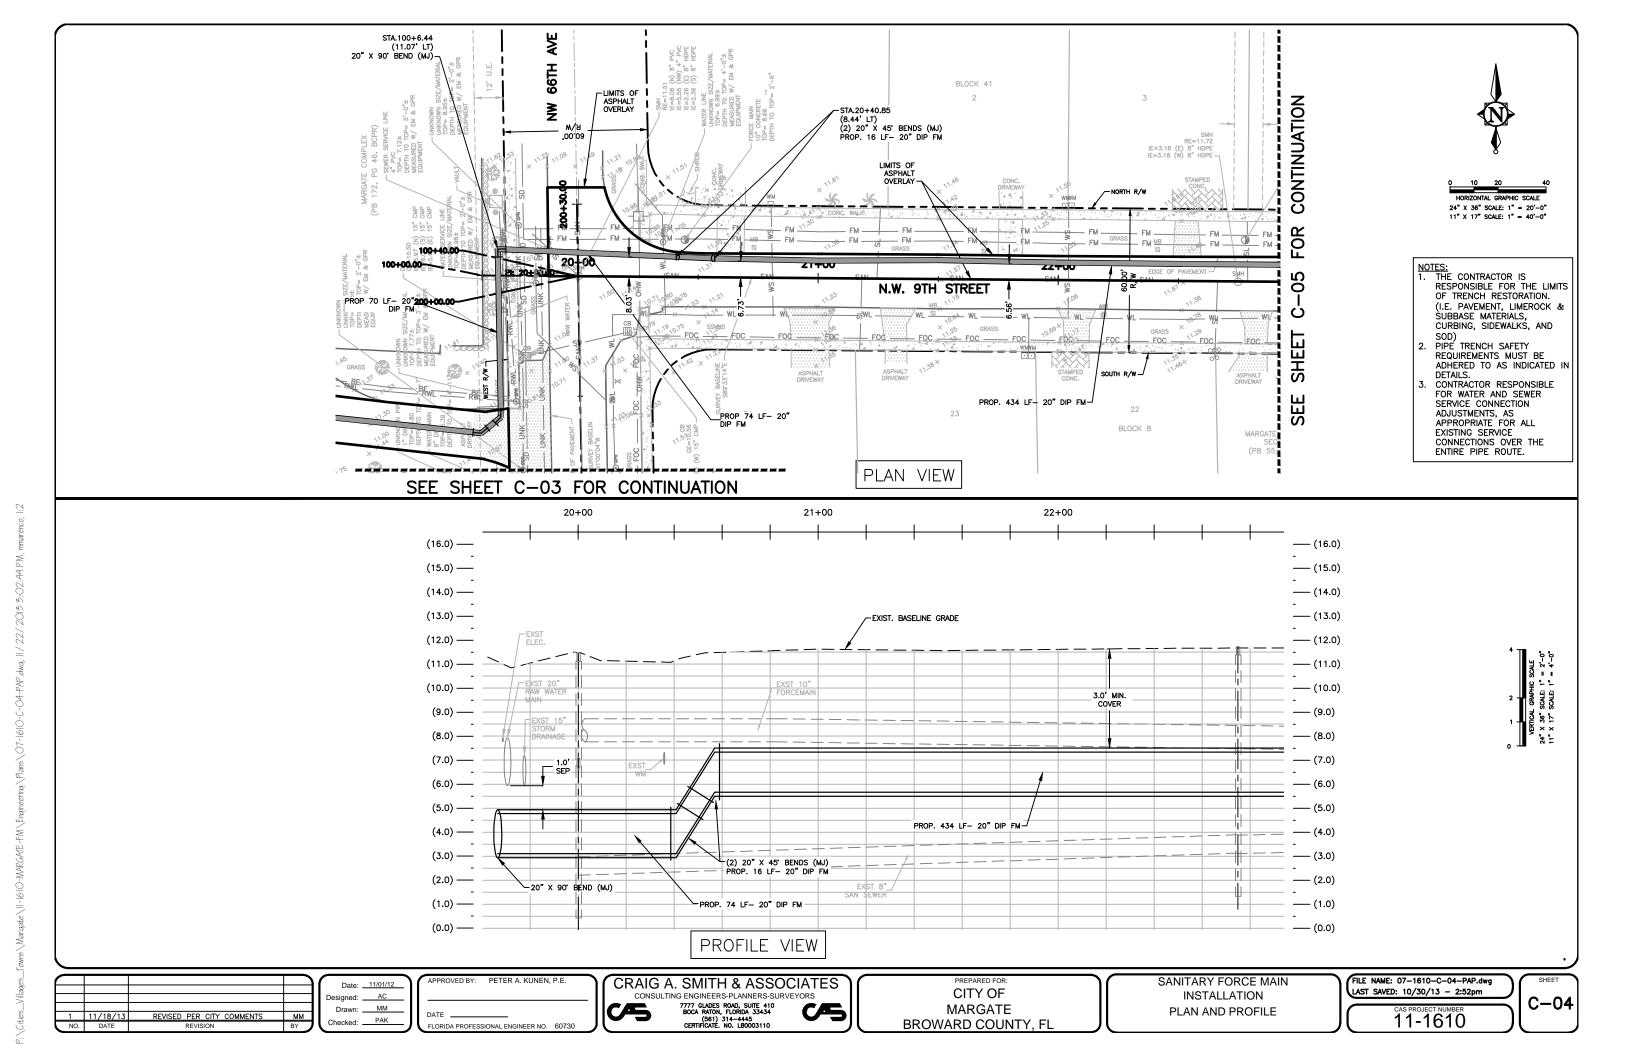

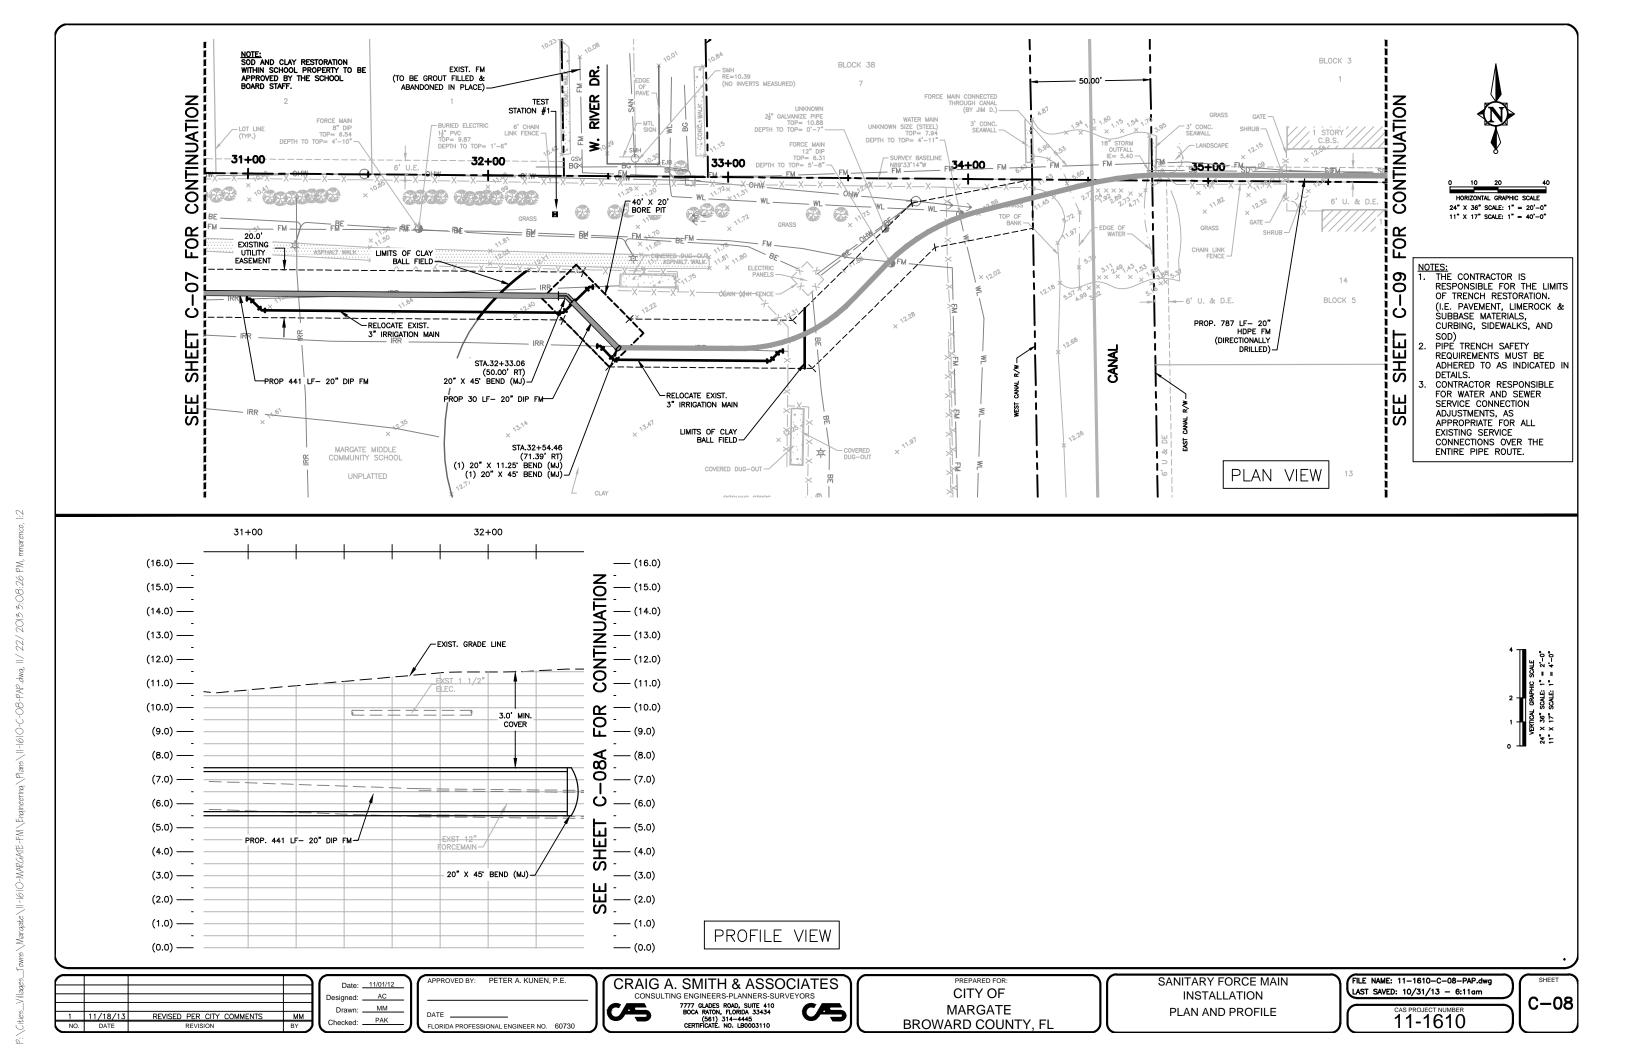


11" X 17" SCALE: 1" = 40'-0"

NOTES:

1. THE CONTRACTOR IS RESPONSIBLE FOR THE LIMITS OF TRENCH RESTORATION. (I.E. PAVEMENT, LIMEROCK & SUBBASE MATERIALS, CURBING, SIDEWALKS, AND SOD)
PIPE TRENCH SAFETY
REQUIREMENTS MUST BE

ADHERED TO AS INDICATED IN DETAILS.

CONTRACTOR RESPONSIBLE FOR WATER AND SEWER SERVICE CONNECTION
ADJUSTMENTS, AS
APPROPRIATE FOR ALL EXISTING SERVICE CONNECTIONS OVER THE ENTIRE PIPE ROUTE.

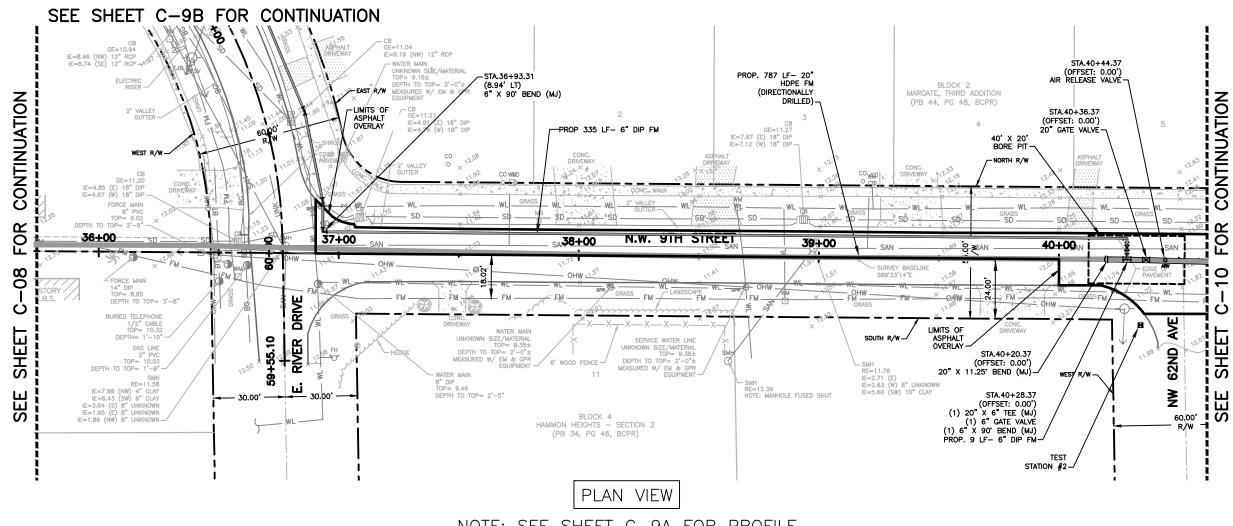

NOTE: SEE SHEET C-9A FOR PROFILE

REVISED PER CITY COMMENTS


APPROVED BY: PETER A KLINEN P.E Date: ___11/01/12 Designed: AC Drawn: MM Checked: PAK FLORIDA PROFESSIONAL ENGINEER NO. 60730 CRAIG A. SMITH & ASSOCIATES CONSULTING ENGINEERS-PLANNERS-SURVEYORS 7777 GLADES ROAD, SUITE 410 BOCA RATON, FLORIDA 33434 (561) 314-4445 CERTIFICATE. NO. LB0003110

CITY OF **MARGATE** BROWARD COUNTY, FL SANITARY FORCE MAIN INSTALLATION PLAN VIEW

FILE NAME: 13-1610-C-09-PAP.dwg LAST SAVED: 10/31/13 - 6:15am


11-1610

C-09

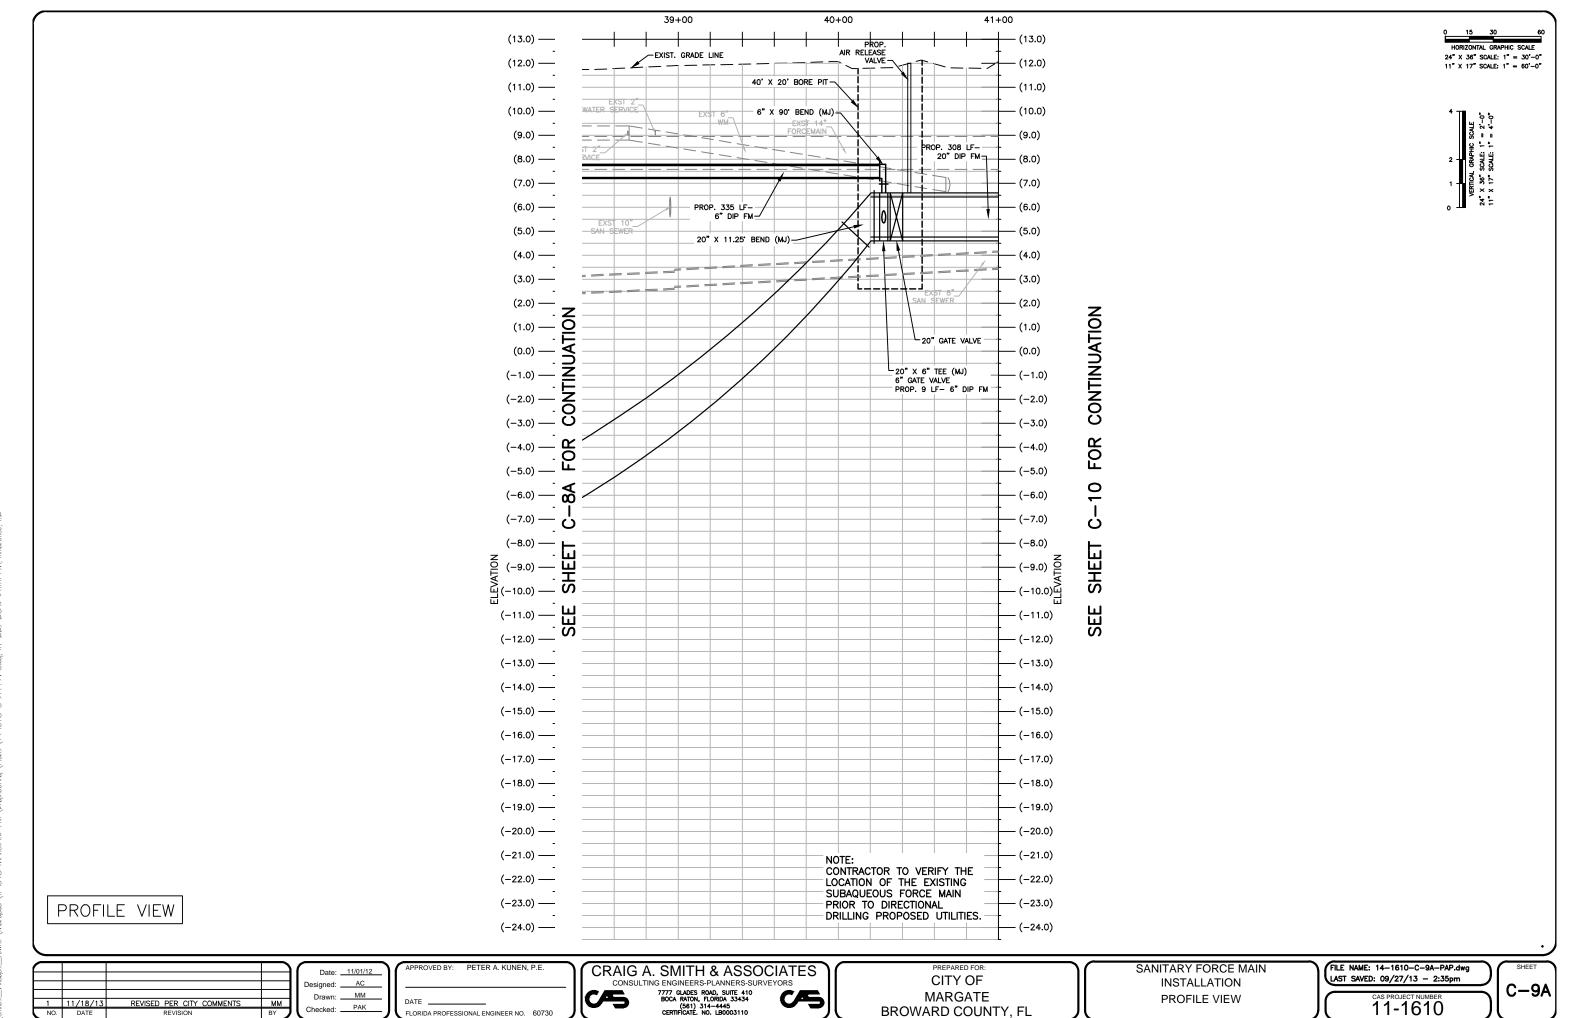



BROWARD COUNTY, FL

FLORIDA PROFESSIONAL ENGINEER NO. 60730

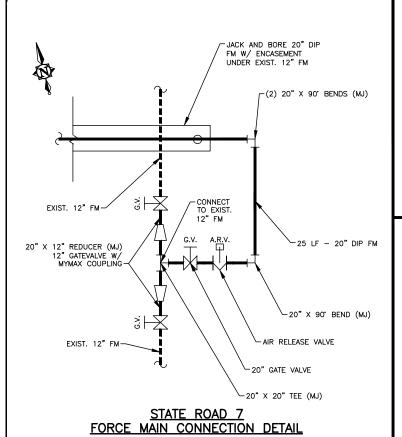


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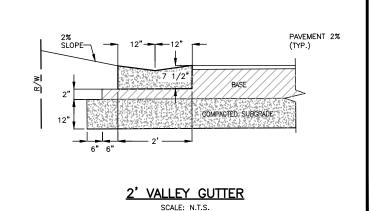


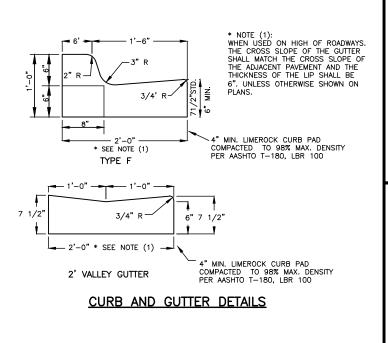

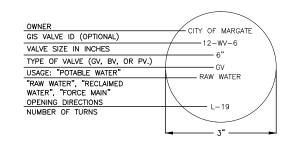
VALVE IDENTIFICATION MARKERS (TAG)

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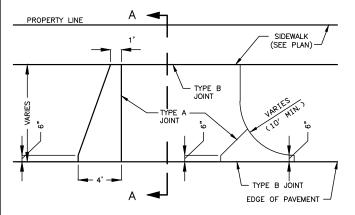


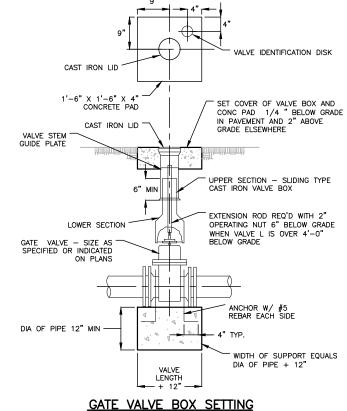


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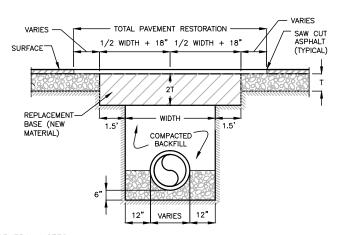


PIPE SEPARATION DETAIL SCALE: N.T.S.

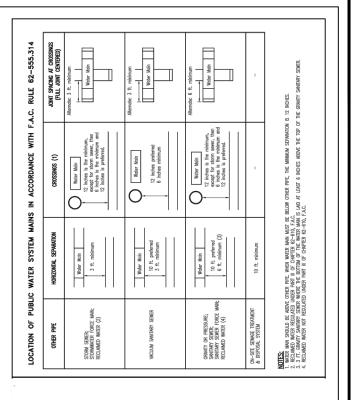

TYPICAL CONCRETE DRIVEWAY FLARE TYPE "T" (OR) FLARE TYPE "R"



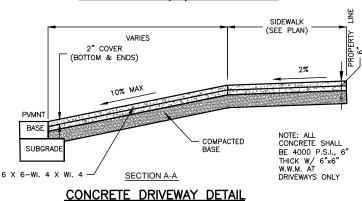


GENERAL NOTES:


- 1. REPLACED BASE MATERIAL OVER DITCH SHALL BE TWICE THE THICKNESS OF THE ORIGINAL BASE, MINIMUM 8", MAXIMUM 18".
- BASE MATERIAL SHALL BE PLACED IN 6" MAXIMUM (LOOSE MEASUREMENT) LAYERS AND EACH LAYER THOROUGHLY ROLLED OR TAMPED TO 98% OF MAXIMUM DENSITY, PER AASHTO T-180.
- 3. ASPHALT CONCRETE PAVEMENT JOINTS SHALL BE MECHANICALLY SAWED.
- 4. SURFACE MATERIAL SHALL BE CONSISTENT WITH THE SURROUNDING SURFACE MATERIAL.
- 5. BASE MATERIAL SHALL HAVE A MINIMUM LBR OF 100 AND A MINIMUM CARBONATE OF 70% (60% FOR LOCAL STREETS).
- 6. IF THE DITCH IS FILLED TEMPORARILY, IT SHALL BE COVERED WITH A 2" THICK ASPHALTIC CONCRETE PATCH TO KEEP THE FILL MATERIAL FROM RAVELING, UNTIL REPLACED WITH A PAVEMENT PATCH.
- RESTORE STREETS AND DRIVEWAYS WITH A MINIMUM OF 8 INCHES OF LIMEROCK BASE AND 1 1/2 INCHES OF TYPE S-3 ASPHALT.

PAVEMENT RESTORATION DETAIL

SCALE: N.T.S.

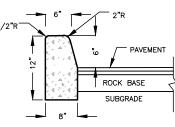

MODIFIED TYPE "D" CURB

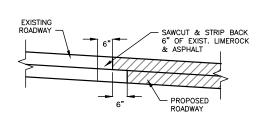

ASPHALT TIE-IN DETAIL

SCALE: N.T.S.

1	11/18/13	REVISED PER CITY COMMENTS	MM
NO.	DATE	REVISION	BY

Date: __11/01/12 Designed: ___ Drawn: MM Checked: PAK


APPROVED BY: PETER A. KUNEN, P.E FLORIDA PROFESSIONAL ENGINEER NO. 60730

CRAIG A. SMITH & ASSOCIATES CONSULTING ENGINEERS-PLANNERS-SURVEYORS 7777 GLADES ROAD, SUITE 410 BOCA RATON, FLORIDA 33434 (561) 314-4445 CERTIFICATE, NO. LB0003110

CITY OF **MARGATE** BROWARD COUNTY, FL SANITARY FORCE MAIN INSTALLATION STANDARD DETAILS

FILE NAME: 18-1610-C-12-DTLS.dwg LAST SAVED: 12/26/13 - 11:23am

11-1610

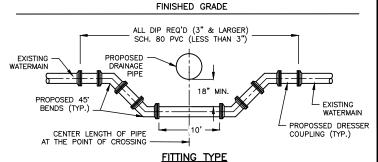

CONFLIC SEE NOTE NO. 4 FOR CENTER A FULL LENGTH OF PIPE AT POINT OF CROSSING ACCEPTABLE DEFLECTION SLOPE UP TO

NOTES:


1. STORM SEWERS CROSSING UNDER WATER MAINS SHALL BE LAID TO PROVIDE A MIN. VERTICAL DISTANCE OF EIGHTEEN (18) INCHES BETWEEN THE INVERT OF THE UPPER PIPE AND THE CROWN OF THE LOWER PIPE. WHERE THIS MIN. SEPARATION CANNOT BE MAINTAINED, THE CROSSING SHALL BE ARRANGED OF THAT THE SEWER PIPE JOINTS AND WATER MAIN JOINTS ARE EQUIDISTANT AND FROM THE POINT OF CROSSING WITH NO LESS THAN TEN (10) FEET BETWEEN ANY TWO JOINTS AND BOTH PIPES SHALL BE D.I.P. WHERE THERE IS NO ALTERNATIVE TO SEWER PIPES CROSSING OVER A WATER MAIN. THE CRITERIA FOR MIN. SEPARATION BETWEEN LINES AND JOINTS IN THE ABOVE SHALL BE REQUIRED AND BOTH PIPES SHALL BE D.I.P. IRRESPECTIVE OF SEPARATION. D.I.P. IS NOT REQUIRED FOR STORM SEVER.

DEFLECTION TYPE

- 2. MAINTAIN TEN (10) FEET HORIZONTAL DISTANCE BETWEEN WATER MAIN AND STORM SEWER, AS MINIMUM.
- 3. FITTINGS SHALL BE RESTRAINED WITH MEGALUG SERIES 1100 AS MANUFACTURED BY EBAA IRON INC. OR APPROVED EQUAL.
- 4. THE DEFLECTION TYPE CROSSING IS PREFERED
- 5. DO NOT EXCEED 75% OF MANUFACTURER'S RECOMMENDED MAX, JOINT DEFLECTION.
- 6. ALL EXPOSED TIE RODS/ STEEL SHALL BE COATED w/ COAL-TAR EXPOXY

TYPICAL UTILITY CROSSING

SCALE: N.T.S.

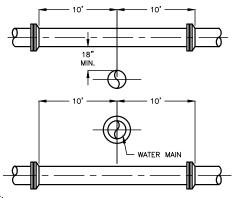

NOTES:

MORTAR AS REQUIRED-

GRADE (ROADWAY)

ADJUST TO GRADE — WITH MIN. OF 2 & MAX. OF 5 COURSES

APCO No. 200A (O.A.E.) AIR RELEASE VALVE

2" STAINLESS STEEL

PROVIDE OFFSET CUT-OUT FOR MAIN

2" STAINLESS STEEL

DOUBLE STRAP SERVICE SADDLE*

3/4" GRAVEL OR DRAIN ROCK

NIPPLES *


- A WATER MAIN SHOULD CROSS OVER PIPES WHEREVER POSSIBLE MAINTAINING A 36 INCH COVER FOR PVC, 30 INCH COVER FOR D.I.P. AND 18 INCH SEPARATION AS MINIMUMS.
- 2. WHEREVER A WATER MAIN CROSSES UNDER A SEWER MAIN, OR CROSSES OVER WITH LESS THAN 18 INCHES VERTICAL SEPARATION, THEN D.I.P. SHALL BE USED FOR BOTH PIPES FOR A DISTANCE OF 20 CENTERED ON CROSSING WITH NO JOINTS WITHIN 10 FEET OF
- 3. 18 INCH SEPARATION SHOULD BE MAINTAINED BETWEEN ALL PIPES (STORM, SEWER, WATER) WHENEVER POSSIBLE. 12 INCHES IS THE ABSOLUTE MINIMUM SEPARATION WITH D.I.P. REQUIRED FOR ANY SEPARATION LESS THAN 18 INCHES.
- 4. MAINTAIN 10 FEET HORIZONTAL SEPARATION BETWEEN WATER AND SEWER AS A MINIMUM.
- 5. 3 FOOT HORIZONTAL CLEARANCE SHALL BE PROVIDED BETWEEN UTILITIES AND ANY OBSTRUCTIONS (CATCH BASINS, CONCRETE POLES,
- 6. 5 FOOT HORIZONTAL CLEARANCE SHALL BE PROVIDED BETWEEN UTILITIES AND TREES.


UTILITY CROSSING GENERAL REQUIREMENTS

SCALE: N.T.S.

NOTES:

AIR RELEASE VALVE

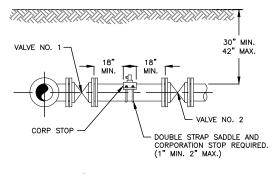

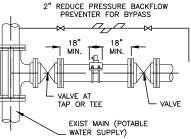

NOTES:

12"

O D

- 1. BOTH VALVES SHALL BE KEPT CLOSED EXCEPT FOR FILLING,
- FLUSHING AND BACTERIOLOGICAL TESTING PURPOSES. THE CORPORATION STOP MAY BE USED FOR FEEDING CHLORINE SOLUTIONS, AND FOR VENTING DURING PRESSURE/LEAKAGE TESTS. THE OUA SHALL BE NOTIFIED BEFORE FILLING AND FLUSHING. VALVES ON
- 3. EXISTING SYSTEM SHALL BE OPERATED ONLY BY OUA PERSONNEL. AFTER BACTERIOLOGICAL CLEARANCE, VALVE NO. 2 IS TO BE
- 4. LEFT OPEN WITHOUT A VALVE BOX. PRESSURE TEST PUMP CONNECTS TO SERVICE LINE OR BLOWOFF.
- 5. NO EXTRA TAPS ARE PERMITTED UNLESS APPROVAL HAS BEEN BY THE OUA

DOUBLE VALVE DETAIL

SCALE: N.T.S.

(P.V.C.) (D.I.P.) FINISHED PAVEMENT GRADE BACKFILL, NOT LARGER THAN N N 3" DIAMETER PLACED IN 6" LAYERS COMPACTED WITH 24" 18" MECHANICAL VIBRATION TO 100% COMPACTION


BACKELL NOT LARGER THAN 1" PLACED IN 6" LAYERS & THOROUGHLY TAMPED TO 98% COMPACTION 3/4" CRUSHED STONE CRADLE MANUALLY


EXCAVATE 6" MIN MAX. WATER LEVEL PERMITTED DURING UNDISTURBED STABLE ROCK OR MATERIAL CONSTRUCTION

NOTE:

- 1. MAXIMUM DENSITY DETERMINED BY AASHTO
- 2. MAXIMUM DEPTH TO BOTTOM OF PRESSURE MAINS SHALL NOT EXCEED SIX (6) FEET UNLESS OTHERWISE APPROVED BY THE ENGINEER.
- CONTRACTOR TO COMPLY WITH OSHA TRENCH SAFETY REQUIREMENTS.

TYPICAL TRENCH

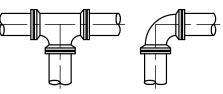

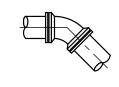

TEE & WYE 90° BEND

	RESTRAINED PIPE LENGTH (LINEAL FEET)				
PIPE SIZE	TEE & WYE	90.BEND	45°BEND	22 1/2 BEND	11 1/4 BEND
6"	27	27	16	9	5
8"	34	34	20	11	6
10"	41	41	24	14	7
12"	48	48	28	16	8
14"	55	55	32	18	10
16"	62	62	35	20	11
18 "	69	69	39	22	12
20"	75	75	42	24	13
24"	87	87	49	27	14
30"	104	104	57	31	17
36"	120	120	65	35	19
42"	134	134	72	39	21
48"	147	147	79	42	22
54"	160	160	85	45	24

THE FIGURES IN THIS TABLE ARE BASED ON 150 PSI TEST PRESSURE WITH 2.5 FEET OF COVER AND 2000 POUNDS PER SQUARE FOOT SOIL BEARING AGAINST UNDISTURBED TRENCH. A 20% SAFETY FACTOR HAS BEEN ADDED.

RESTRAINED JOINT DETAIL

STANDARD SEPARATION STATEMENT

SANITARY SEWERS, FORCEMAINS, SEWER LATERALS SHOULD ALWAYS CROSS UNDER WATER MAINS OR WATER SERVICES WHENEVER POSSIBLE.
SANITARY SEWERS, FORCE MAINS, SEWER LATERALS CROSSING WATER MAINS
SHALL BE LAID TO PROVIDE A MINIMUM VERTICAL DISTANCE OF 18 INCHES BETWEEN THE INVERT OF THE UPPER PIPE AND THE CROWN OF THE LOWER PIPE

WHERE SANITARY SEWERS, FORCEMAINS, SEWER LATERALS AND STORM SEWERS MUST CROSS A WATERMAIN WITH LESS THAN 18 INCHES VERTICAL DISTANCE, BOTH THE SEWER AND THE WATER MAIN SHALL BE CONSTRUCTED OF DUCTILE IRON PIPE (DIP) AT THE CROSSING, (DIP IS NOT REQUIRED FOR STORM SEWERS). SUFFICIENT LENGTHS OF DIP MUST BE USED TO PROVIDE A MINIMUM SEPARATION OF 10 FEET BETWEEN ANY TWO JOINTS. ALL JOINTS ON THE WATER MAIN WITHIN 20 FEET OF THE CROSSING MUST BE MECHANICALLY RESTRAINED. A MINIMUM VERTICAL CLEARANCE OF 6 INCHES MUST BE

ALL CROSSINGS SHALL BE ARRANGED SO THAT THE SEWER PIPE JOINTS AND THE WATERMAIN PIPE JOINTS ARE EQUIDISTANT FROM THE POINT OF CROSSING (PIPES CENTERED ON THE CROSSING).


WHERE A NEW PIPE CONFLICTS WITH AN EXISTING PIPE WITH LESS THAN 18" VERTICAL CLEARANCE, THE NEW PIPE SHALL BE CONSTRUCTED OF DIP (EXCEPT STORM SEWERS) AND THE NEW PIPE SHALL BE ARRANGED TO MEET THE CROSSING REQUIREMENTS ABOVE.

A MINIMUM 10-FOOT HORIZONTAL SEPARATION SHALL BE MAINTAINED BETWEEN ANY TYPE OF SEWER AND WATER MAIN IN PARALLEL INSTALLATIONS WHENEVER

IN CASES WHERE IT IS NOT POSSIBLE TO MAINTAIN A 10-FOOT HORIZONTAL SEPARATION, THE WATER MAIN MUST BE LAID IN A SEPARATE TRENCH OR ON AN UNDISTURBED EARTH SHELF LOCATED ON ONE SIDE OF THE SEWER OR FORCE MAIN AT SUCH AN ELEVATION THAT THE BOTTOM OF THE WATER MAIN IS AT LEAST 18 INCHES ABOVE THE TOP OF THE SEWER.

IT IS NOT POSSIBLE TO MAINTAIN A VERTICAL DISTANCE OF 18 INCHES IN PARALLEL INSTALLATIONS, THE WATER MAIN SHALL BE CONSTRUCTED OF DIP AND THE SEWER OR THE FORCE MAIN SHALL BE CONSTRUCTED OF DIP (EXCEPT STORM SEWERS) WITH A MINIMUM VERTICAL DISTANCE OF 6 INCHES. THE WATER MAIN SHOULD ALWAYS BE ABOVE THE SEWER. JOINTS ON THE WATER MAIN SHALL BE LOCATED AS FAR APART AS POSSIBLE FROM JOINTS ON THE SEWER OR FORCE MAIN (STAGGERED JOINTS).

MAXIMUM OBTAINABLE SEPARATION OF DOMESTIC WATER LINES SHALL BE PRACTICED. A MINIMUM HORIZONTAL SEPARATION OF FIVE FEET (CENTER TO CENTER) OR THREE FEET (OUTSIDE TO OUTSIDE), SHALL BE MAINTAINED BETWEEN RECLAIMED WATER LINES AND POTABLE WATER MAINS AND BETWEEN SEWAGE RECLAIMED WATER LINES AND COLLECTION LINES. A MINIMUM VERTICAL CLEARANCE OF 18 INCHES MUST BE MAINTAINED BETWEEN RECLAIMED WATER LINE AND POTABLE WATER MAINS OR SEWAGE COLLECTION LINES AND SEWER LATERALS. AT CROSSINGS PROVISIONS OF F.A.C. RULE 17-604 AND 10 STATE STANDARDS APPLY.

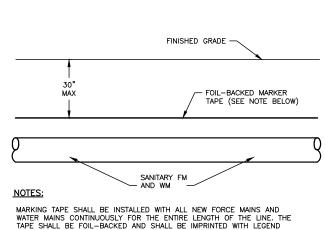

APPROPRIATE TO THE PIPELINE. THE TAPE MUST CONFORM TO THOR'S Magnatec DETECTABLE WARNING TAPE, OR AN APPROVED EQUAL. MINIMUM WIDTH SHALL BE 6" AND THE MAXIMUM DEPTH OF BURIAL SHALL BE 30". COST OF MARKER TAPE SHALL BE INCLUDED IN THE LINEAL FOOT PRICE OF THE PIPE BID. WATER MAIN PIPING TO BE COLOR CODED BLUE. FORCE MAIN PIPING TO BE COLOR CODED GREEN.

MARKER TAPE DETAIL

SCALE: N.T.S.

Designed: __ Drawn: __ Checked: PAK

APPROVED BY: PETER A KLINEN P.E. Date: __11/01/12

CONSULTING ENGINEERS-PLANNERS-SURVEYORS 7777 GLADES ROAD, SUITE 410 BOCA RATON, FLORIDA 33434 (561) 314-4445 CERTIFICATE, NO. LB0003110

CITY OF **MARGATE** BROWARD COUNTY, FL SANITARY FORCE MAIN INSTALLATION STANDARD DETAILS

FILE NAME: 19-1610-C-13-DTLS.dwg LAST SAVED: 11/06/13 - 1:46pm

11-1610

REVISED PER CITY COMMENTS ММ

MM FLORIDA PROFESSIONAL ENGINEER NO. 60730 CRAIG A. SMITH & ASSOCIATES

IRON MANHOLE FRAME & COVER

TOP SLAB SHALL HAVE H-20 LOADING MINIMUM

-1/2" GALVANIZED PIPE AND FITTINGS

2" BRASS CORPORATION

STOP (MIN.)

INSIDE DIAMETER OF MANHOLE SHALL BE 6'-0" IF FORCE MAIN IS LARGER THAN

2. PRECAST CONCRETE MANHOLE ENCLOSURE WITH DOGHOUSE TYPE OPENINGS AND NO BOTTOM.

3. ACTUAL LOCATION OF MANHOLE SHALL BE DETERMINED BY ENGINEER IN THE FIELD.


4. * FITTINGS MAY BE 1" FOR WATER MAIN


-CONCRETE WALLS (6" MIN.)
AND FOOTING PER ASTM

U.S. FOUNDRY & MFG. No 580 WITH VENTED LID

2" MIN.



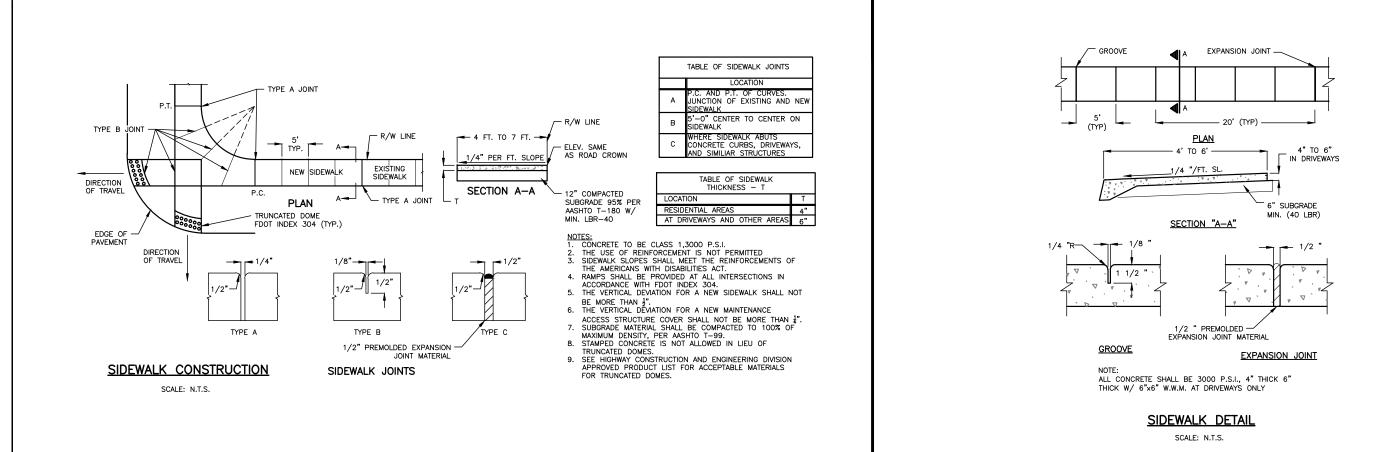

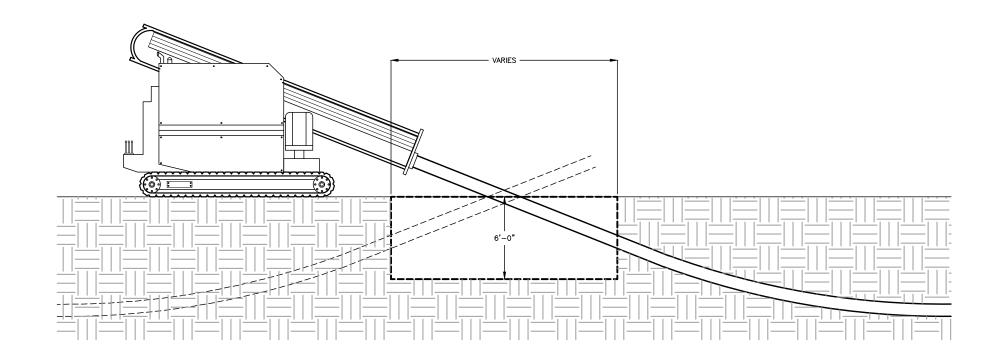

BORE PIT DETAIL SCALE: N.T.S.

REVISED PER CITY COMMENTS


Date: ___11/01/12 Designed: AC Drawn: MM Checked: PAK

APPROVED BY: PETER A, KUNEN, P.E. FLORIDA PROFESSIONAL ENGINEER NO. 60730 CRAIG A. SMITH & ASSOCIATES CONSULTING ENGINEERS-PLANNERS-SURVEYORS 7777 GLADES ROAD, SUITE 410 BOCA RATON, FLORIDA 33434 (561) 314-4445 CERTIFICATE. NO. LB0003110

CITY OF MARGATE BROWARD COUNTY, FL SANITARY FORCE MAIN INSTALLATION STANDARD DETAILS


FILE NAME: 20-1610-C-14-DTLS.dwg LAST SAVED: 11/05/13 - 3:04pm

11-1610

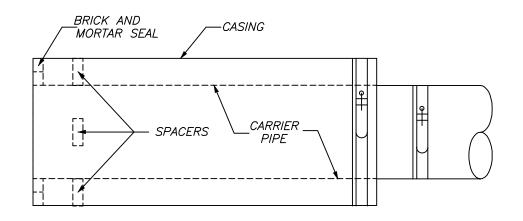

CASING SEAL DETAIL

N.T.S.

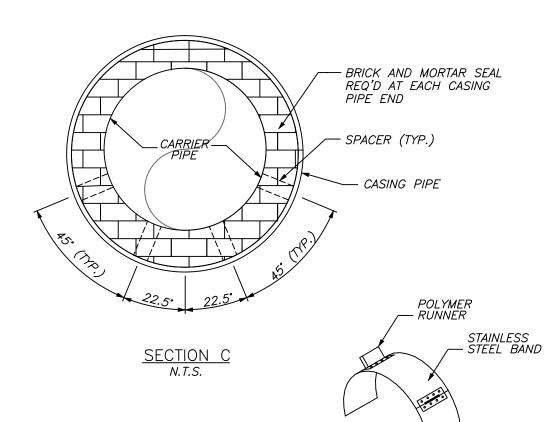


CASING SPACERS DETAIL N.T.S.

SPECIFICATIONS FOR CARRIER AND CASING PIPES						
CARRIER PIPE CASING PIPE						
CONTENTS TO BE HANDLED	WATER	NONE				
OUTSIDE DIAMETER	DETERMINED BY PROJECT	SEE TABLE SHEET DTL-2				
PIPE MATERIAL	D.I.P.	STEEL				
SPECIFICATION AND GRADE	SEE NOTE No. 9	A.S.T.M. A 139, GRADE "B"				
WALL THICKNESS	DETERMINED BY MFG.	SEE TABLE SHEET DTL-2				
WORKING PRESSURE	150 P.S.I.	NONE				
TYPE OF JOINT	RESTRAINED MECH. JT.	WELDED				
COATING	BLACK BITUMINOUS	BLACK BITUMINOUS				
METHOD OF INSTALLATION	CASING SPACERS	BORE AND JACK				
PROTECTION AT ENDS OF CASING	N/A	BRICK AND MORTAR OR CASING END SEAL				

CARRIER PIPE SIZE	OUTSIDE DIAM. MECH. JOINT	NOMINAL DIAM. OF STEEL CASING PIPE	MINIMUM CASING THICKNESS
4"	9.56"	12"	0.375"
6"	11.12"	14"	0.375"
8"	13.37"	16"	0.375"
10"	15.62"	20"	0.375"
12"	17.88"	24"	0.375"
14"	20.25"	24"	0.375"
16"	22.50"	30"	0.375*
18"	24.75"	34"	0.375*
20"	27.00"	36"	0.375"
24"	31.50"	42"	0.500"
30"	39.12"	42"	0.500"
36"	46.00"	48"	0.500"
42"	53.12"	54"	0.500*
48"	60.00"	72"	0.500*

* NOTE:

CONTRACTOR SHALL EXCAVATE BORING PIT AS NEEDED. THE WIDTH OF THE BORE PIT SHOULD BE BETWEEN 8 AND 12 FEET. THE LENGTH OF THE PIT DEPENDS ON THE AUGER AND LENGTH OF CASING USED. THE BORE PITS SHOULD BE BRACED AND SHORED APPROPRIATELY. THE UPPER 12" OF THE BOTTOM OF OF THE BORE PIT SHOULD BE OVER-EXCAVATED AND BACKFILLED WITH CRUSHED STONE (PREFERABLY #57 STONE) IN ORDER TO PROVIDE A WORKING PLATFORM AND SUPPORT TO THE EQUIPMENT.

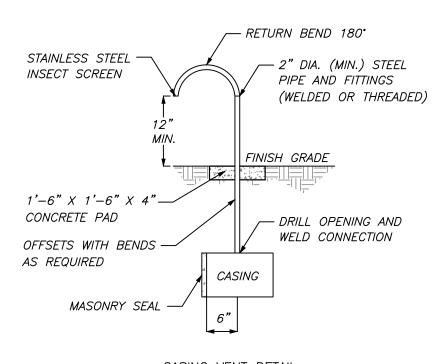

CASING VENT DETAIL N.T.S.

JACK & BORE - GENERAL NOTES

- 1. THE CONTRACTOR SHALL SUBMIT, FOR APPROVAL, TO THE ENGINEER AND THE GOVERNING AGENCY FOR THE RIGHT-OF-WAY, AND/OR OTHER AFFECTED AGENCIES HAVING JURISDICTION, COPIES OF PLANS SHOWING THE PROPOSED CONSTRUCTION METHODS AND MATERIALS PRIOR TO COMMENCING CONSTRUCTION. NO WORK SHALL BE DONE UNTIL THE CONTRACTOR HAS RECEIVED WRITTEN APPROVAL FROM ALL AGENCIES CONCERNED STATING THEIR CONCURRENCE IN THE PROPOSED CONSTRUCTION METHODS AND MATERIALS.
- 2. ALL CASING PIPE INSTALLATIONS SHALL REQUIRE A MANDATORY PRE—CONSTRUCTION CONFERENCE AT THE PROJECT SITE. THE PRECONSTRUCTION CONFERENCE ARRANGEMENTS SHALL BE MADE WITH THE ENGINEER OF RECORD, FLORIDA DEPARTMENT OF TRANSPORTATION (FDOT) AND THE CITY UTILITY DEPARTMENT AT LEAST ONE (1) WEEK PRIOR TO COMMENCEMENT OF CONSTRUCTION OPERATIONS FOR THE JACK AND BORE CROSSING THE RIGHT—OF—WAY.
- 3. ERECTION OR INSTALLATION OF APPROPRIATE SAFETY AND WARNING DEVICES SUCH AS BARRICADES AND LIGHTS SHALL BE REQUIRED AROUND ALL JACKING AND BORING PITS DURING THE COURSE OF CONSTRUCTION. SAID DEVICES SHALL BE IN ACCORDANCE WITH THE REQUIREMENTS OF THE STATE OF FDOT "MANUAL ON TRAFFIC CONTROL AND SAFE PRACTICES"
- 4. THE CONTRACTOR SHALL PROVIDE SUPPORT FOR CARRIER PIPE THROUGH THE CASING PIPE WITH STAINLESS STEEL CASING SPACERS WITH POLYMER RUNNERS AT 3 PER 20' LENGTH OF PIPE, CASCADE WATERWORKS MANUFACTURING CO. OR APPROVED EQUAL.
- 5. THE STEEL CASING PIPE SHALL CONFORM TO ASTM A-139 GRADE B LATEST REVISION.
- 6. THE CONTRACTOR SHALL VERIFY ALL DIMENSION, LOCATIONS AND ELEVATIONS OF EXISTING FACILITIES PRIOR TO CONSTRUCTION AND SHALL NOTIFY ALL UTILITY COMPANIES (BY USING SUNSHINE STATE ONE-CALL 1-800-432-4770) FOR LAYOUT OF EXISTING UNDERGROUND FACILITIES IN THE CONSTRUCTION AREA. LOCATION OF THE EXISTING UNDERGROUND FACILITIES ARE PLOTTED FROM ALL AVAILABLE RECORDS. THE ENGINEER ASSUMES NO RESPONSIBILITY FOR THE ACCURACY OF DATA SHOWN OR FOR LOCATION OF EXISTING UNDERGROUND SHOWN
- 7. THE OBJECTIVE OF USING THIS METHOD IS TO ENSURE NO UPHEAVAL, SETTLEMENT, CRACKING, MOVEMENT OR DISTORTION OF THE EXISTING GROUND SURFACE, ROADWAY PAVEMENT, ROADBED, UNDERGROUND UTILITIES OR STRUCTURES OF ANY TYPE. THE CONTRACTOR SHALL ADOPT ALL MEANS, IN ADDITION TO THOSE SPECIFIED, TO MEET THIS OBJECTIVE. THE CONTRACTOR SHALL BE RESPONSIBLE AND PAY FOR ANY AND ALL COSTS OF REPAIRS OR MAINTENANCE OF FDOT'S PROPERTY AND STRUCTURES DISTURBED OR DAMAGE DUE TO THE INSTALLATION OR CONSTRUCTION AFTER AFFECTS.
- 8. EXCAVATION, BACKFILLING, SHEETING AND BRACING, DEWATERING AND OTHER EARTHWORK ITEMS APPLICABLE TO JACKING AND BORING WITHIN STATE ROAD 7 (US 441) RIGHT-OF-WAY SHALL COMPLY WITH THE MINIMUM REQUIREMENTS OF FDOT AND THE CITY OF MARGATE UTILITY DEPARTMENT WHICH EVER IS MORE STRINGENT. THE BORE PIT SIZE WILL BE BASED ON THE AUGER AND THE SIZE OF THE CASING USED.
- DUCTILE IRON PIPE SHALL BE CLASS 52 FOR 4 AND 6 INCH DIAMETER, PRESSURE CLASS 250 FOR 20 INCH AND PRESSURE CLASS 350 FOR 10 INCH DIAMETER. ALL FITTINGS FOR PRESSURE PIPE SHALL BE INSTALLED WITH RESTRAINED JOINT COLLARS SUCH AS MEG-A-LUG BY EBBA IRON COMPANY, INC. OR APPROVED EQUAL.
- 10. PRIOR TO BACKFILLING THE JACKING AND BORING PIT, THE CONTRACTOR SHALL RETAIN THE SERVICES OF A SURVEYOR AT HIS EXPENSE, TO DETERMINE THE FINAL HORIZONTAL AND VERTICAL LOCATIONS OF THE DIRECTIONAL BORING CROSSING WITHIN THE STATE ROAD 7 (US 441) RIGHT-OF-WAY. RECORD DRAWINGS SIGNED AND SEALED BY A CURRENT VALID STATE OF FLORIDA PROFESSIONAL LAND SURVEYOR SHALL BE GIVEN TO THE ENGINEER OF RECORD. THE DISTANCE TO THE NEAREST MILE POST MARKER TO THE NORTH OF THE INSTALLED DIRECTIONAL BORING CROSSING SHALL BE SHOWN ON THE RECORD DRAWING.
- 11. ALL MATERIALS USED FOR INSTALLATIONS WITHIN THE STATE ROAD 7 (US 441)
 RIGHT-OF-WAY SHALL BE IN ACCORDANCE WITH FDOT MINIMUM STANDARDS.
- 12. THE CASING PIPE SHALL BE INSTALLED UNDER THE ENTIRE WIDTH OF THE PAVEMENT ON STATE ROAD 7 (US 441) BY JACKING AND BORING; CASING PIPE INSTALLATION BY OPEN-CUT METHOD THROUGH THE RIGHT-OF-WAY IS NOT ALLOWED.
- 13. ALL WORK DONE ON FDOT RIGHT-OF-WAY IS SUBJECT TO INSPECTION AND DIRECTION OF THEIR ENGINEER.
- 14. ALL WORK SHALL BE IN ACCORDANCE WITH CURRENT AWWA STANDARDS FOR PIPE LINES CONVEYING NONFLAMMABLE SUBSTANCES AND FOOT REQUIREMENTS AS PER UTILITY ACCOMMODATION GUIDE, JUNE 1993, DOCUMENT NO. 710-020-001-C. WHENEVER THERE IS A DIFFERENCE IN REQUIREMENTS THE MORE STRINGENT SHALL APPLY.
- 15. WELDING OF THE CASING PIPES SHALL CONFORM WITH AISC SPECIFICATIONS, SECTION 1-7-2. ALL FIELD JOINT WELDS SHALL ACHIEVE FULL PENETRATION, SINGLE-VEE GROOVE OR SINGLE-BEVEL GROOVE TYPE JOINTS.
- 16. THE CASING PIPE SHALL RECEIVE A BLACK BITUMINOUS COATING FOR PROTECTION AGAINST CORROSION IN ACCORDANCE WITH ASTM SPECIFICATION A139, LATEST.
- 17. THE CONTRACTOR SHALL CONTACT THE LOCAL LEVEL 3 OSP ENGINEER (954-218-6359) 48 HOURS PRIOR TO CONSTRUCTION.

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1	11/18/13	REVISED PER CITY COMMENTS	MM	Ш	
NO.	DATE	REVISION	BY	"	(

 CRAIG A. SMITH & ASSOCIATES
CONSULTING ENGINEERS-PLANNERS-SURVEYORS
7777 GLADES ROAD, SUITE 410
BOCA RATON, FLORIDA 33434
(561) 314-2445
CERTIFICATE. NO. LB0003110


PREPARED FOR:
CITY OF
MARGATE
BROWARD COUNTY, FL


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CAS PROJECT NUMBER 11-1610





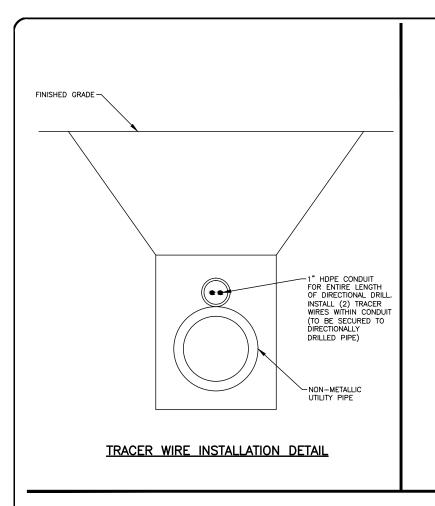


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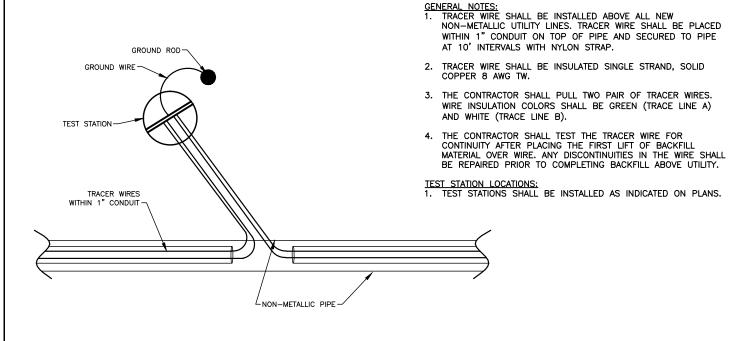
2. TEST STATION LID SHALL BE MARKED "TEST" OR "TEST STATION". TEST STATIONS SHALL BE ONE OF THE FOLLOWING PRODUCTS OR AN APPROVED

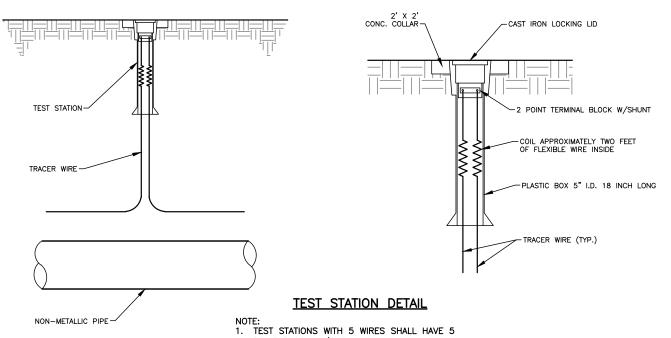FARWEST CORROSION CONTROL CO. 888-532-7937


3. A 10' GROUND ROD TO BE INSTALLED AT EACH TEST STATION AND GROUND WIRE TO BE CONNECTED TO TERMINAL.

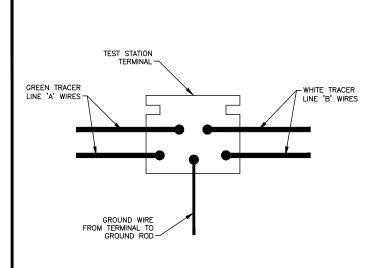

TRACER WIRE TERMINAL **CONNECTION DETAIL**



CONDUIT BUSHED NIPPLE SEALING GASKET PCP ENCLOSURE CONDUIT HUB CONNECTION DETAIL SCALE: N.T.S.

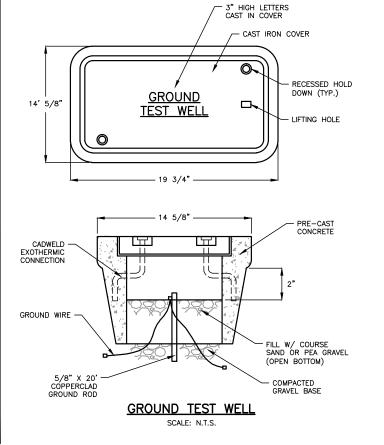

1	11/18/13	REVISED PER CITY COMMENTS	MM
NO.	DATE	REVISION	BY

Designed: ____AC Drawn: MM Checked: PAK

APPROVED BY: PETER A. KUNEN. P.E FLORIDA PROFESSIONAL ENGINEER NO. 60730

TYPICAL STATION DETAIL

CRAIG A. SMITH & ASSOCIATES CONSULTING ENGINEERS-PLANNERS-SURVEYORS 7777 GLADES ROAD, SUITE 410 BOCA RATON, FLORIDA 33434 (561) 314-4445 CERTIFICATE. NO. LB0003110

CITY OF MARGATE BROWARD COUNTY, FL SANITARY FORCE MAIN INSTALLATION STANDARD DETAILS

FILE NAME: 22-1610-C-16-DTLS.dwg LAST SAVED: 11/06/13 - 2:27pm

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