





CITY OF MARGATE / PARKS AND RECREATION DEPARTMENT 6199 NW 10th Street Margate, Florida 33063 Phone: 954.972.6458

AGENCY COMMISSION/COUNCIL


Joyce W. Bryan Tommy Ruzzano Lesa Peerman Joanne Simone Frank B. Talerico

Vice Mayor Commissioner Commissioner Commissioner

MARGATE DOG PARK

CITY OF MARGATE, FLORIDA **65% CONSTRUCTION DOCUMENTS**

DATE OF ISSUE: 2016-10-18

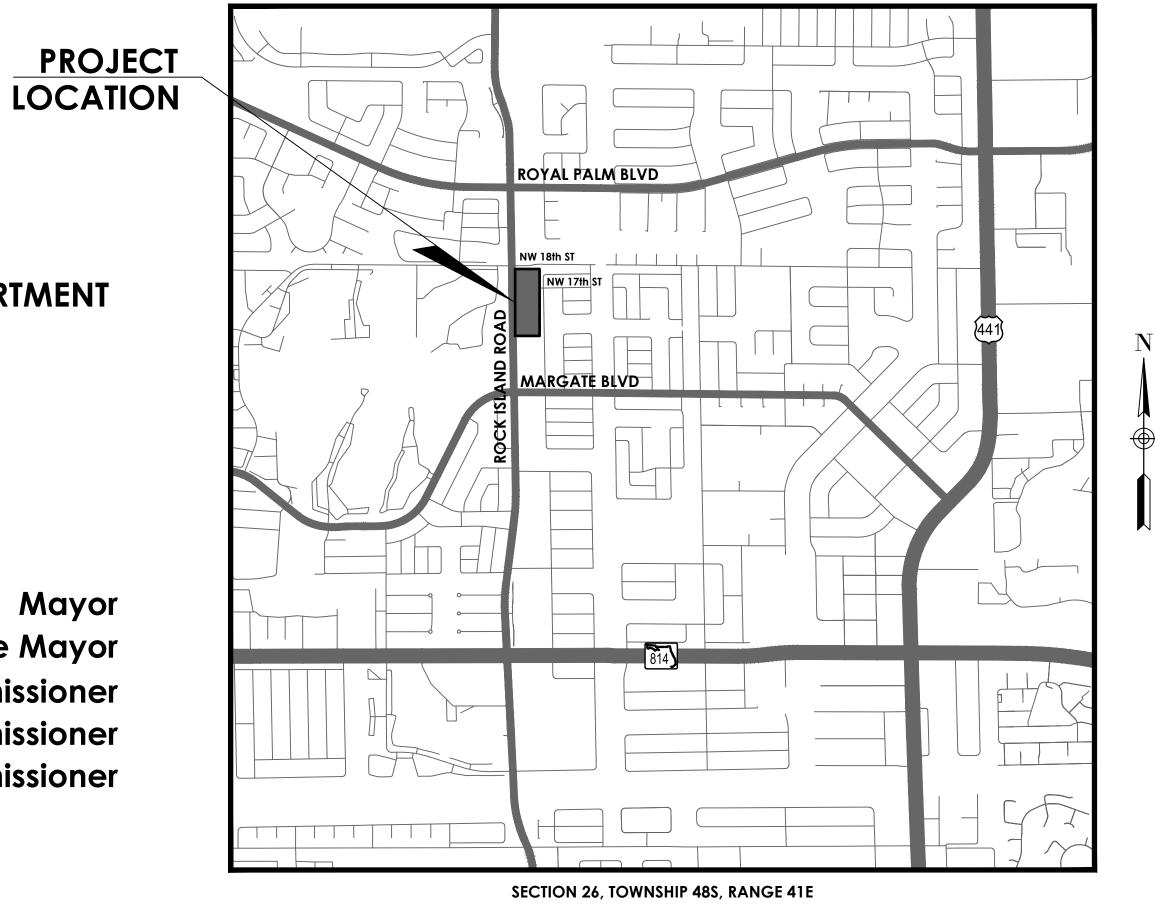

LOCATION MAP

Always call 811 two full business days before you dig to

have underground utilities located and marked. Sunshine 811.com

INDEX OF DRAWINGS


SHT #	DWG #	DESCRIPTION
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3	C1.02	EXISTING CONDITIONS AND DEMOLITION PLAN
4	C2.01	SITE PLAN
5	C2.02	SITE PLAN
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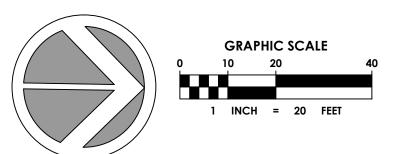
&ASSOCIATES

500 West Cypress Creek Road Suite 630 Ft. Lauderdale, FL 33309 954.730.0707 www.chenmoore.com **CERTIFICATES OF AUTHORIZATION** EB4593 LC26000425

PROJECT NUMBER 16-088.006 CLIENT PROJECT NUMBER PO#160934 DRAWING NUMBER G1.01 1 OF 19



65% CONSTRUCTION DOCUMENTS

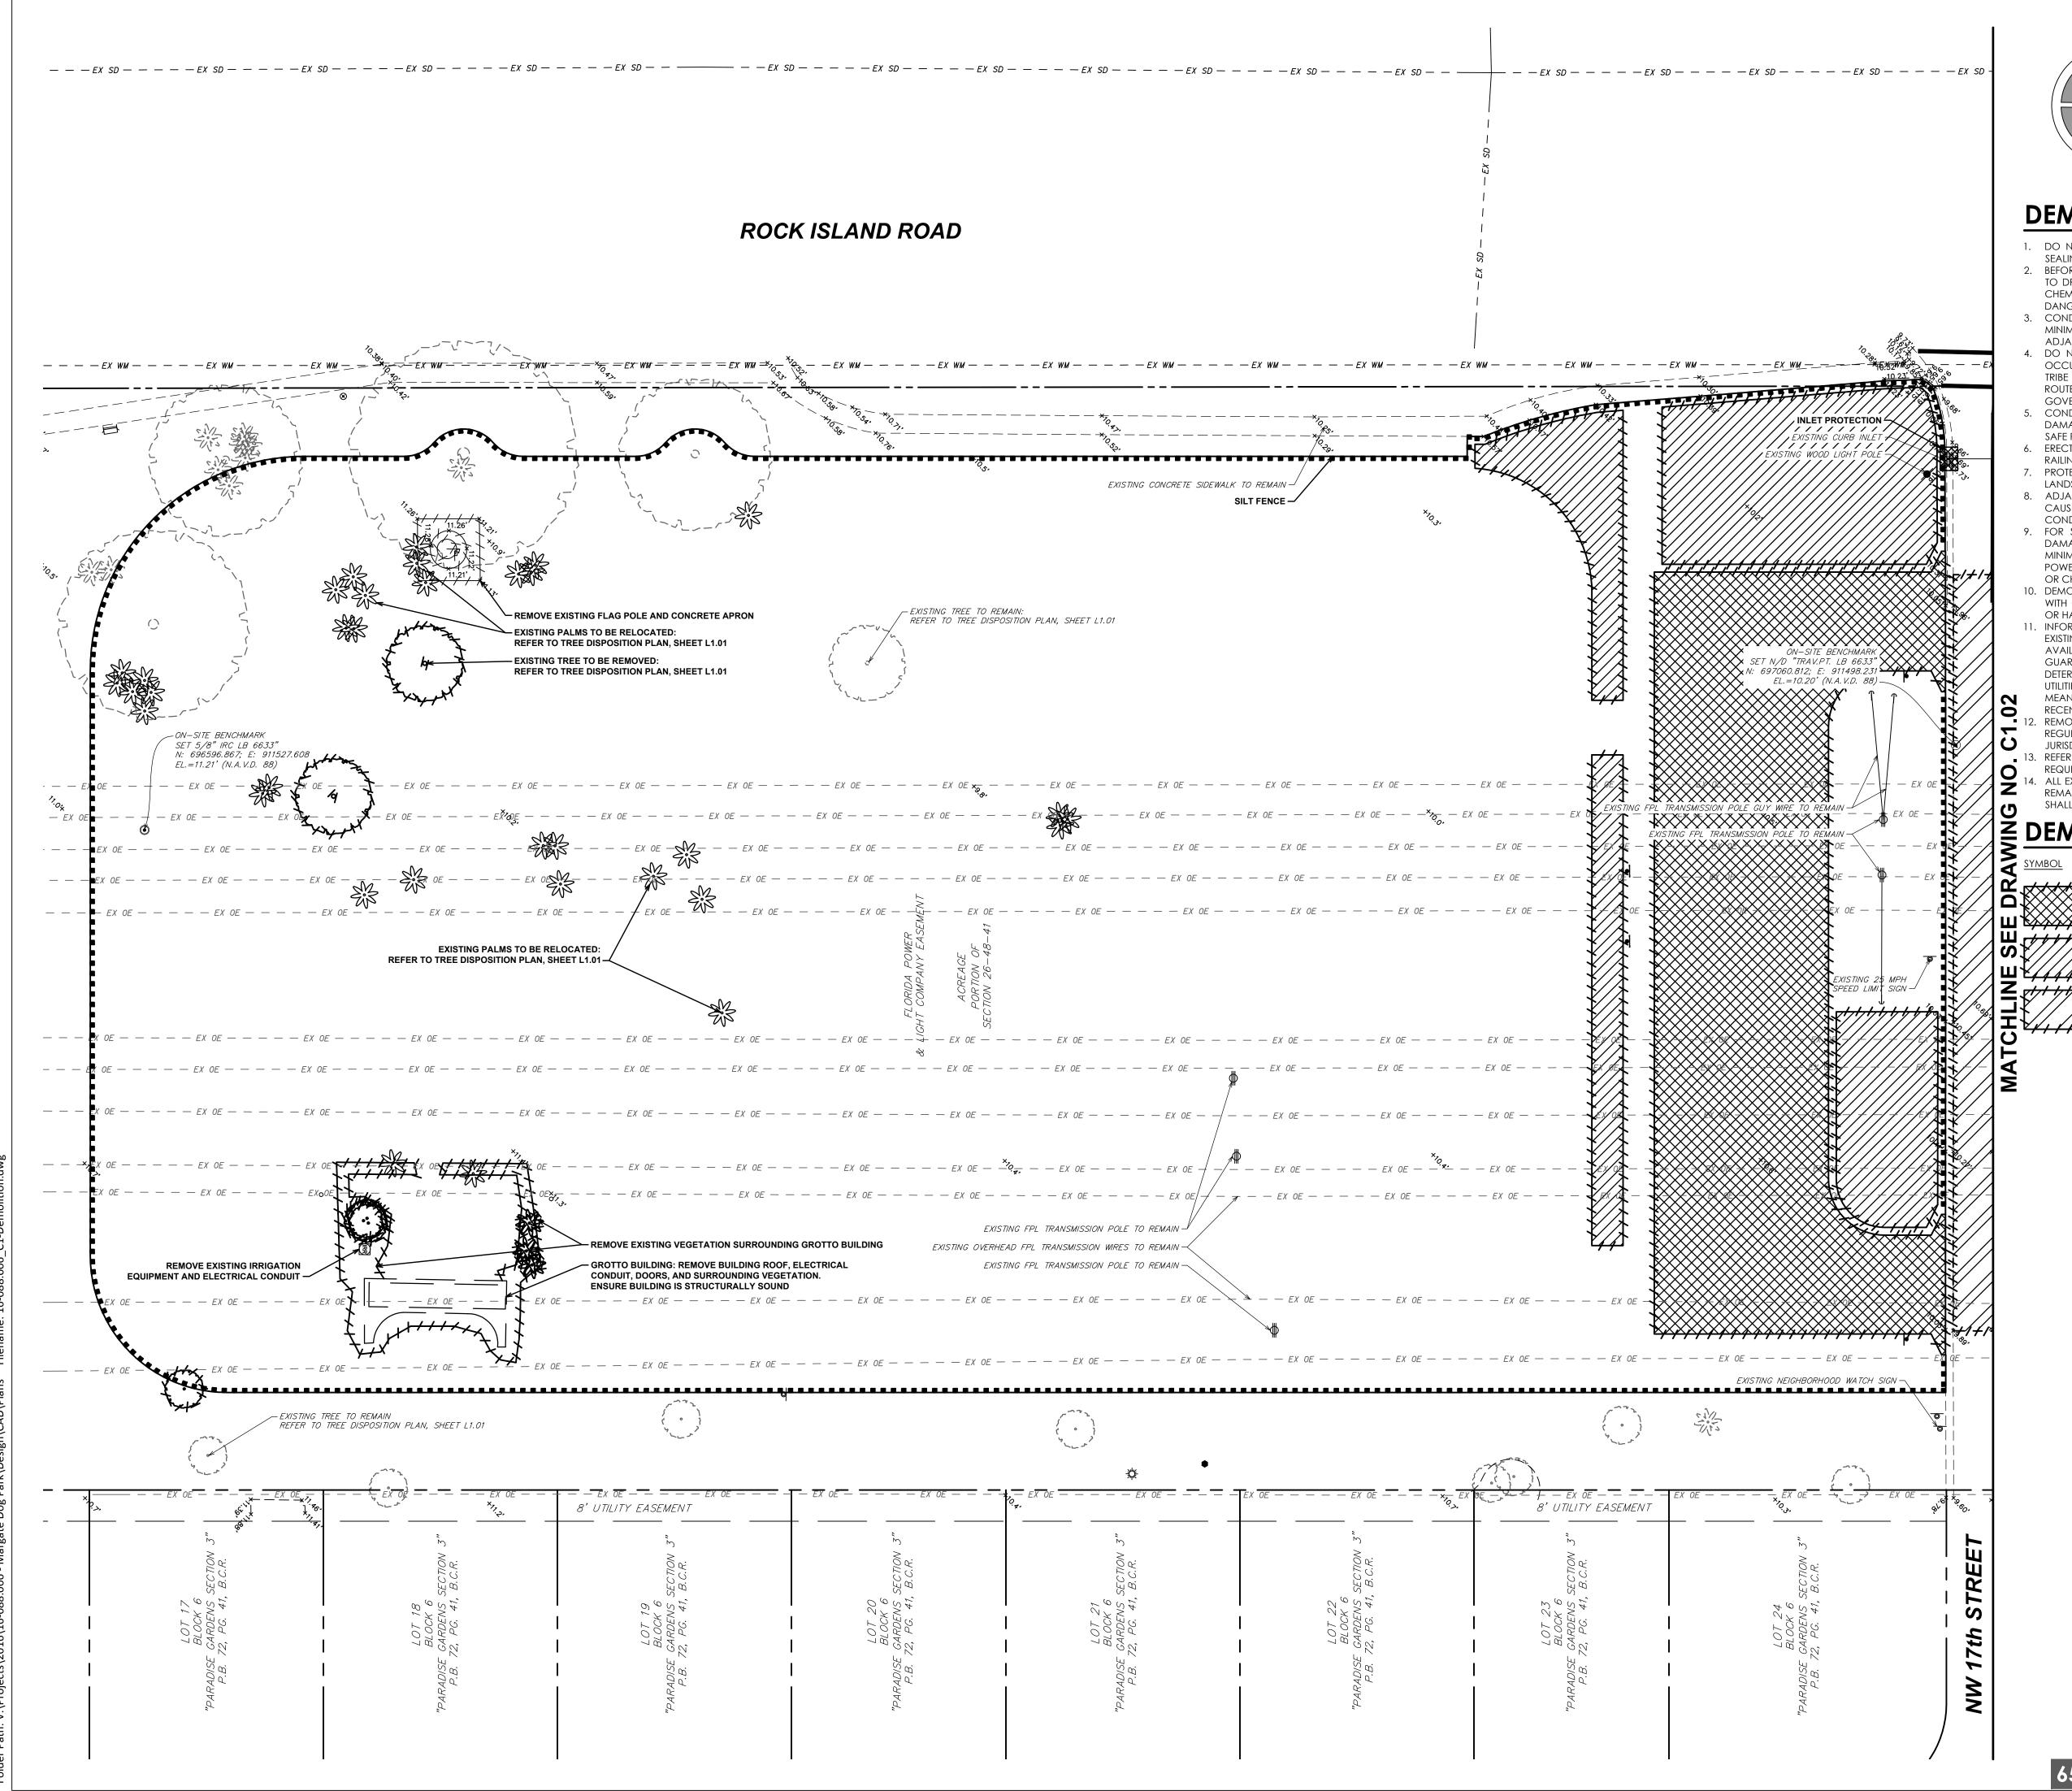

DEMOLITION NOTES

- 1. DO NOT START DEMOLITION WORK UNTIL UTILITY DISCONNECTING AND SEALING HAVE BEEN COMPLETED AND VERIFIED IN WRITING. 2. BEFORE PROCEEDING WITH DEMOLITION OPERATIONS THE CONTRACTOR IS TO DRAIN, PURGE, OR OTHERWISE REMOVE, COLLECT, AND DISPOSE OF CHEMICALS, GASES, EXPLOSIVES, ACIDS, FLAMMABLES, OR OTHER DANGEROUS MATERIALS.
- 3. CONDUCT DEMOLITION OPERATIONS AND REMOVE DEBRIS TO ENSURE MINIMUM INTERFERENCE WITH ROADS, STREETS, WALKS, AND OTHER
- ADJACENT OCCUPIED AND USED FACILITIES. DO NOT CLOSE OR OBSTRUCT STREETS, WALKS, OR OTHER ADJACENT OCCUPIED OR IN-USE FACILITIES WITHOUT PERMISSION FROM OWNER, THE TRIBE AND AUTHORITIES HAVING JURISDICTION. PROVIDE ALTERNATE ROUTES AROUND CLOSED OR OBSTRUCTED TRAFFIC WAYS AS REQUIRED BY GOVERNING REGULATIONS.
- CONDUCT DEMOLITION OPERATIONS TO PREVENT INJURY TO PEOPLE AND DAMAGE TO ADJACENT BUILDINGS AND FACILITIES TO REMAIN. ENSURE SAFE PASSAGE OF PEOPLE AROUND DEMOLITION AREA.
- ERECT TEMPORARY PROTECTION, SUCH AS WALKS, FENCES, BARRIERS, RAILINGS, ETC. WHERE REQUIRED BY AUTHORITIES HAVING JURISDICTION.
- PROTECT EXISTING SITE IMPROVEMENTS, APPURTENANCES, AND LANDSCAPING TO REMAIN.
- 8. ADJACENT IMPROVEMENTS SHALL BE CLEANED OF DUST, DIRT, AND DEBRIS CAUSED BY DEMOLITION OPERATIONS. RETURN ADJACENT AREAS TO CONDITION EXISTING BEFORE START OF DEMOLITION.
- 9. FOR SELECTIVE DEMOLITION, USE CUTTING METHODS LEAST LIKELY TO DAMAGE CONSTRUCTION TO REMAIN OR ADJOINING CONSTRUCTION. TO MINIMIZE DISTURBANCE OF ADJACENT SURFACES, USE HAND OR SMALL POWER TOOLS DESIGNED FOR SAWING OR GRINDING, NOT HAMMERING OR CHOPPING. TEMPORARILY COVER OPENINGS TO REMAIN
- 10. DEMOLISH CONCRETE IN SMALL SECTIONS. CUT CONCRETE AT JUNCTURES WITH CONSTRUCTION TO REMAIN, USING POWER-DRIVEN MASONRY SAW OR HAND TOOLS; DO NOT USE POWER-DRIVEN IMPACT TOOLS.
- 1. INFORMATION SHOWN ON THE DRAWINGS AS TO THE LOCATION OF EXISTING UTILITIES HAS BEEN PREPARED FROM THE MOST RELIABLE DATA AVAILABLE TO THE ENGINEER; HOWEVER, THIS INFORMATION IS NOT GUARANTEED. IT SHALL BE THE CONTRACTOR'S RESPONSIBILITY TO DETERMINE THE LOCATION, CHARACTER, AND DEPTH OF ALL EXISTING UTILITIES. THE CONTRACTOR SHALL ASSIST THE UTILITY COMPANIES, BY EVERY MEANS POSSIBLE, TO DETERMINE SAID LOCATIONS AND THE LOCATIONS OF
- RECENT ADDITIONS TO THE SYSTEMS NOT SHOWN. REMOVAL, DEMOLITION, HAULING, AND DISPOSAL SHALL COMPLY WITH REGULATIONS BY F.D.E.P., E.P.A., AND ANY OTHER AUTHORITY HAVING JURISDICTION.
- 13. REFER TO SPECIFICATIONS FOR ADDITIONAL INFORMATION AND REQUIREMENTS.
- 4. ALL EXISTING PATHWAY AND STREET LIGHTING WILL REMAIN IN PLACE AND REMAIN IN SERVICE DURING CONSTRUCTION OPERATIONS. CONTRACTOR SHALL USE CARE TO ENSURE EXISTING.

Z DEMOLITION LEGEND

<u>DESCRIPTION</u>

PROPOSED PARKING AREA TO BE CLEARED AND GRADED

MILL 1" OF EXISTING ASPHALT AREA

PROPOSED RETENTION AREA TO BE EXCAVATED



CLIENT







PROJECT NUMBER 16-088.006

PO#160934

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2016-10-18

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EXISTING

CONDITIONS

AND DEMOLITION

PLAN

CLIENT PROJECT NUMBER

VERIFY SCALES

REVISIONS

DATE OF ISSUE

DESIGNED BY

DRAWN BY

CHECKED BY

DRAWING TITLE

DRAWING NUMBER


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REGISTRATION JASON J. MCCLAIR **REGISTRATION NO. 56962** DATE:

SUB-CONSULTANT



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65% CONSTRUCTION DOCUMENTS

CAB DRAWING TITLE EXISTING CONDITIONS AND DEMOLITION PLAN DRAWING NUMBER 3 OF 19
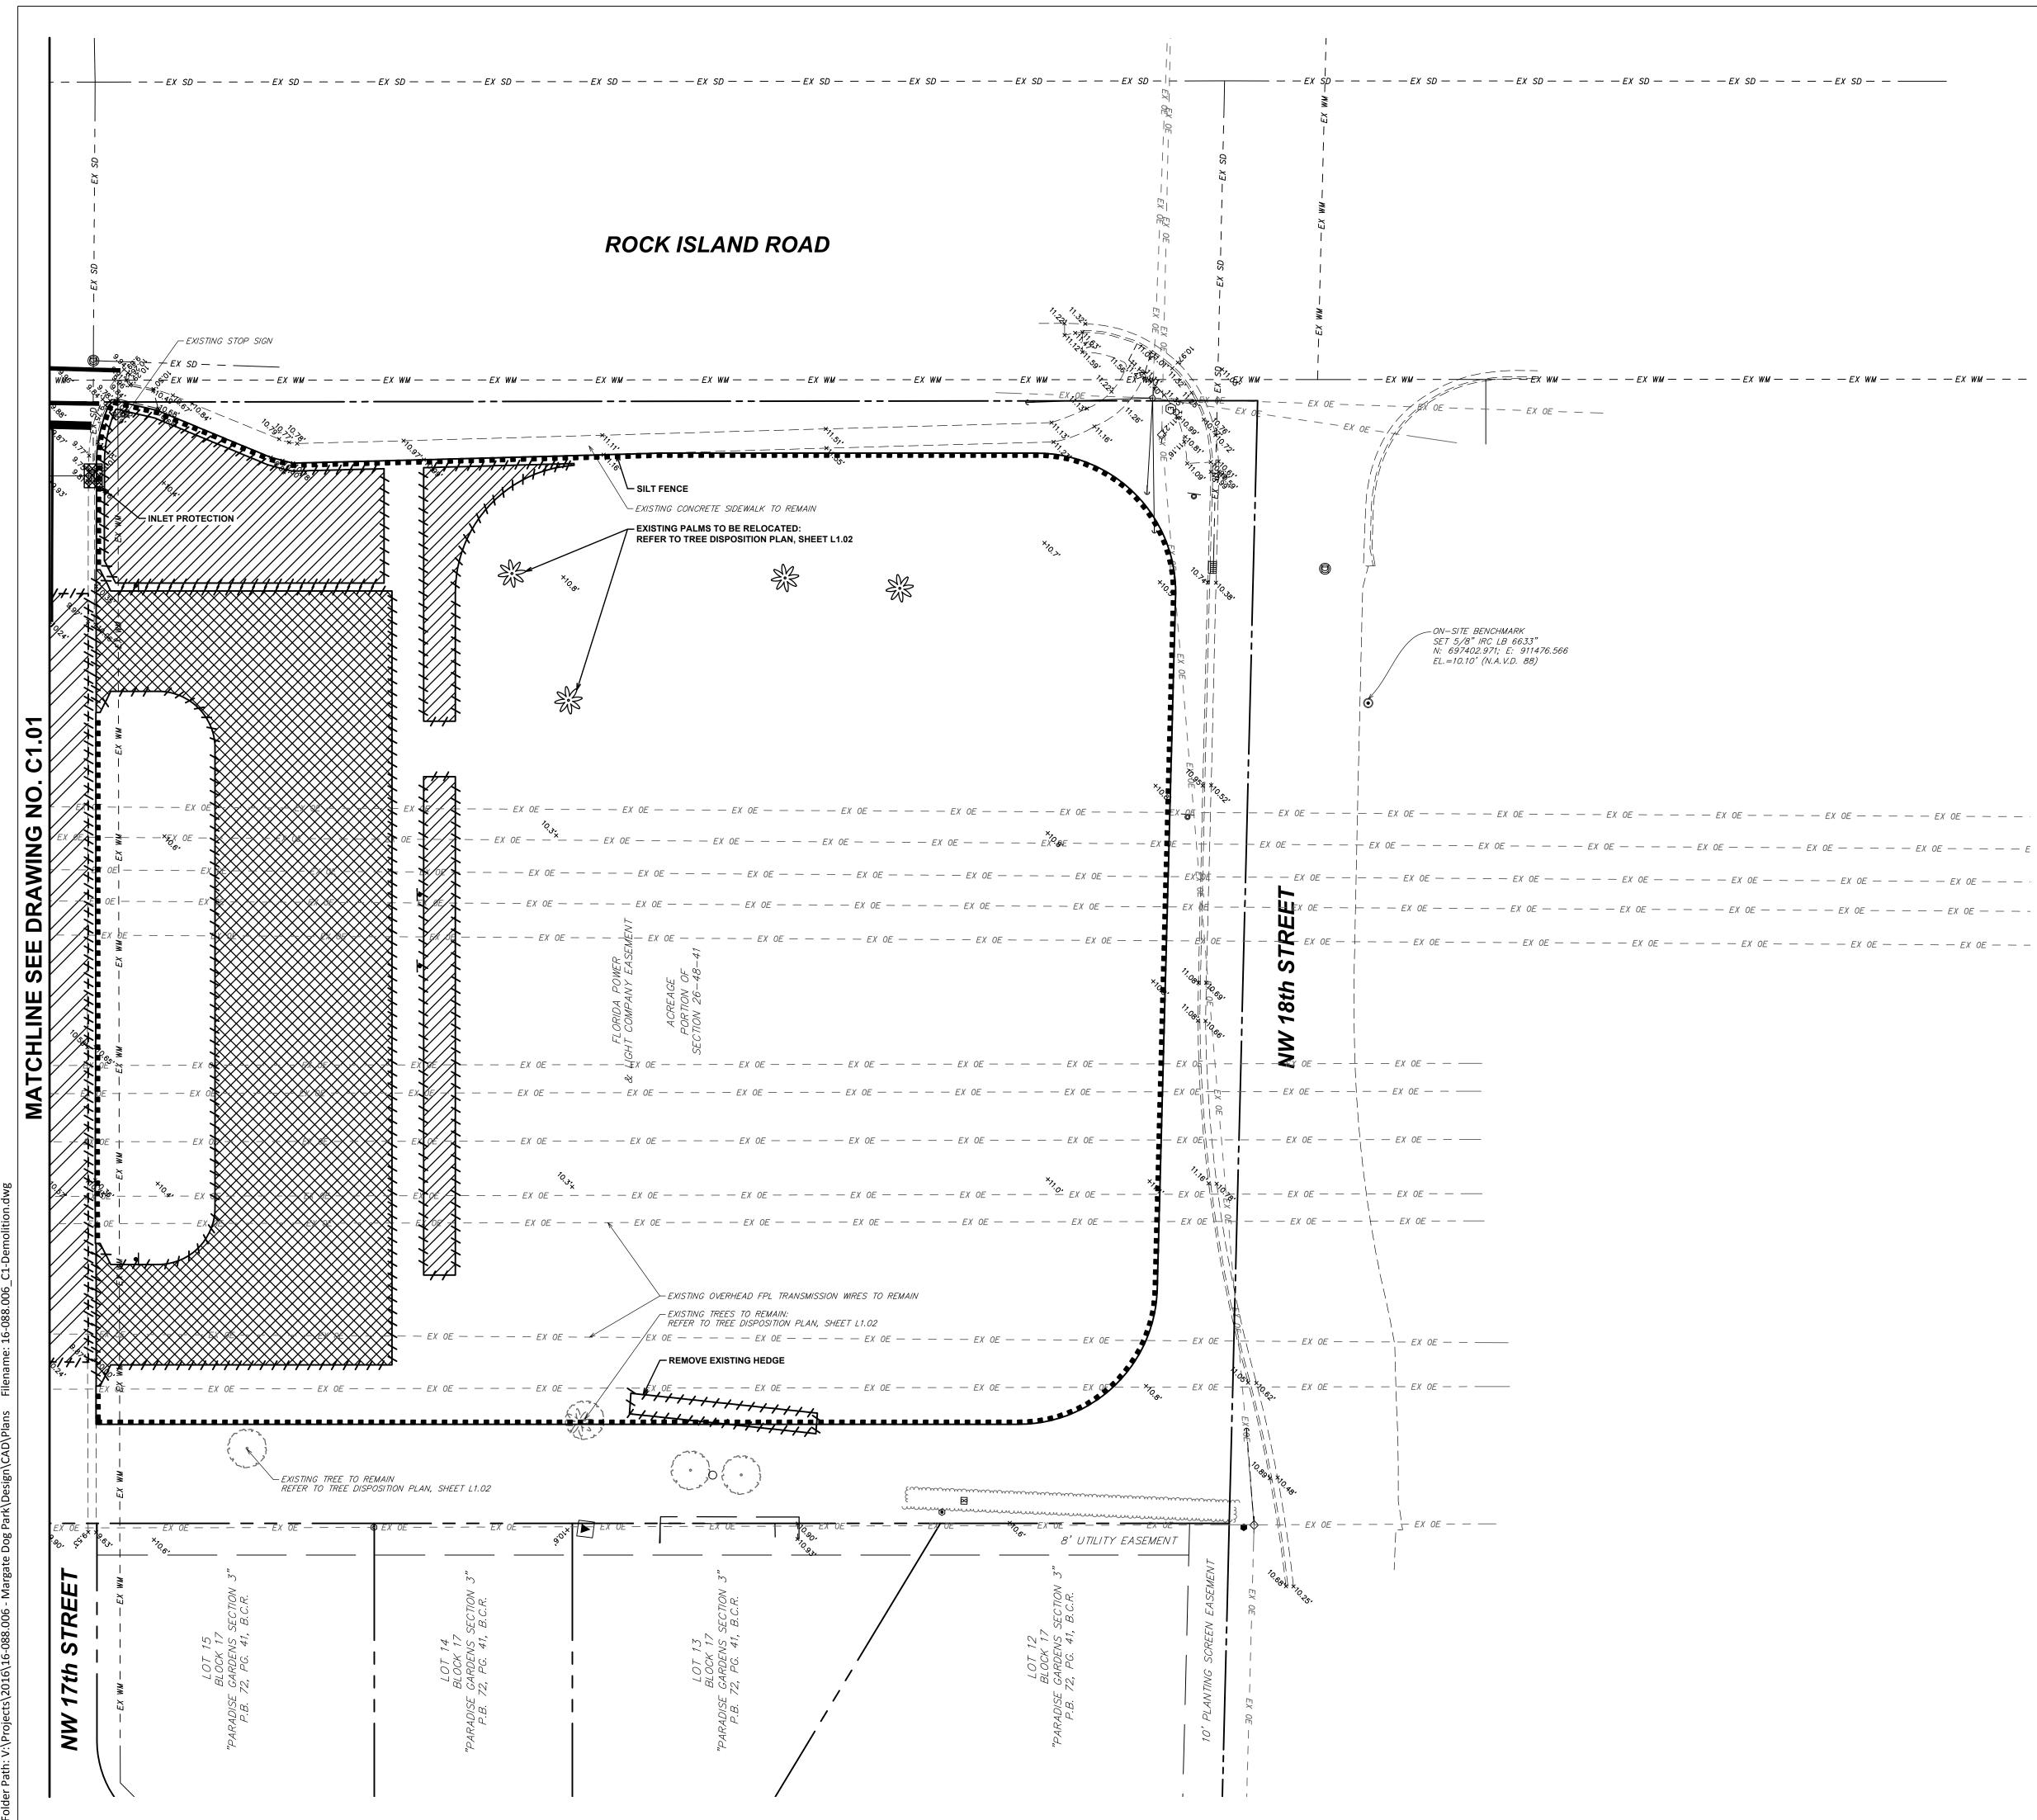
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DESIGNED BY

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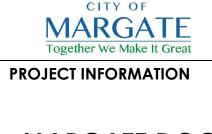
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CITY OF MARGATE, FLORIDA

PARK

MARGATE DOG



CLIENT

SUB-CONSULTANT

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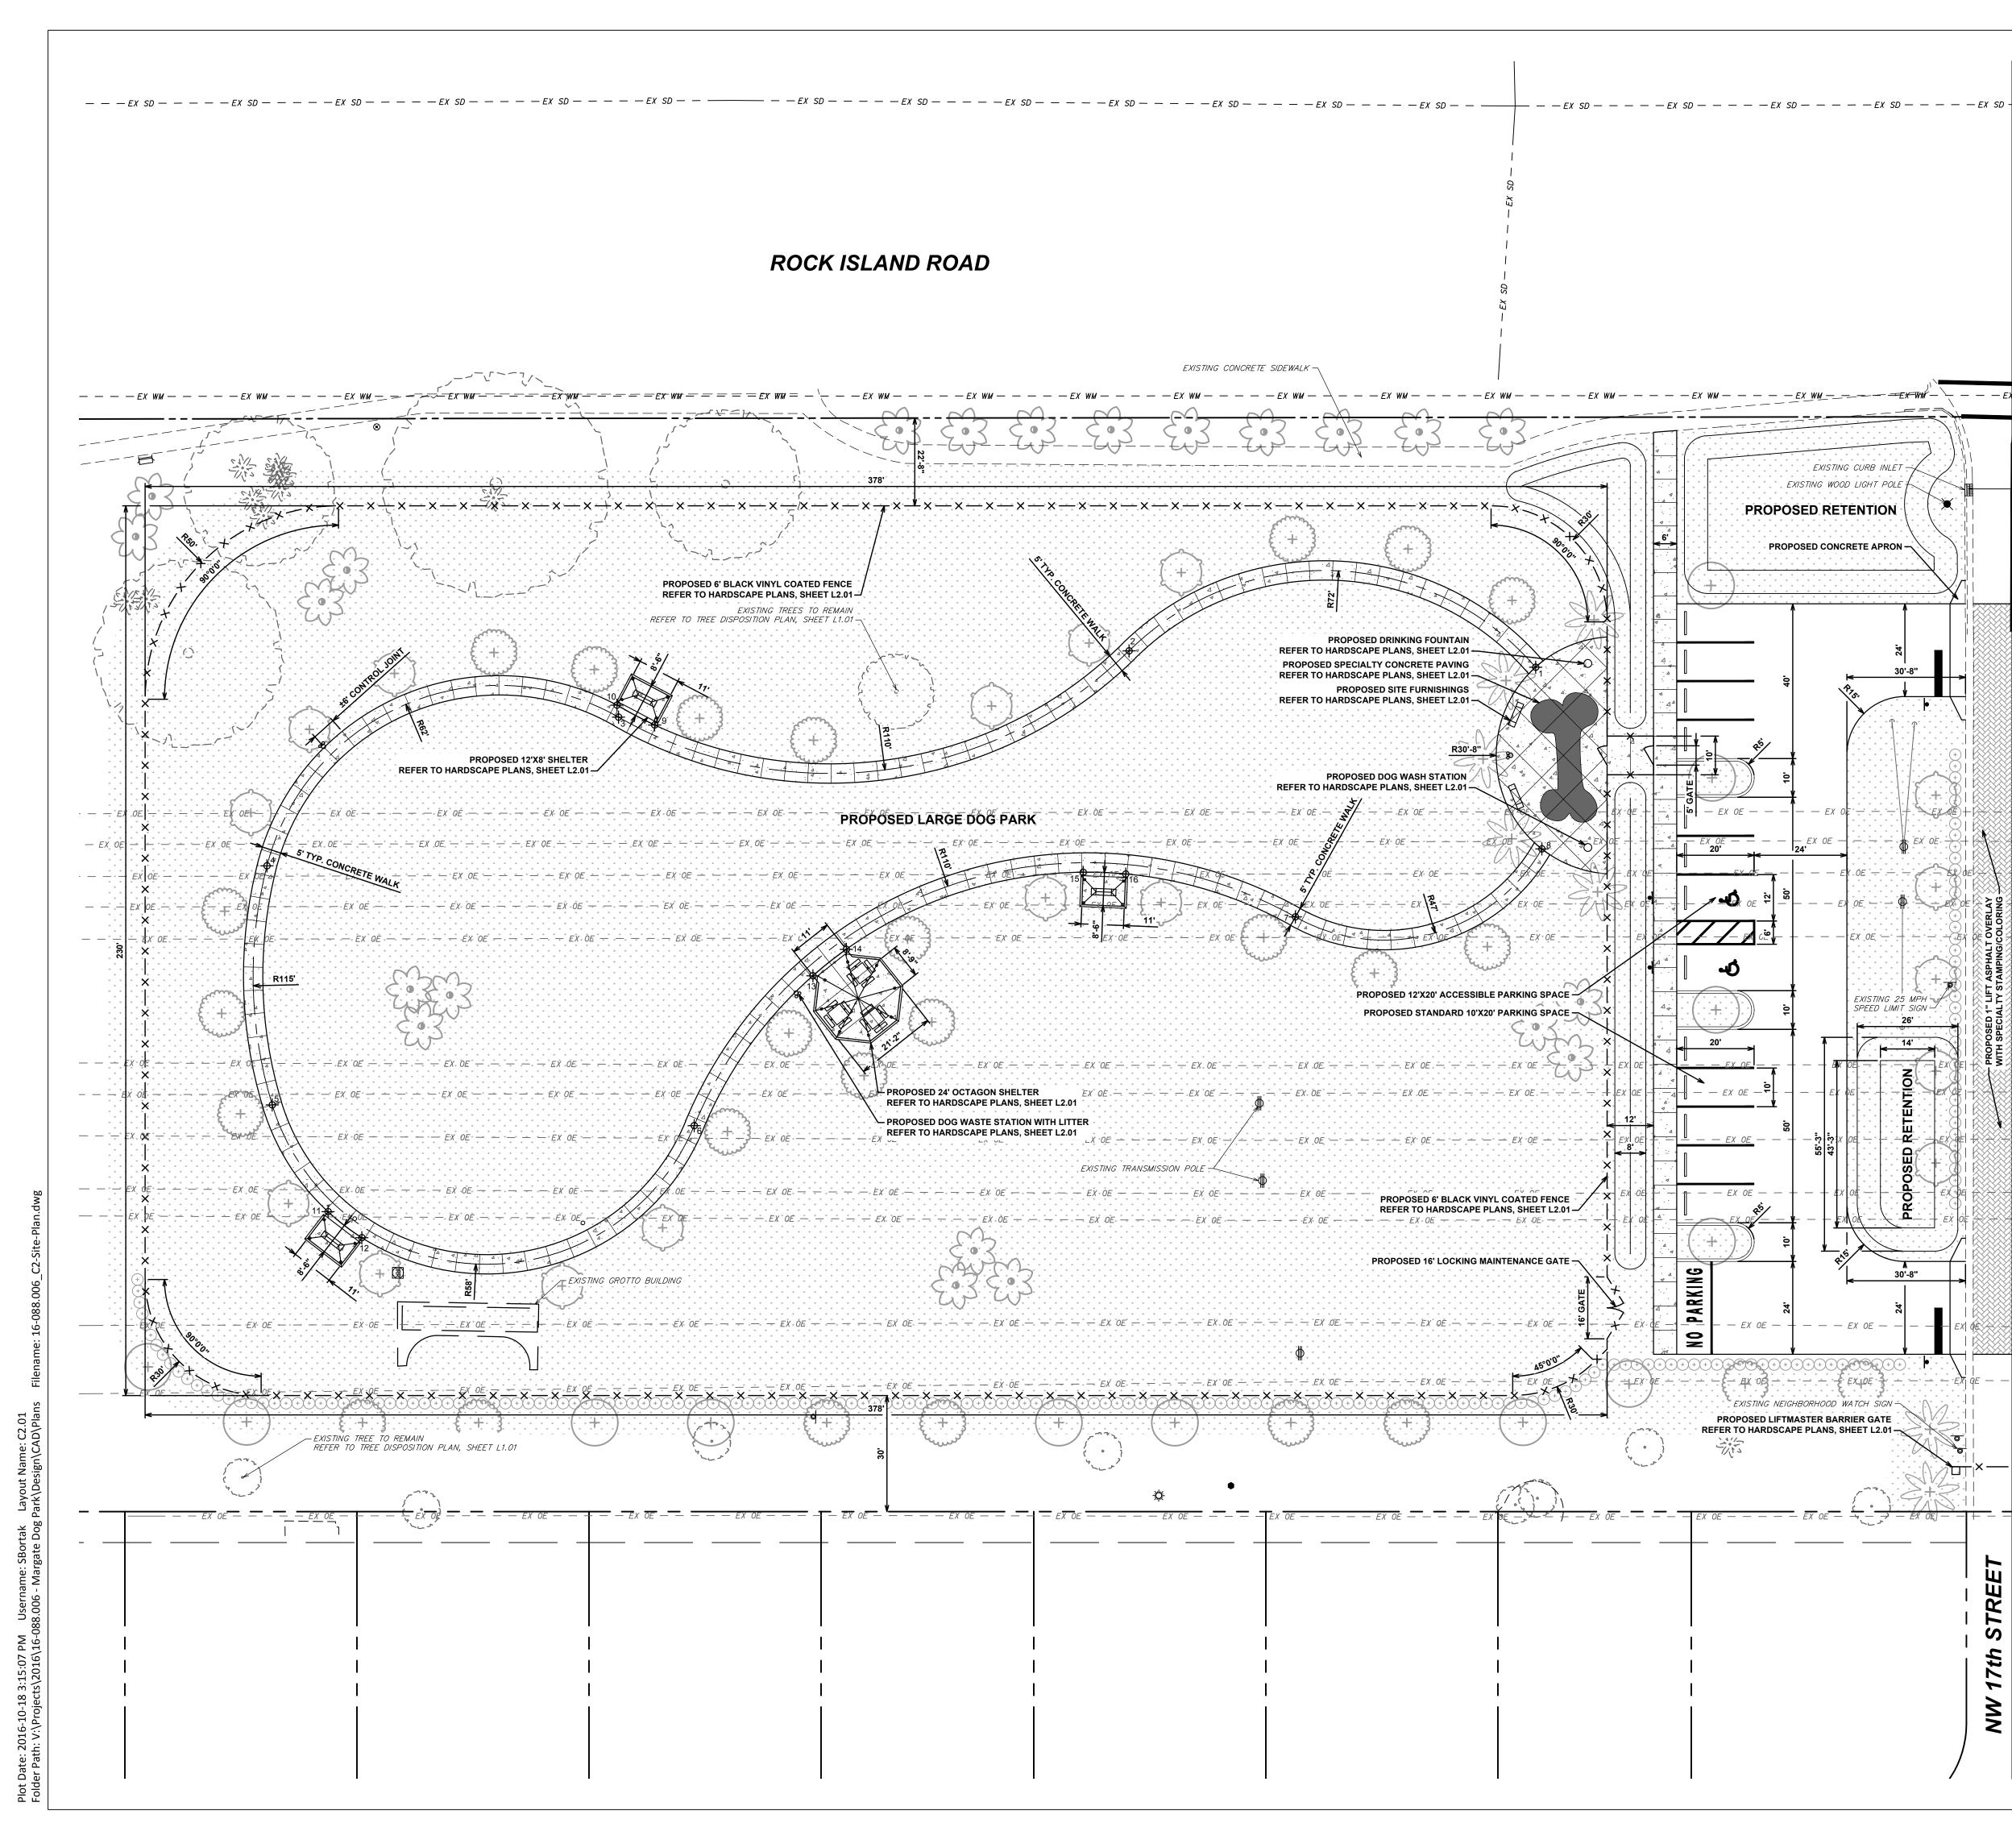
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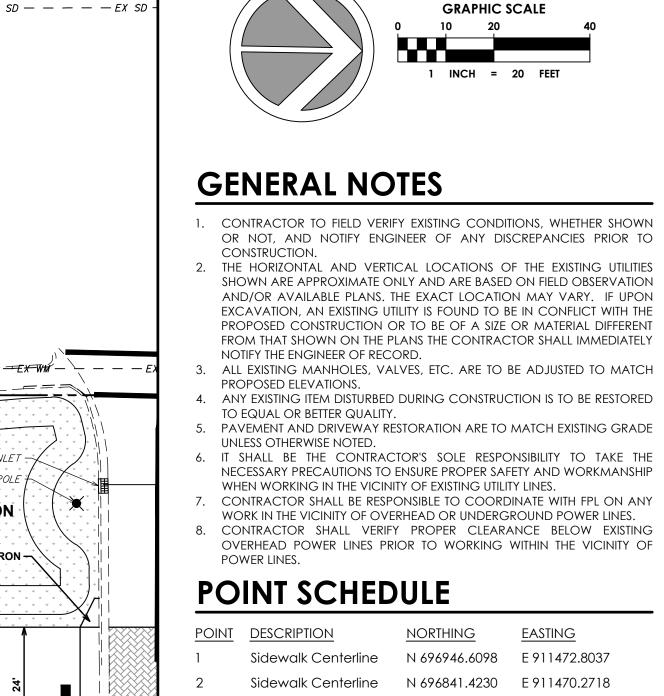
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CHEN-MOORE

GRAPHIC SCALE 1 INCH = 20 FEET






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SITE PLAN

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REGISTRATION NO. 56962

REGISTRATION

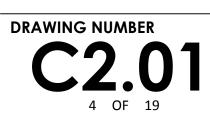DATE:

SUB-CONSULTANT

GRAPHIC SCALE 20

1 INCH = 20 FEET

<u>NORTHING</u>

Sidewalk Centerline N 696709.7375 E 911489.5715

Sidewalk Centerline N 696619.4712 E 911529.4949

Sidewalk Centerline N 696621.8416 E 911591.2661

Sidewalk Centerline N 696948.9788 E 911519.7390

Sidewalk Centerline N 697192.0564 E 911468.0705

Sidewalk Centerline N 697215.9166 E 911453.1304

Sidewalk Centerline N 697213.1886 E 911521.8792

Sidewalk Centerline

Sidewalk Centerline

Pavilion Slab Pavilion Slab

Pavilion Slab

Pavilion Slab

Pavilion Slab

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Sidewalk Centerline

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Pavilion Slab Pavilion Slab

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<u>EASTING</u>

N 696731.0243 E 911594.8256

N 696885.5518 E 911538.3554

N 696719.1108 E 911491.4461

N 696709.2862 E 911486.4984

N 696636.7281 E 911618.6345

N 696645.5587 E 911625.1935

N 696761.0860 E 911555.5981

N 696769.5971 E 911548.6295

N 696830.5006 E 911527.7198

N 696841.4973 E 911527.9908

N 697275.7501 E 911627.9993

N 697236.6899 E 911584.3011

N 697195.8590 E 911512.1180

N 697286.8630 E 911468.5001


N 697295.3260 E 911475.5270

N 697320.0519 E 911512.6466


N 697323.2752 E 911523.1637

N 697250.5793 E 911632.6552

N 697240.9081 E 911627.4141

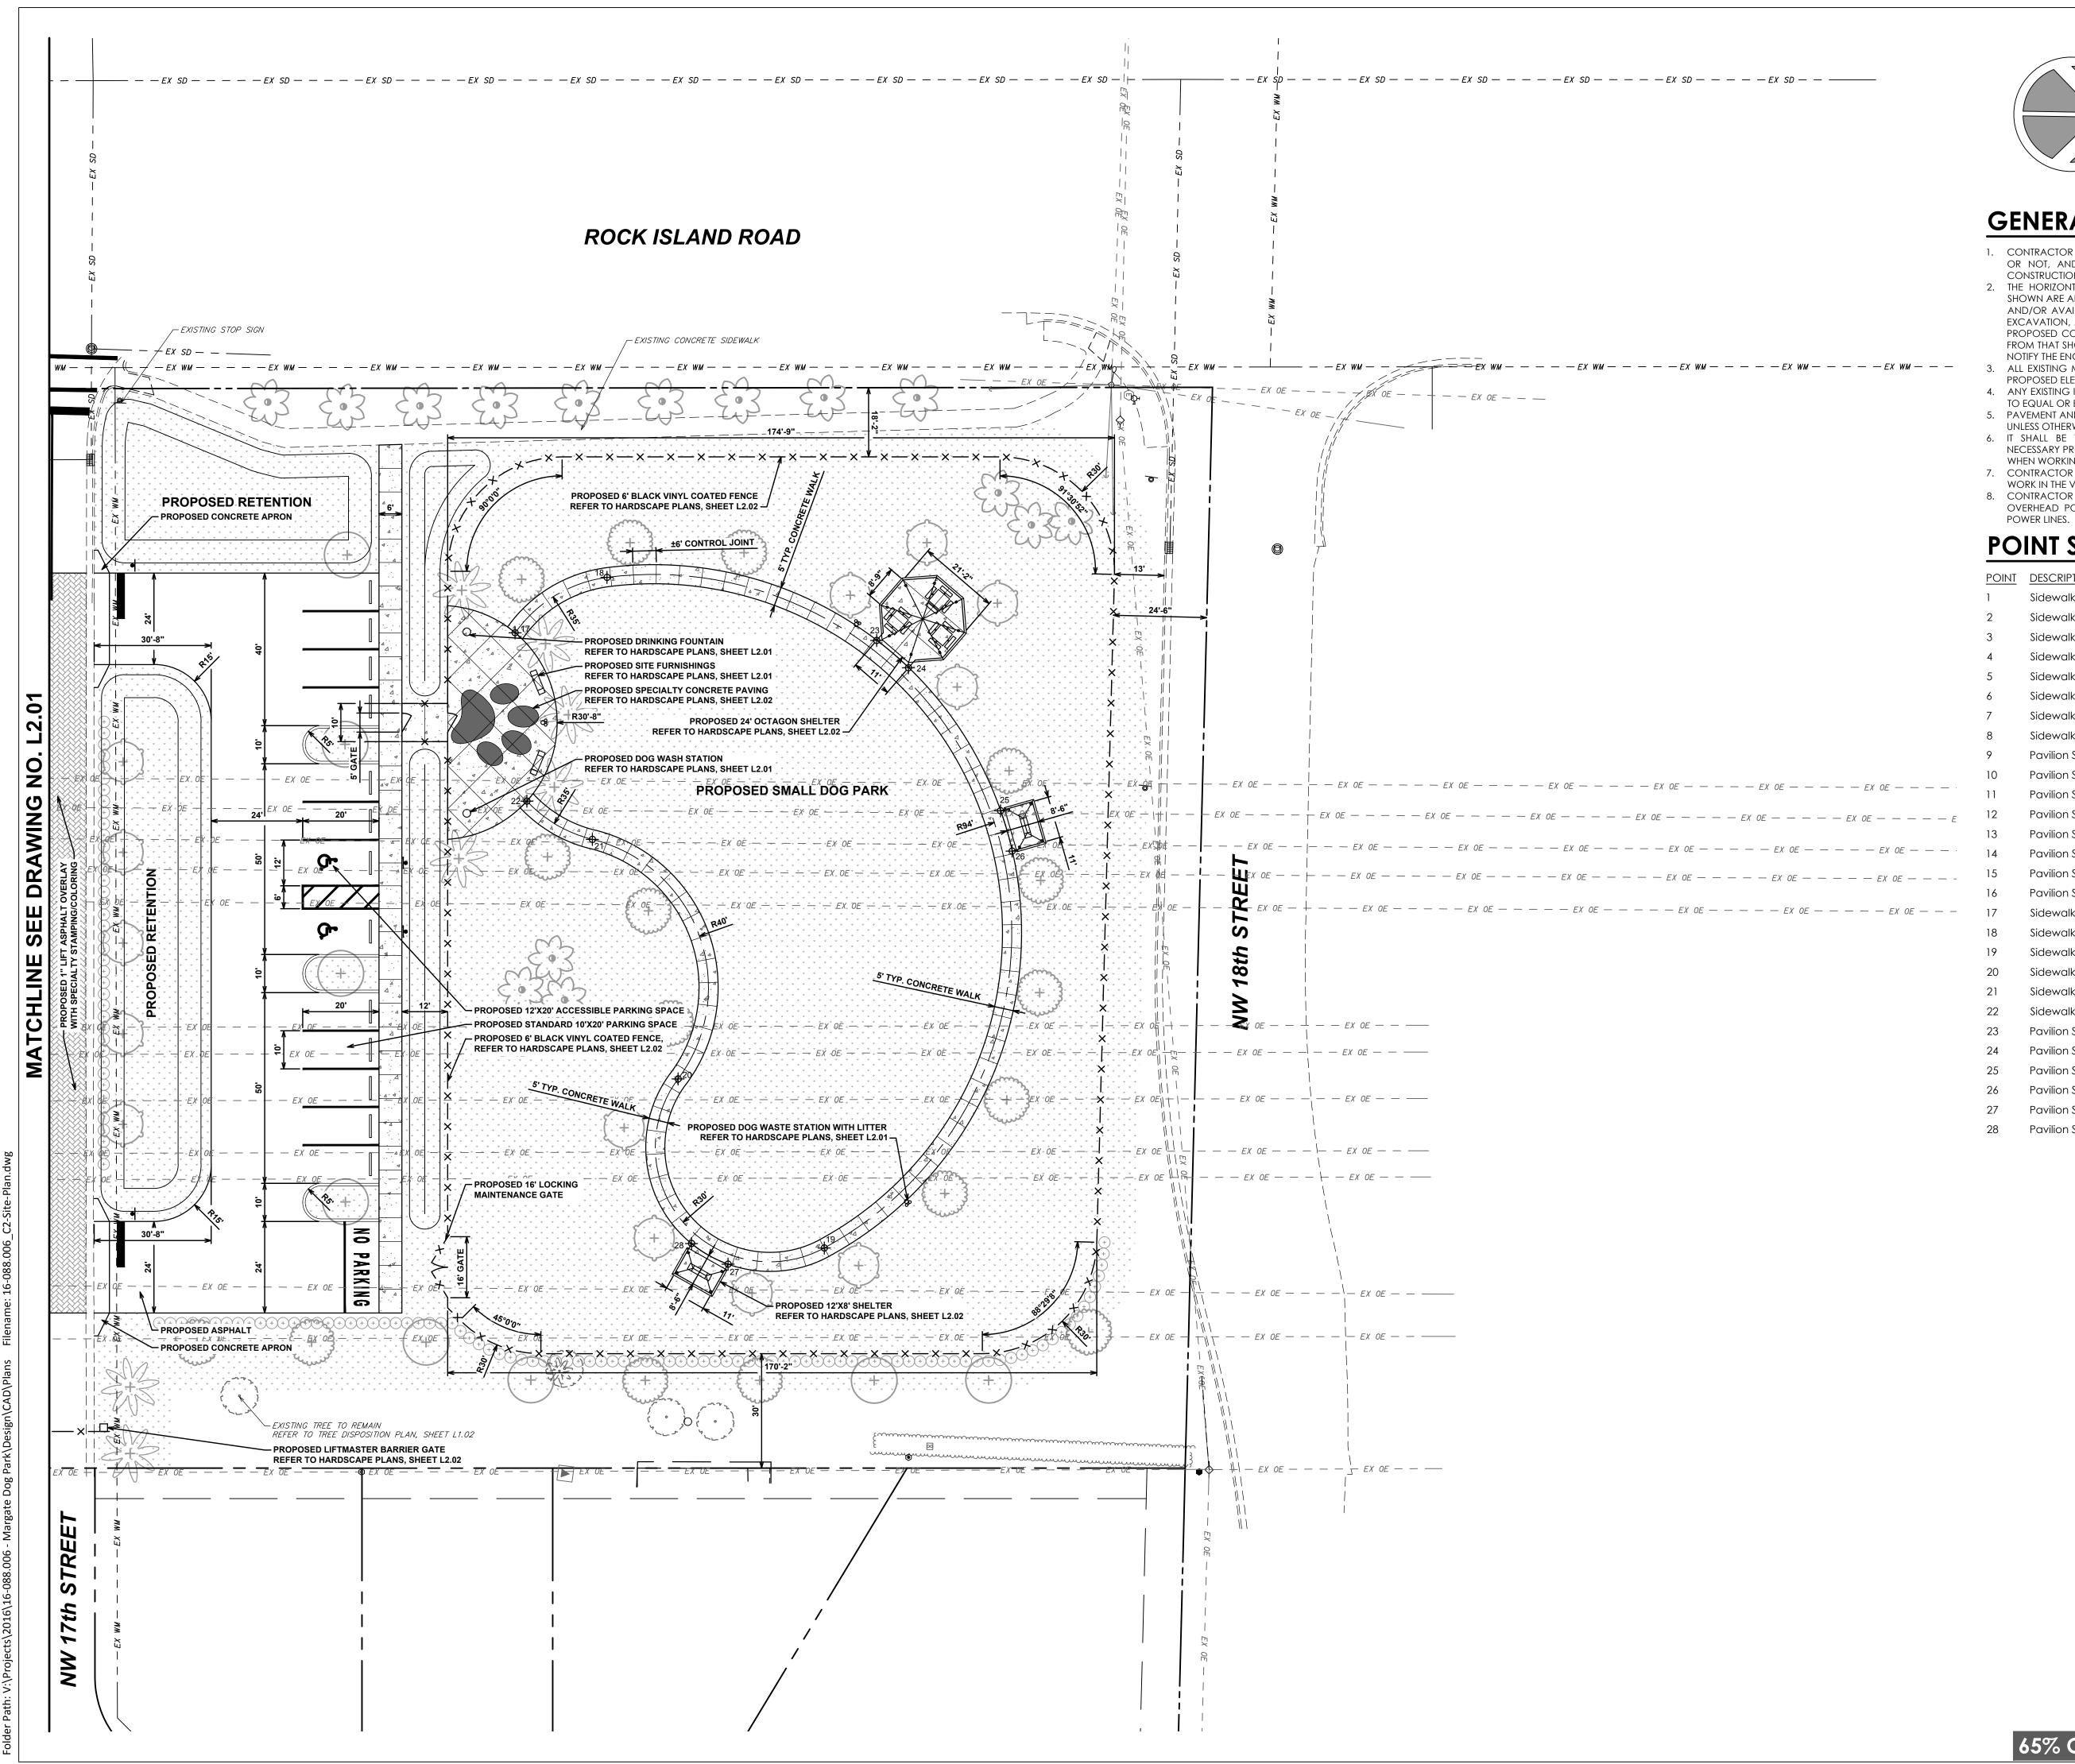

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GENERAL NOTES

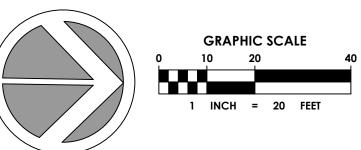- 1. CONTRACTOR TO FIELD VERIFY EXISTING CONDITIONS, WHETHER SHOWN OR NOT, AND NOTIFY ENGINEER OF ANY DISCREPANCIES PRIOR TO CONSTRUCTION.
- 2. THE HORIZONTAL AND VERTICAL LOCATIONS OF THE EXISTING UTILITIES SHOWN ARE APPROXIMATE ONLY AND ARE BASED ON FIELD OBSERVATION AND/OR AVAILABLE PLANS. THE EXACT LOCATION MAY VARY. IF UPON EXCAVATION, AN EXISTING UTILITY IS FOUND TO BE IN CONFLICT WITH THE PROPOSED CONSTRUCTION OR TO BE OF A SIZE OR MATERIAL DIFFERENT FROM THAT SHOWN ON THE PLANS THE CONTRACTOR SHALL IMMEDIATELY NOTIFY THE ENGINEER OF RECORD.
- 3. ALL EXISTING MANHOLES, VALVES, ETC. ARE TO BE ADJUSTED TO MATCH PROPOSED ELEVATIONS.
- 4. ANY EXISTING ITEM DISTURBED DURING CONSTRUCTION IS TO BE RESTORED TO EQUAL OR BETTER QUALITY.
- 5. PAVEMENT AND DRIVEWAY RESTORATION ARE TO MATCH EXISTING GRADE UNLESS OTHERWISE NOTED.
- 6. IT SHALL BE THE CONTRACTOR'S SOLE RESPONSIBILITY TO TAKE THE NECESSARY PRECAUTIONS TO ENSURE PROPER SAFETY AND WORKMANSHIP WHEN WORKING IN THE VICINITY OF EXISTING UTILITY LINES.
- 7. CONTRACTOR SHALL BE RESPONSIBLE TO COORDINATE WITH FPL ON ANY
- WORK IN THE VICINITY OF OVERHEAD OR UNDERGROUND POWER LINES. 8. CONTRACTOR SHALL VERIFY PROPER CLEARANCE BELOW EXISTING OVERHEAD POWER LINES PRIOR TO WORKING WITHIN THE VICINITY OF

POINT SCHEDULE

<u>'OINT</u>	DESCRIPTION	NORTHING	EASTING
	Sidewalk Centerline	N 696946.6098	E 911472.8037
2	Sidewalk Centerline	N 696841.4230	E 911470.2718
3	Sidewalk Centerline	N 696709.7375	E 911489.5715
ļ	Sidewalk Centerline	N 696619.4712	E 911529.4949
5	Sidewalk Centerline	N 696621.8416	E 911591.2661
	Sidewalk Centerline	N 696731.0243	E 911594.8256
,	Sidewalk Centerline	N 696885.5518	E 911538.3554
3	Sidewalk Centerline	N 696948.9788	E 911519.7390
)	Pavilion Slab	N 696719.1108	E 911491.4461
0	Pavilion Slab	N 696709.2862	E 911486.4984
1	Pavilion Slab	N 696636.7281	E 911618.6345
2	Pavilion Slab	N 696645.5587	E 911625.1935
3	Pavilion Slab	N 696761.0860	E 911555.5981
4	Pavilion Slab	N 696769.5971	E 911548.6295
5	Pavilion Slab	N 696830.5006	E 911527.7198
6	Pavilion Slab	N 696841.4973	E 911527.9908
7	Sidewalk Centerline	N 697192.0564	E 911468.0705
8	Sidewalk Centerline	N 697215.9166	E 911453.1304
9	Sidewalk Centerline	N 697275.7501	E 911627.9993
20	Sidewalk Centerline	N 697236.6899	E 911584.3011
21	Sidewalk Centerline	N 697213.1886	E 911521.8792
22	Sidewalk Centerline	N 697195.8590	E 911512.1180
23	Pavilion Slab	N 697286.8630	E 911468.5001
24	Pavilion Slab	N 697295.3260	E 911475.5270
25	Pavilion Slab	N 697320.0519	E 911512.6466
26	Pavilion Slab	N 697323.2752	E 911523.1637
27	Pavilion Slab	N 697250.5793	E 911632.6552
28	Pavilion Slab	N 697240.9081	E 911627.4141



SITE PLAN

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16-088.006

CITY OF MARGATE. FLORIDA PROJECT NUMBER

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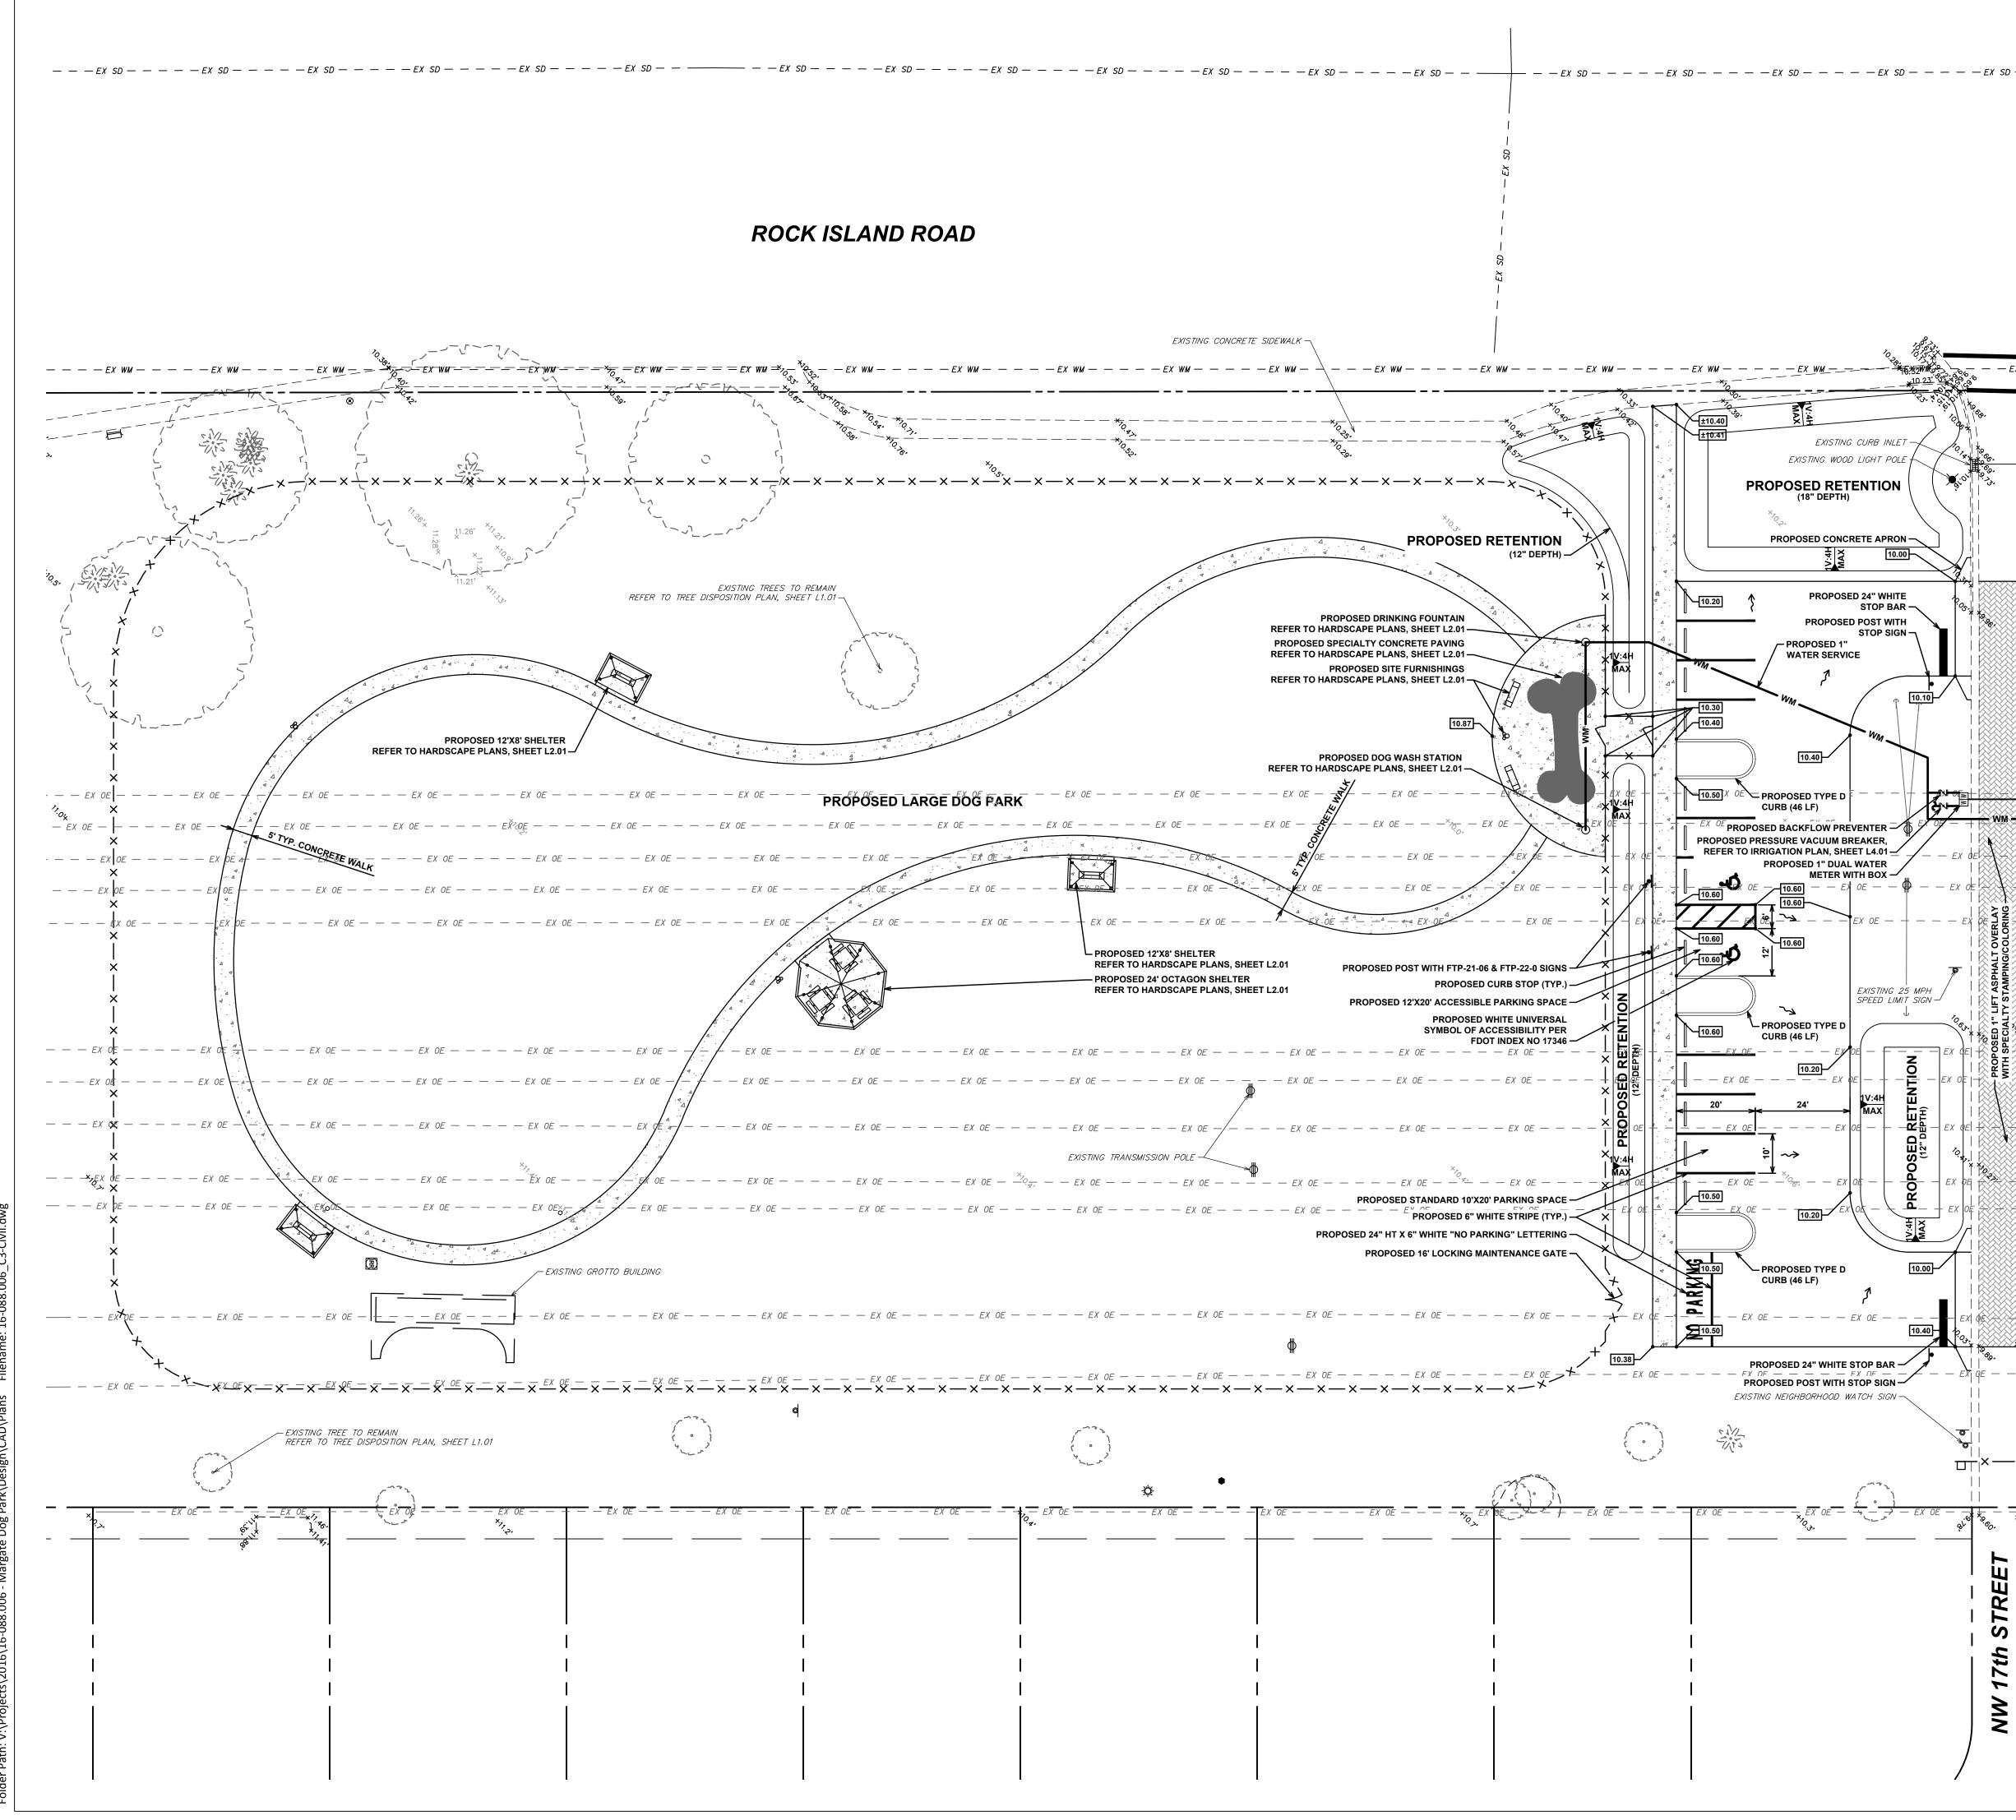
SUB-CONSULTANT

EB4593 LC26000425 REGISTRATION JASON J. MCCLAIR **REGISTRATION NO. 56962** DATE:

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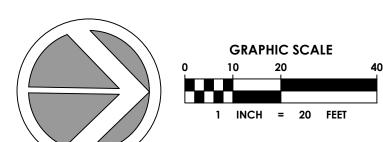
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PAVING GRADING DRAINAGE

- 1. ALL SIDEWALKS SHALL MEET ALL A.D.A. REQUIREMENTS (5% MAX. LONGITUDINAL SLOPE AND 2% MAX. TRANSVERSE SLOPE). 2. ALL INLETS SHALL BE TYPE 'C' AND MANHOLES SHALL BE TYPE 'P-7' 4'Ø, ALL
- H-20 RATED, UNLESS OTHERWISE NOTED ON PLAN. 3. CONCRETE PIPE FOR STORM SEWERS SHALL CONFORM TO ASTM L76-79, TABLE III, WALL B, OR LATEST REVISION. ALL PIPE SHALL HAVE MODIFIED
- TONGUE AND GROOVE JOINTS, AND HAVE RUBBER GASKETS, UNLESS OTHERWISE SPECIFIED. 4. BEDDING AND INITIAL BACKFILL OVER DRAINAGE PIPE SHALL BE SAND WITH
- NO ROCK LARGER THAN 1" DIAMETER. BACKFILL MATERIAL UNDER PAVED AREAS SHALL BE COMPACTED TO 98%
- OF THE MAXIMUM DENSITY AS DETERMINED BY AASHTO T-180. 6. BACKFILL MATERIAL UNDER AREAS NOT TO BE PAVED SHALL BE COMPACTED TO 95% OF THE MAXIMUM DENSITY AS DETERMINED BY
- AASHTO T-180. DRAINAGE STRUCTURES AND LINES TO BE CLEANED PRIOR TO ENGINEER'S
- ACCEPTANCE.
- CONTRACTOR TO PROVIDE DETAILED AS-BUILTS SURVEYS THAT CLEARLY DEFINE THE AREAS OF WORK COMPLETED UNDER THIS CONTRACT INCLUDING BUT NOT LIMITED TO ALL RIM ELEVATIONS (EXISTING AND PROPOSED STRUCTURES), ALL INVERTS, BOTTOM OF STRUCTURE, SUFFICIENT SWALE ELEVATIONS TO DEMONSTRATE THAT SWALES DRAIN TO INLETS, LOCATION OF EXFILTRATION TRENCH, LOCATION OF DRIVEWAY RESTORATION, AND RESTORED ASPHALT PAVEMENT.

WATER AND SEWER

- CONTRACTOR SHALL PLAN ALL UTILITY CROSSINGS TO CONFIRM HORIZONTAL AND VERTICAL SEPARATIONS PRIOR TO CONSTRUCTION.
- WATER & SEWER LINES SHALL BE LAID WITH A MINIMUM SIX (6) FOOT LATERAL SEPARATION FROM OBSTRUCTIONS (I.E. CULVERTS, STRUCTURES, ETC.) AND A MINIMUM TEN (10) FOOT CLEARANCE FROM TREES. FIRE
- HYDRANTS SHALL HAVE A 7.5' CLEAR RADIUS OF ANY OBSTRUCTIONS. WATER MAIN SHALL CROSS OVER DRAINAGE & SEWER LINES UNLESS OTHERWISE SPECIFIED ON PLAN. 10' MINIMUM HORIZONTAL CLEARANCE IS REQUIRED BETWEEN WATER MAIN AND FORCE MAIN.
- 4. THE EXISTING WATER MAINS AND FIRE HYDRANTS THAT ARE TO BE REMOVED Shall remain active until a clearance letter has been issued and THE NEW WATER MAINS AND FIRE HYDRANTS ARE ACTIVATED.
- CONTRACTOR TO PROVIDE DETAILED AS-BUILTS SURVEYS THAT CLEARLY DEFINE THE AREAS OF WORK COMPLETED UNDER THIS CONTRACT INCLUDING BUT NOT LIMITED TO TOP OF PIPE ELEVATION, TOP OF ALL FITTINGS, ETC.

Z SIGNING AND MARKING

- ALL PAVEMENT MARKINGS SHALL BE THERMOPLASTIC UNLESS OTHERWISE
- NOTED. BI-DIRECTIONAL YELLOW/YELLOW REFLECTIVE PAVEMENT MARKERS SHALL BE PROVIDED AT 40' INTERVALS CENTERED BETWEEN YELLOW SKIP STRIPES. ONE BI-DIRECTIONAL YELLOW/YELLOW REFLECTIVE MARKER SHALL BE PROVIDED AT 40' INTERVALS ON EACH SIDE OF DOUBLE YELLOW STRIPES.
- ONE BI-DIRECTIONAL YELLOW/YELLOW REFLECTIVE PAVEMENT MARKER SHALL BE PROVIDED AT EACH END OF 18" YELLOW STRIPES ON EACH SIDE OF DOUBLE YELLOW STRIPES.
- BI-DIRECTIONAL COLORLESS/RED REFLECTIVE PAVEMENT MARKERS SHALL BE PROVIDED AT 20' INTERVALS ALONG SOLID WHITE LINES (NOT ON EDGE OF PAVEMENT LINES).
- BI-DIRECTIONAL YELLOW/YELLOW REFLECTIVE PAVEMENT MARKERS SHALL BE PROVIDED AT 1' INTERVALS AT ALL BULLNOSES. ALL SIGNING, PAVEMENT MARKINGS AND PLACEMENT OF REFLECTIVE
- PAVEMENT MARKERS SHALL CONFORM TO THE MANUAL OF UNIFORM TRAFFIC CONTROL DEVICES MANUAL (MUTCD), LATEST VERSION. ALL PAVEMENT MARKING SHALL BE HOT APPLIED THERMOPLASTIC MANUFACTURED AND APPLIED IN ACCORDANCE WITH FDOT STANDARD SPECIFICATION SECTION 711, LATEST EDITION.
- REFLECTIVE PAVEMENT MARKERS SHALL BE CLASS B MARKERS MANUFACTURED IN ACCORDANCE WITH FDOT STANDARD SPECIFICATION 706, LATEST EDITION AND INSTALLED IN ACCORDANCE WITH THE MANUFACTURER'S RECOMMENDED PROCEDURES.
- 10. ALL SIGNS SHALL BE MANUFACTURED AND INSTALLED IN ACCORDANCE WITH THE MANUAL ON UNIFORM TRAFFIC CONTROL DEVICES, LATEST EDITION.
- 11. ALL `R1-1' & `D3' SIGNS SHALL BE DIAMOND GRADE.

`D3' SIGNS.

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- 12. THE PUBLIC ROADWAYS INDICATED IN THESE PLANS HAVE BEEN DESIGNED SUBSTANTIALLY IN ACCORDANCE WITH "THE MANUAL OF UNIFORM MINIMUM STANDARDS FOR DESIGN, CONSTRUCTION AND MAINTENANCE FOR STREETS AND HIGHWAYS-STATE OF FLORIDA". 13. METHOD OF REMOVAL OF EXISTING PAVEMENT MARKINGS SHALL BE BY
- WATER JETTING OR SAND BLASTING. 14. THE CONTRACTOR SHALL VERIFY PROPER STREET NAMES AND NUMBERS WITH AN APPROVED ADDRESS PLAN PRIOR TO ORDERING AND INSTALLING



&ASSOCIATES 500 West Cypress Creek Road Suite 630 Ft. Lauderdale, FL 33309 954.730.0707 www.chenmoore.com **CERTIFICATES OF AUTHORIZATION** EB4593 LC26000425

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16-088.006

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CIVIL PLAN

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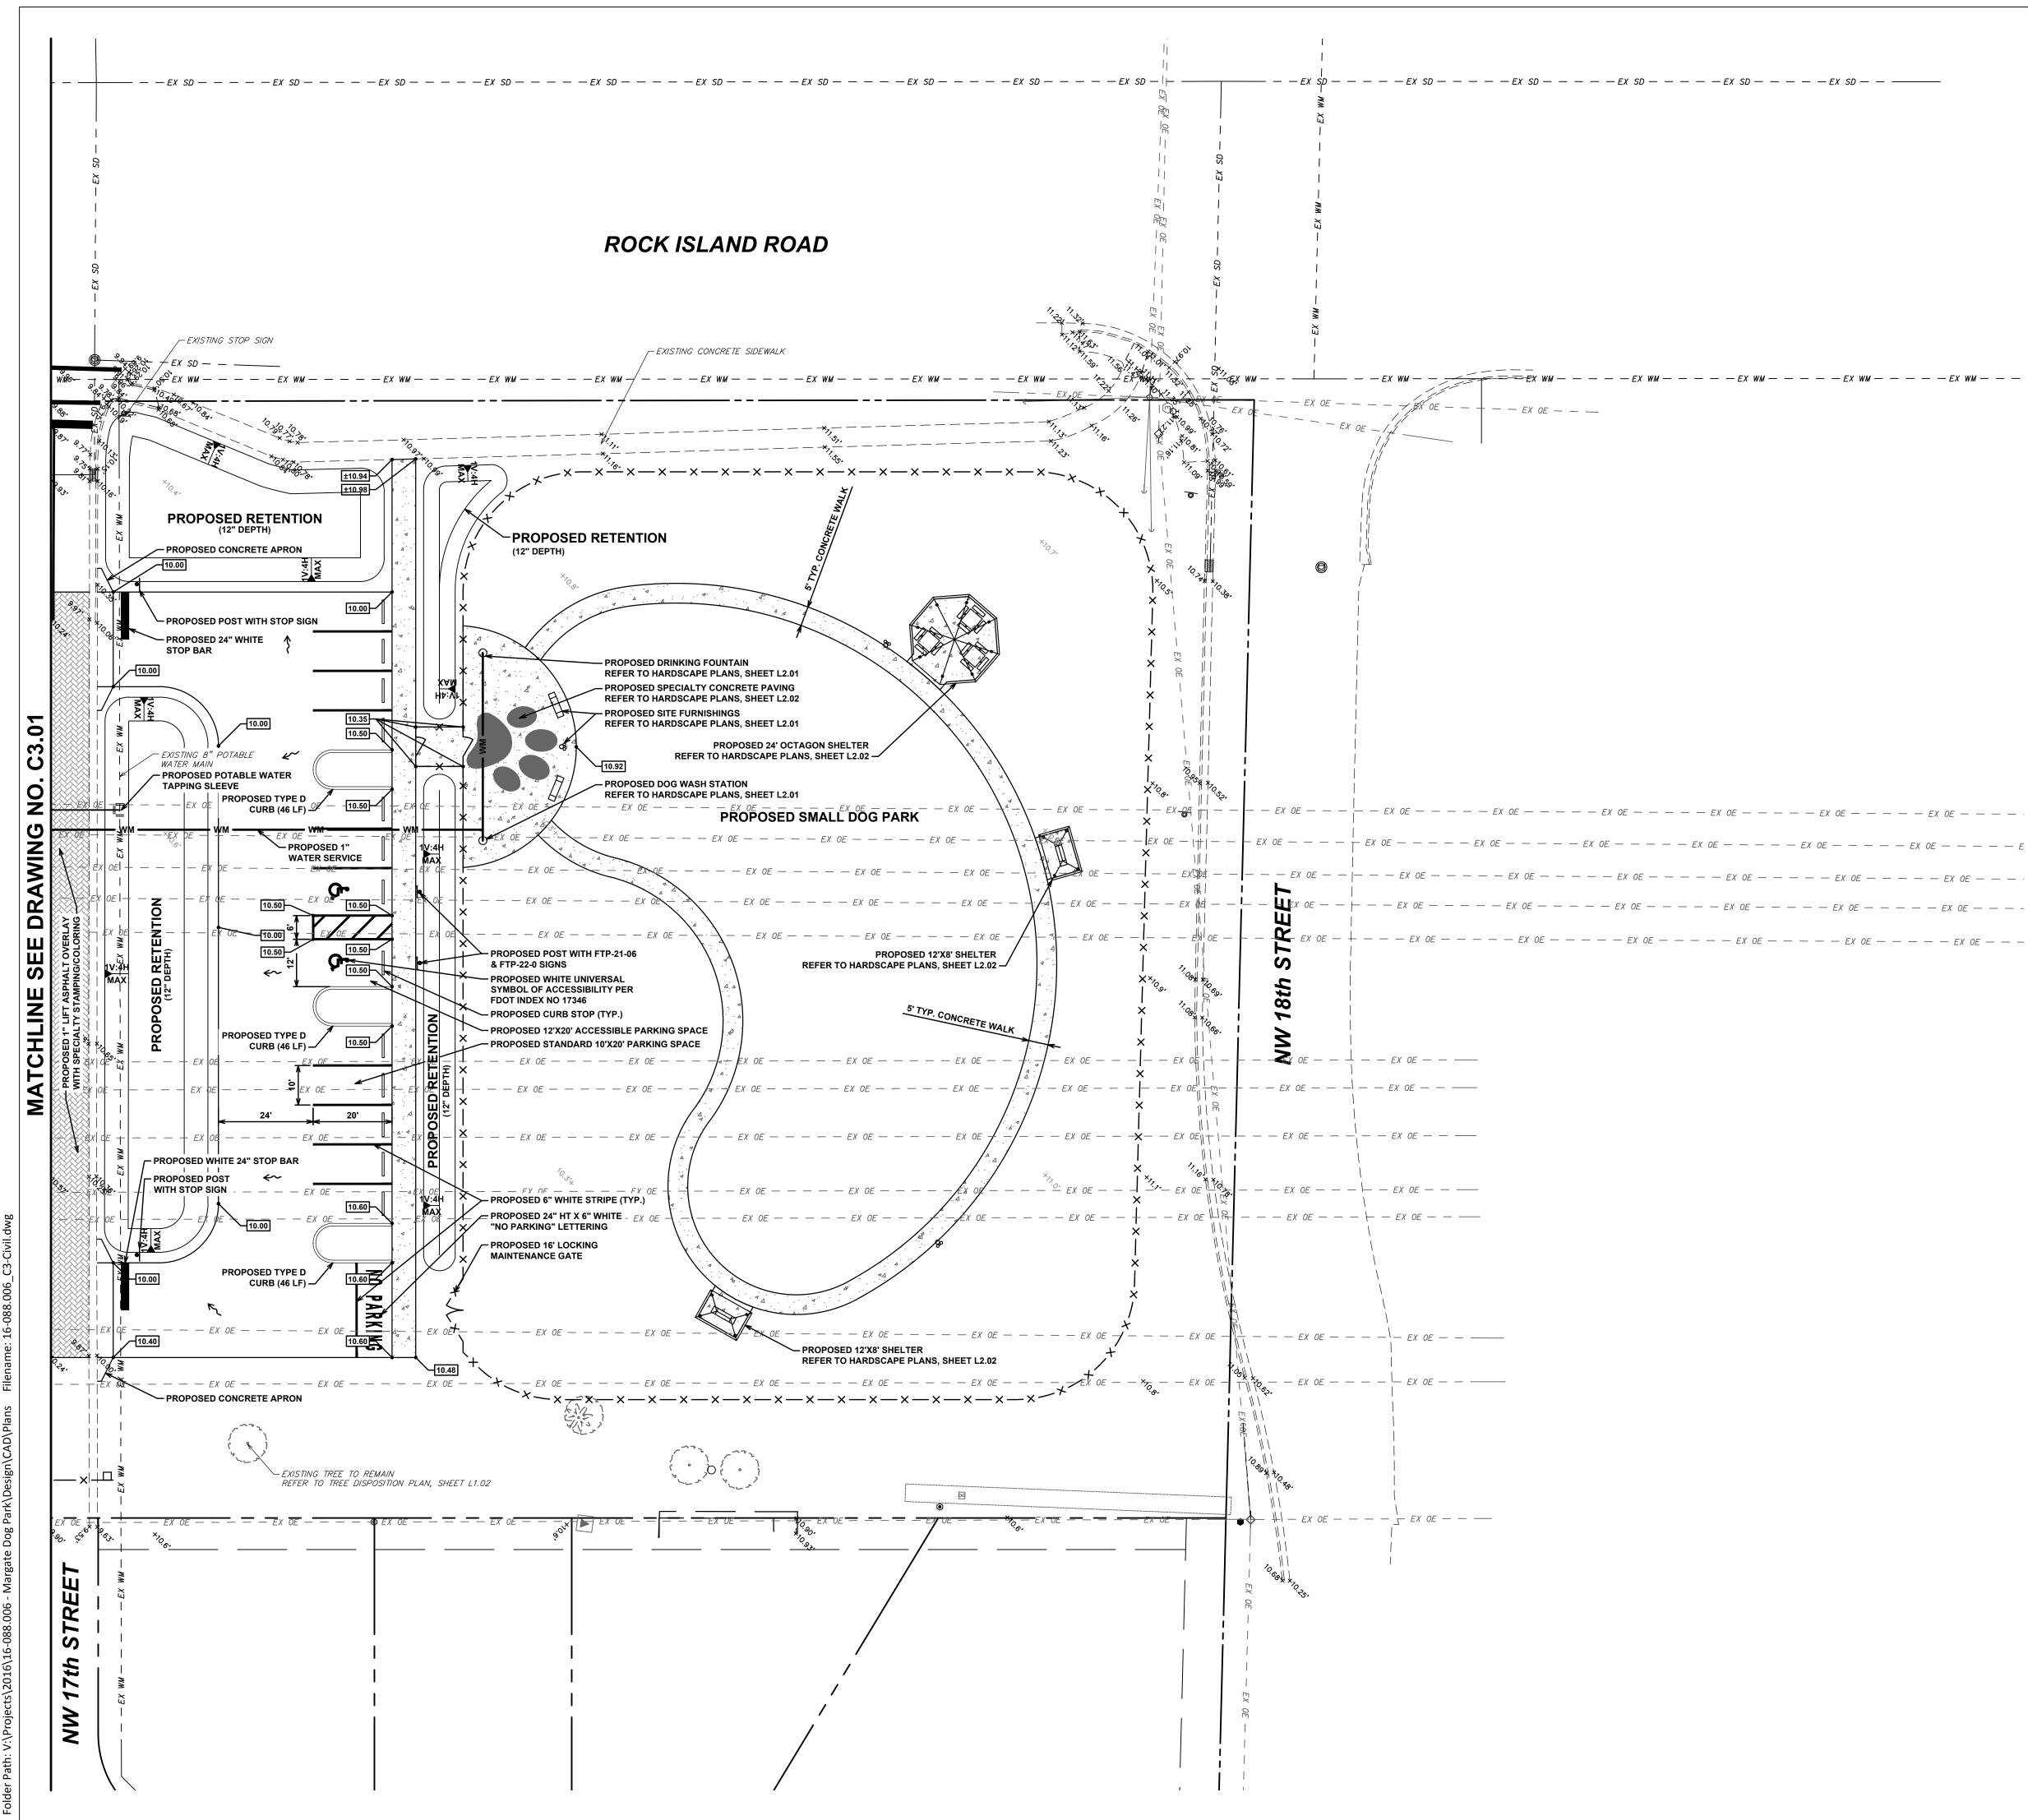
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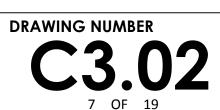
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65% CONSTRUCTION DOCUMENTS



CIVIL PLAN

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CITY OF MARGATE, FLORIDA

PARK





CLIENT


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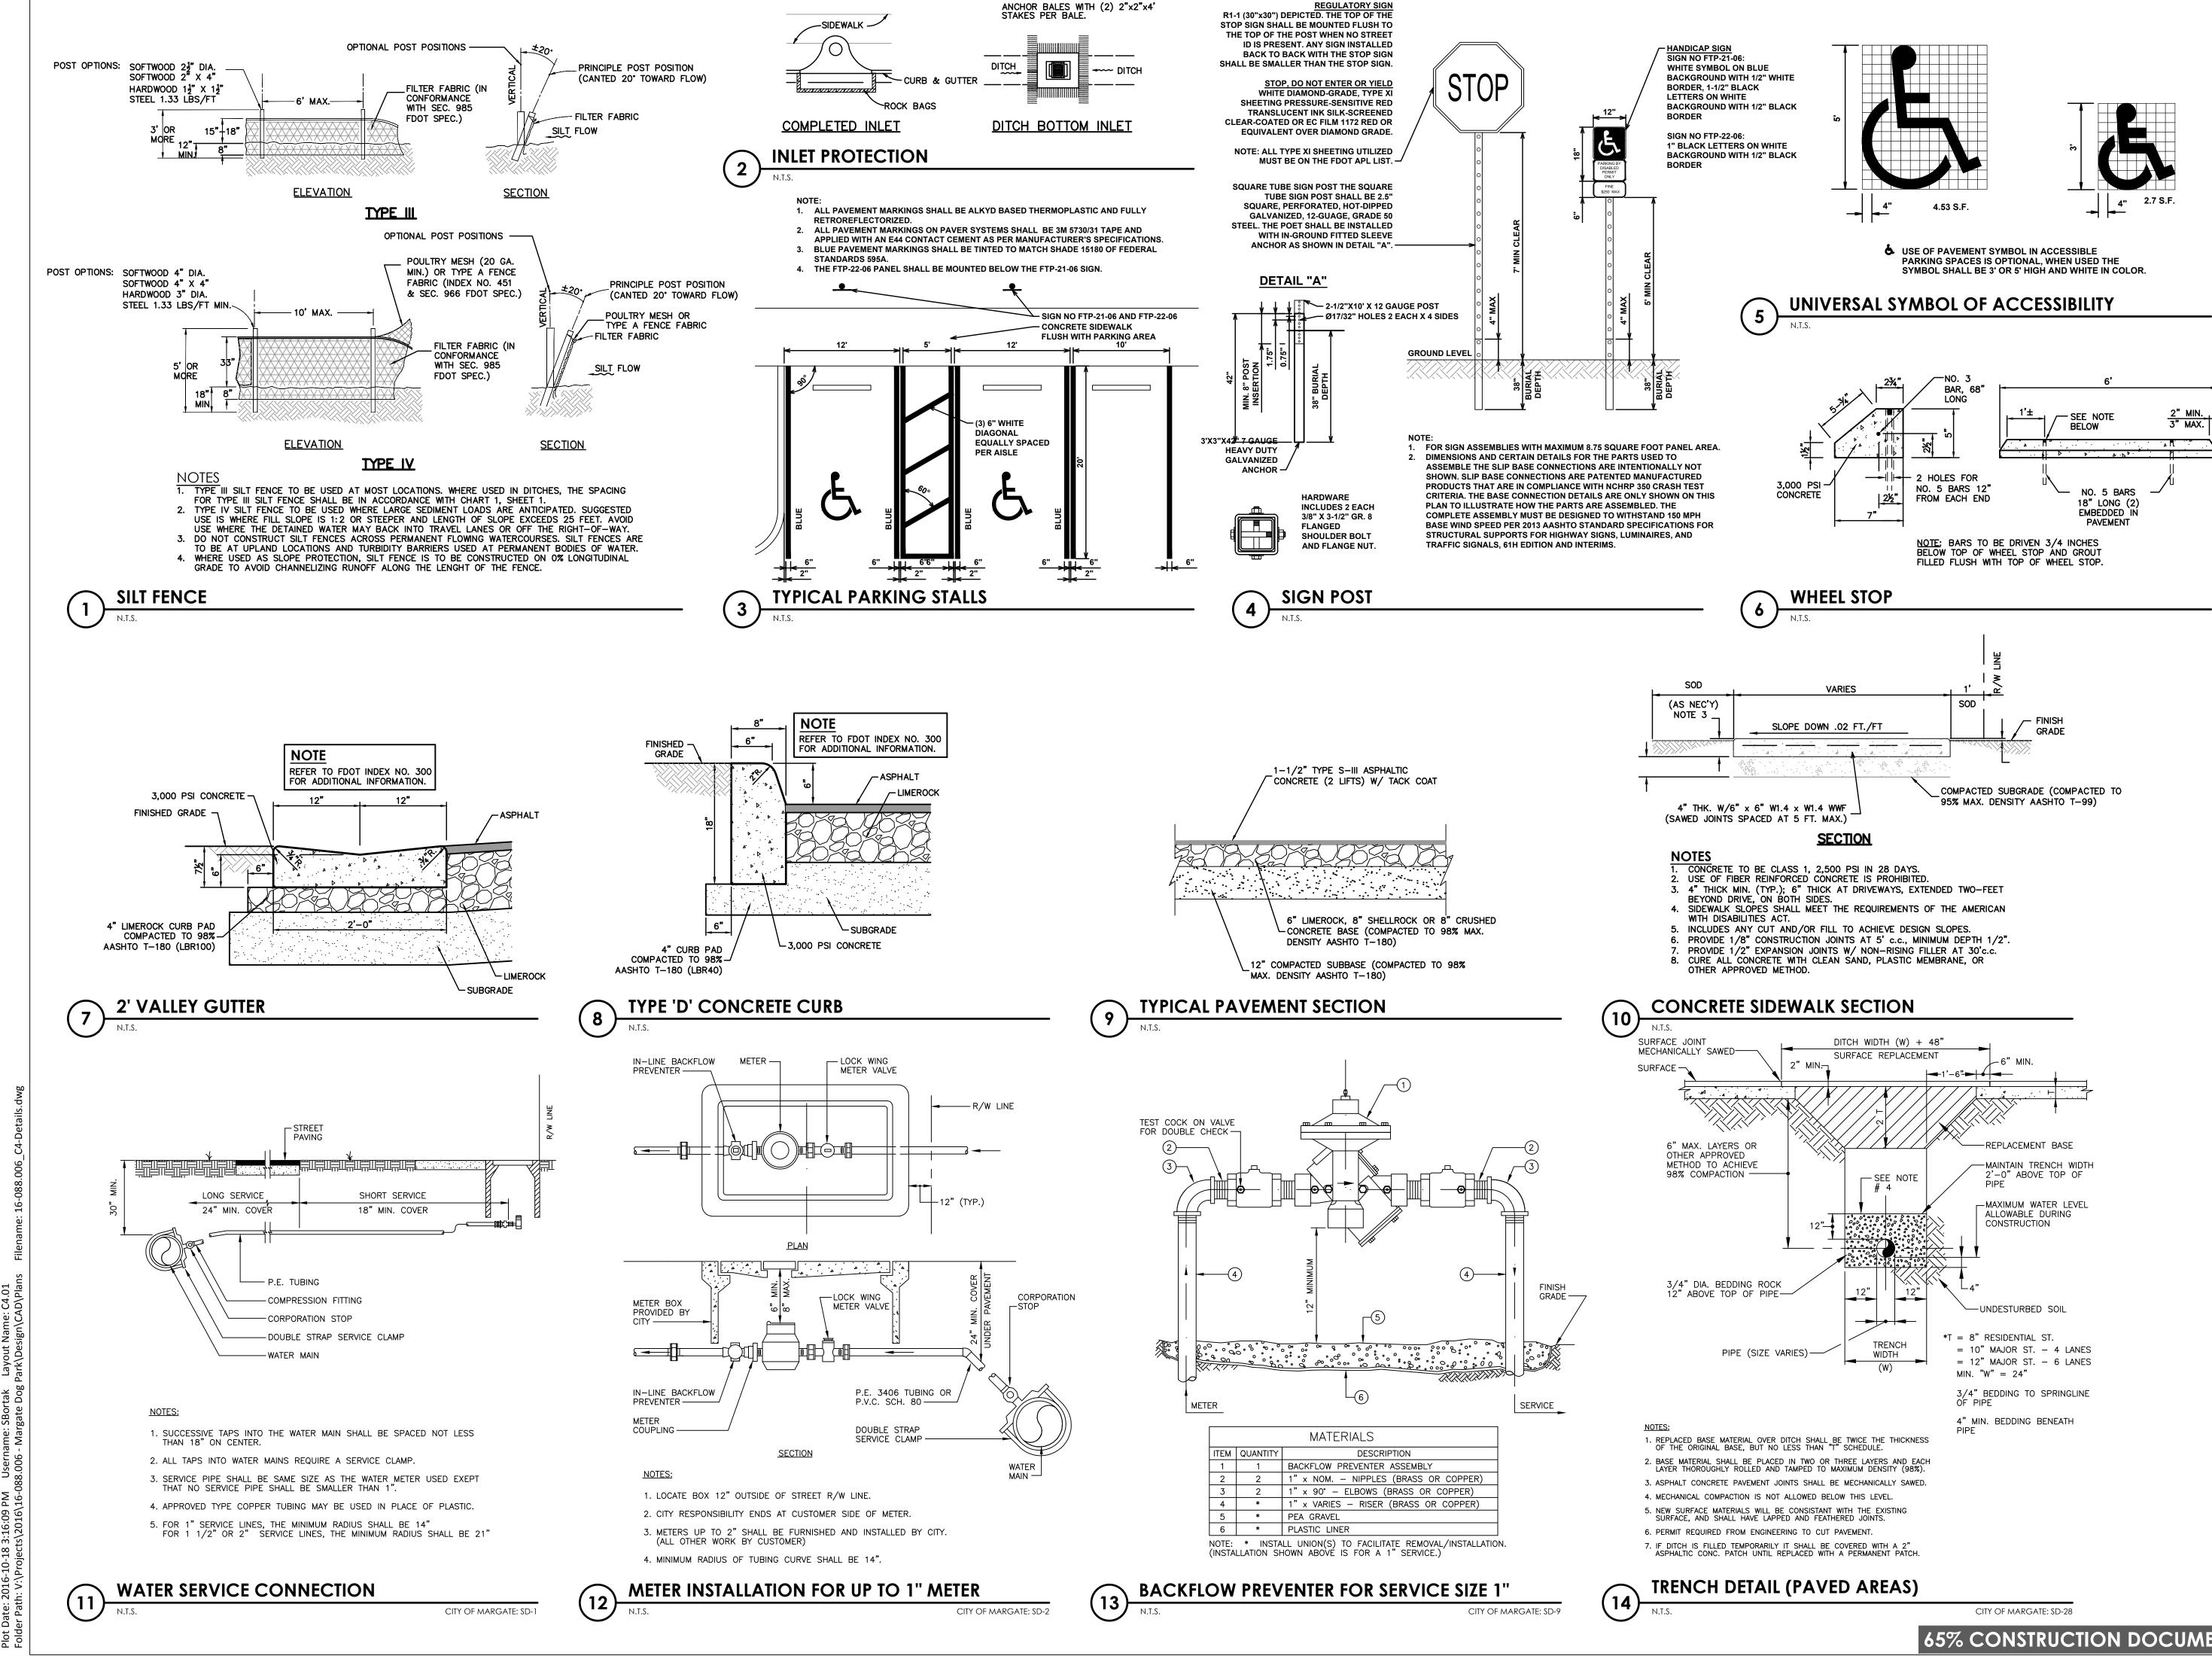
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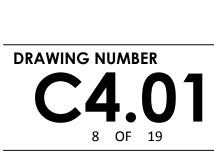
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CIVIL DETAILS

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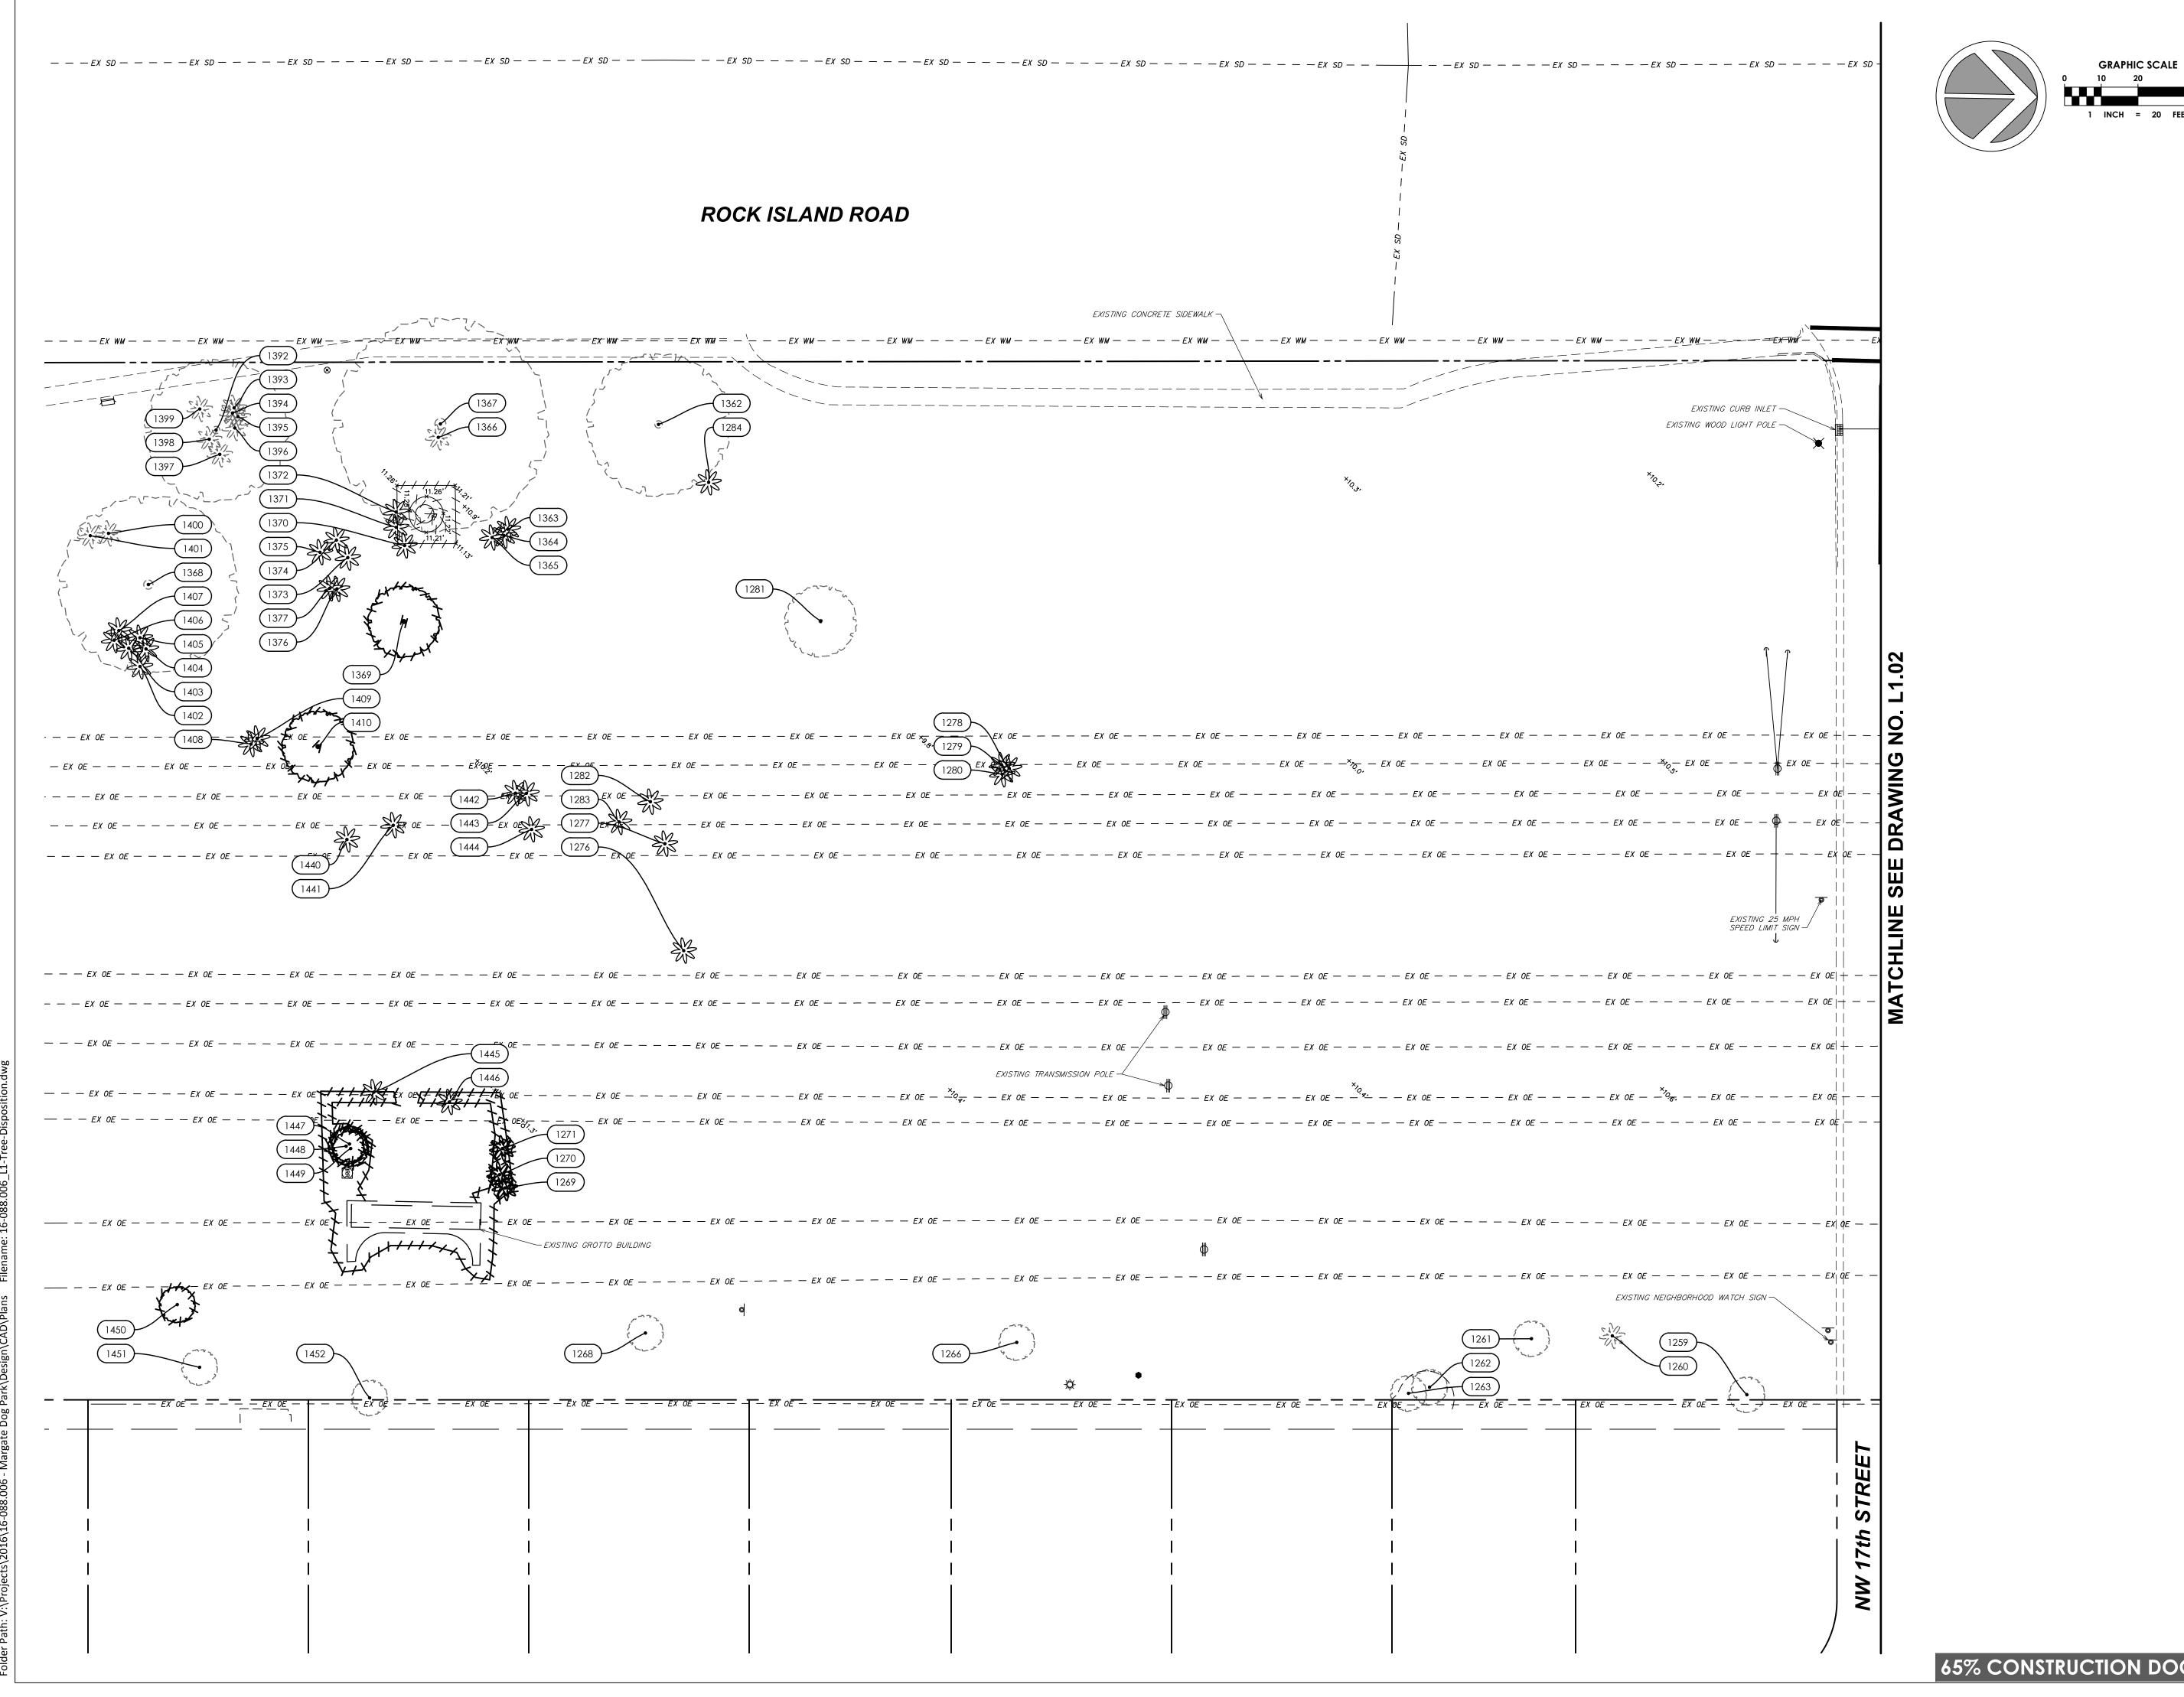
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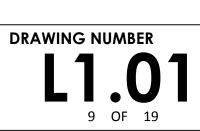
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TREE DISPOSITION PLAN

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DATE OF ISSUE 2016-10-18

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CLIENT PROJECT NUMBER PO#160934

FLORIDA PROJECT NUMBER 16-088.006

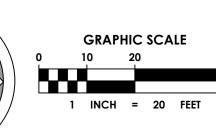CITY OF MARGATE,

MARGATE DOG PARK




SUB-CONSULTANT

CLIENT

REGISTRATION CRISTOBAL A. BETANCOURT REGISTRATION NO. 6666941 DATE

&ASSOCIATES 500 West Cypress Creek Road Suite 630 Ft. Lauderdale, FL 33309 954.730.0707 www.chenmoore.com **CERTIFICATES OF AUTHORIZATION** EB4593 LC26000425

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65% CONSTRUCTION DOCUMENTS
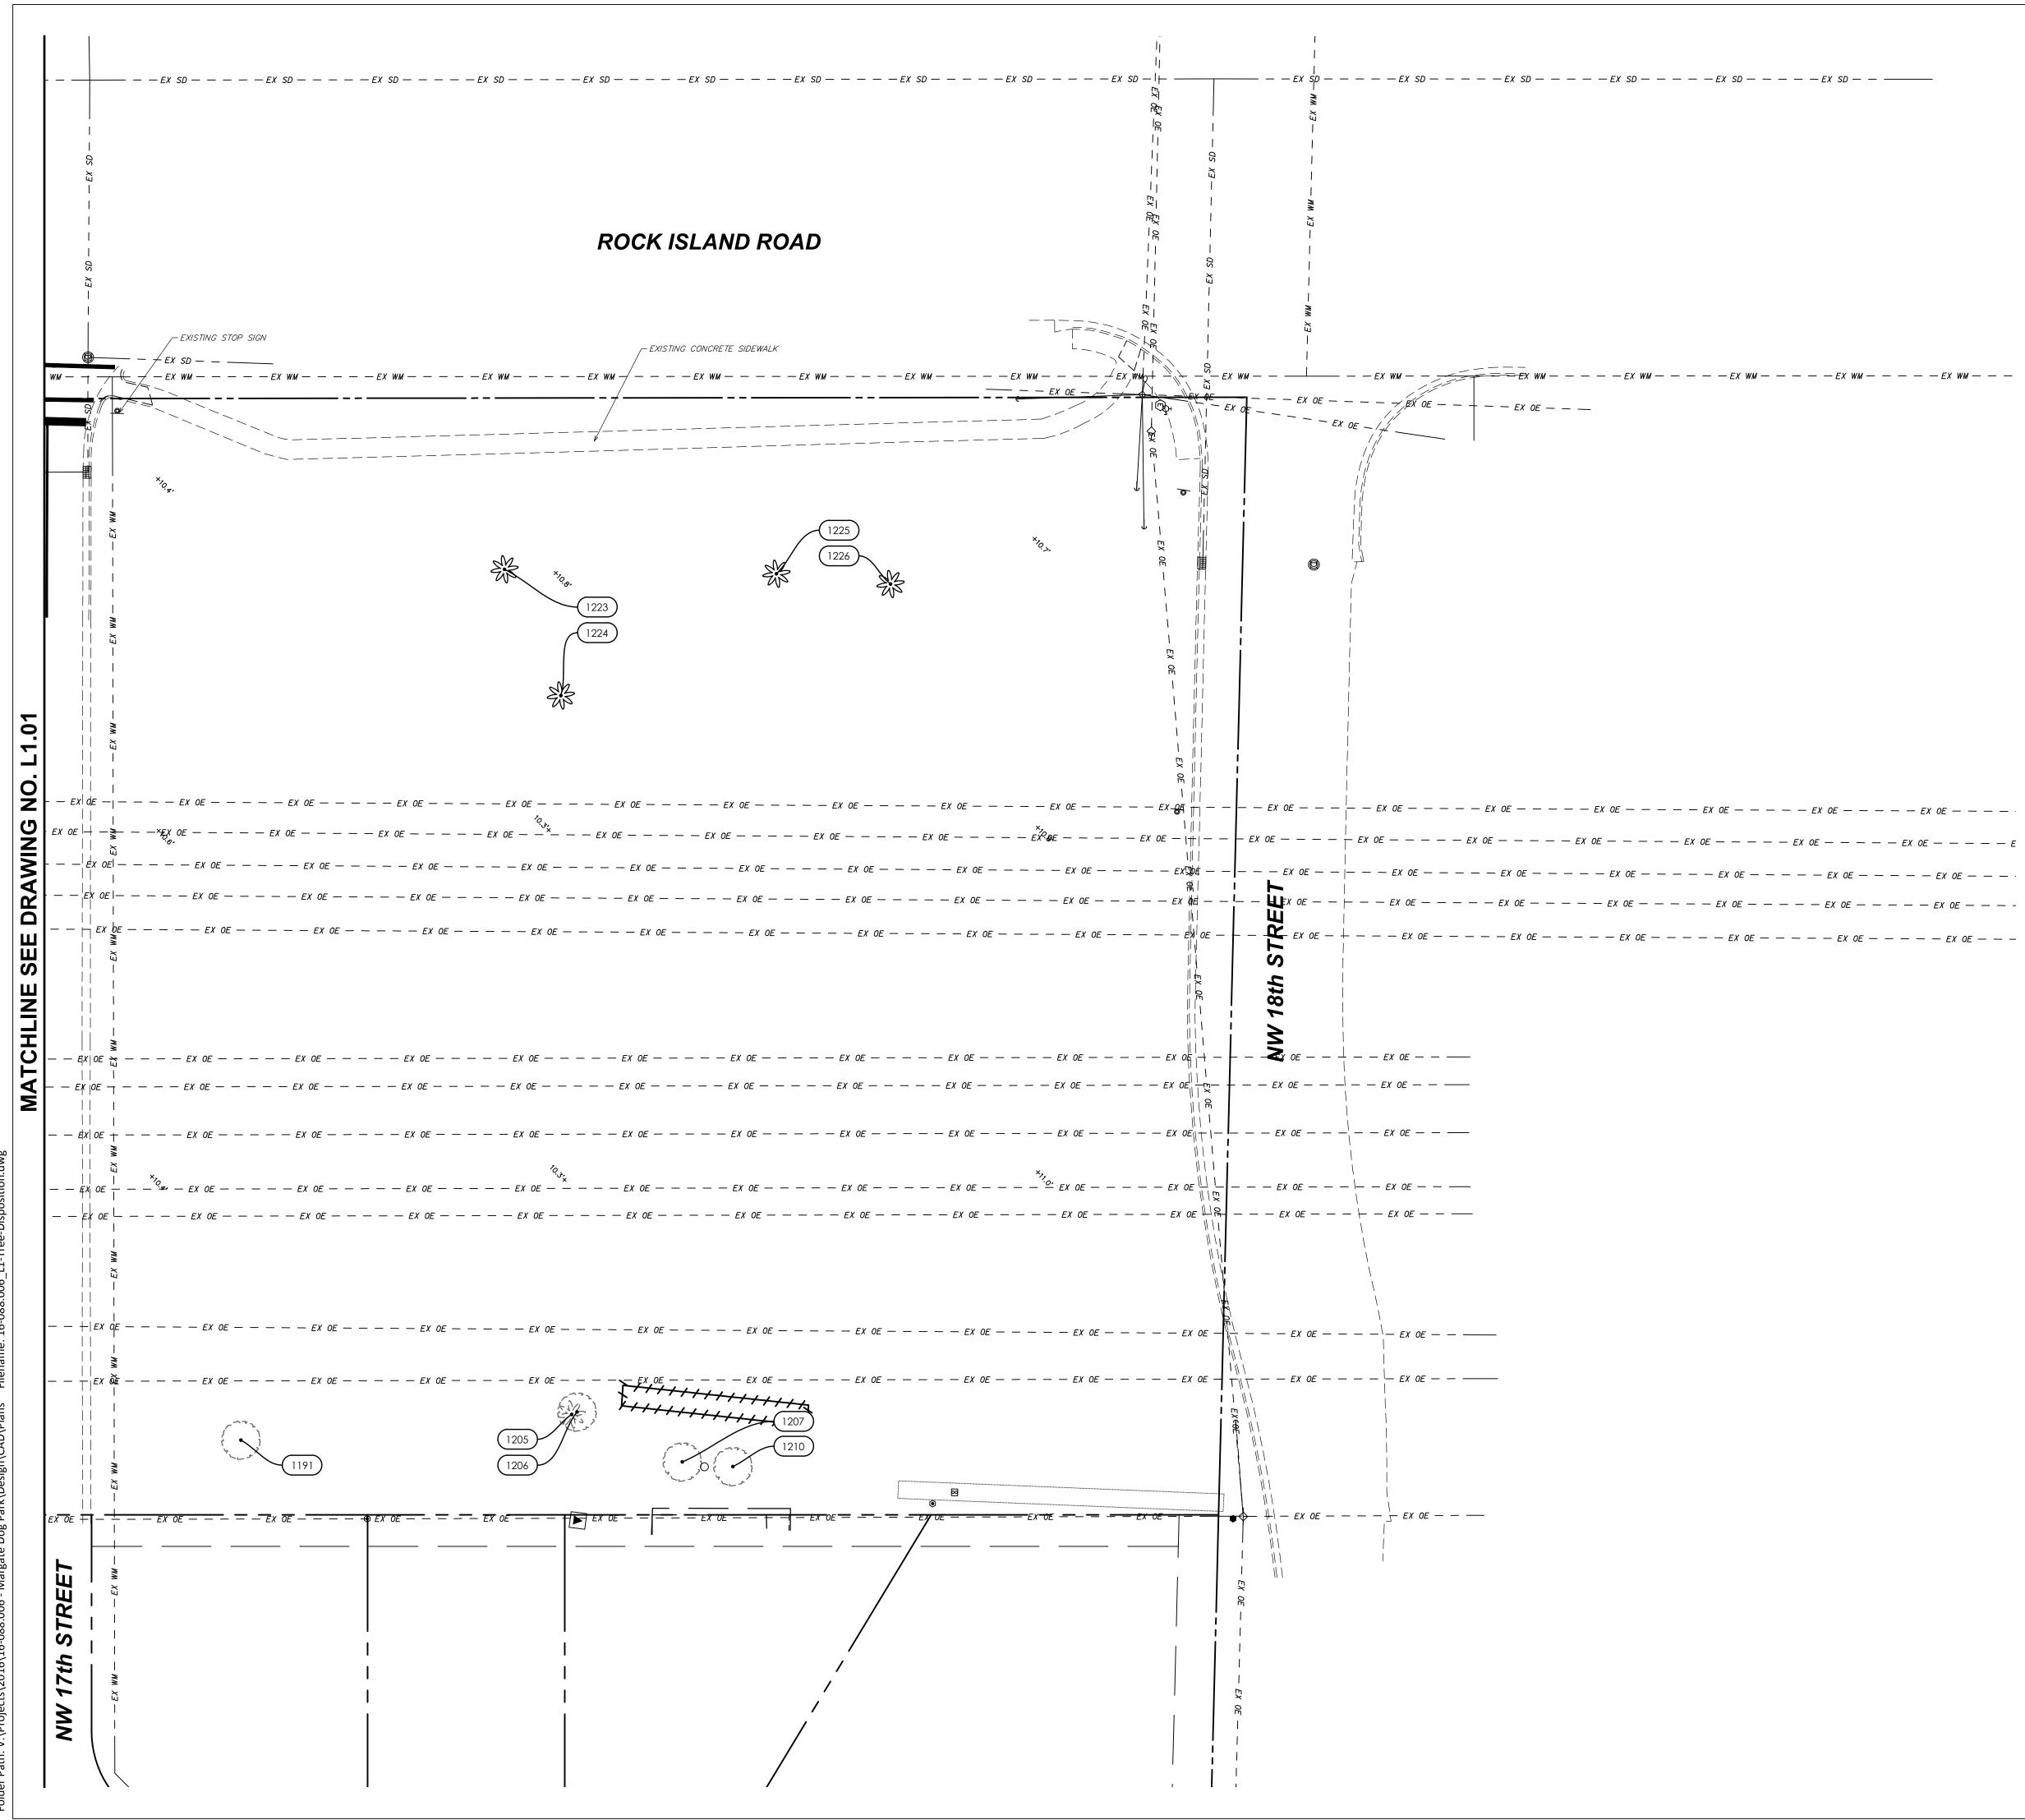
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10 OF 19

TREE DISPOSITION PLAN

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PROJECT NUMBER 16-088.006

CITY OF MARGATE, FLORIDA

PARK

MARGATE DOG

PROJECT INFORMATION



CLIENT

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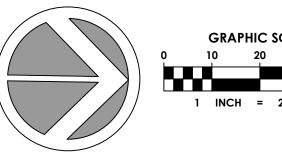
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REGISTRATION NO. 6666941

DATE:

500 West Cypress Creek Road Suite 630 Ft. Lauderdale, FL 33309 954.730.0707 **CERTIFICATES OF AUTHORIZATION**





GRAPHIC SCALE 1 INCH = 20 FEET

ON NOTES

REE ID #	SCIENTIFIC NAME	COMMON NAME	DBH	CONDITION	DISPOSITION	1. ROOT PRUNING AND WATERING I
1191	DELONIX REGIA	ROYAL POINCIANA	5"	CONDITION	DISFOSITION	1.1. TREE ROOT PRUNING AND
1205	SABAL PALMETTO	CABBAGE PALM	15''			CERTIFIED & LICENSED ARBO
1206	QUERCUS VIRGINIANA	OAK TREE	5''			1.2. ROOT PRUNE TREES A MININ
1207	HIBISCUS SPP.	WEEPING HIBISCUS	5''			PRUNING, THOROUGHLY WA
1210	HIBISCUS SPP.	WEEPING HIBISCUS	5''			DAYS PRIOR TO ROOT PRUNI
1223	SABAL PALMETTO	CABBAGE PALM	12''		RELOCATE	1.2.1. PROVIDE TEMPORARY IR
1224	SABAL PALMETTO	CABBAGE PALM	12''		RELOCATE	CONSTRUCTION.
1225	SABAL PALMETTO	CABBAGE PALM	12''		RELOCATE	1.2.2. ROOT PRUNE TREES, SHC
1226	SABAL PALMETTO	CABBAGE PALM	12"		RELOCATE	CONSTRUCTION ACTIVIT
1259	BUCIDA BUCERAS	BLACK OLIVE	12"			THE GREATEST AMOUNT
1260	DYPSIS LUTESCENS	ARECA PALM	36"			1.2.3. BACKFILL TRENCH WITH F
1261	MANGIFERA SPP.	MANGO TREE	6"			1.2.4. FERTILIZE WITHIN THE ROO
1262	MANGIELA SFF.	UNKNOWN TREE	0 4''			1.3. ROOT PRUNING SHALL BE A
1262			4 12''			WHERE PROPOSED SITE WOI
1265	PERSEA SPP. MANGIFERA SPP.	AVOCADO TREE MANGO TREE	5"			DEEP. ROOT PRUNE ONLY V
1268			5 6''			MAXIMUM TRENCH WIDTH O
	BOUGAINVILLEA SPP.	BOUGAINVILLEA				1.4. ALL EXPOSED ROOTS SHALL
1269	DYPSIS LUTESCENS	ARECA PALM	36''		REMOVE	WITH SOIL CONSISTING OF 3
1270	DYPSIS LUTESCENS	ARECA PALM	36''		REMOVE	
1271	DYPSIS LUTESCENS	ARECA PALM	36''		REMOVE	PRUNING, AND ONCE WE
1276	SABAL PALMETTO	CABBAGE PALM	15''		RELOCATE	FERTILIZER THAT HAS A 20.20.2
1277	SABAL PALMETTO	CABBAGE PALM	18''		RELOCATE	2. BRACING AND GUYING OF TREES
1278	SABAL PALMETTO	CABBAGE PALM	18''		RELOCATE	2.1. BRACING AND GUYING SH
1279	SABAL PALMETTO	CABBAGE PALM	18''		RELOCATE	REGENERATION PERIOD; AS F
1280	SABAL PALMETTO	CABBAGE PALM	18''		RELOCATE	3. <u>ROOT ZONE PROTECTION</u>
1281	LYSILOMA BAHAMENSIS	WILD TAMARIND	18''			3.1. DURING THE ENTIRE CONSTRU
1282	SABAL PALMETTO	CABBAGE PALM	18''		RELOCATE	THE ROOT ZONE FROM DAM
1283	SABAL PALMETTO	CABBAGE PALM	12''		RELOCATE	TREES. ALL PLANT MATERI
1284	SABAL PALMETTO	CABBAGE PALM	10"		RELOCATE	CONSTRUCTION, SHALL BE P
1362	FICUS MACROCARPA	FICUS TREE	60''			WILL INCLUDE CONSTRUCTI
1363	SABAL PALMETTO	CABBAGE PALM	10''		RELOCATE	PROTECT THE ROOT ZONES O
1364	SABAL PALMETTO	CABBAGE PALM	12''		RELOCATE	3.2. A PROTECTION BARRIER OR
1365	SABAL PALMETTO	CABBAGE PALM	12''		RELOCATE	AROUND EACH TREE TO BE F
1366	SABAL PALMETTO	CABBAGE PALM	10''			PRIOR TO THE ACTUAL CO
1367	FICUS ELASTICA	RUBBER TREE	36''			PROJECT.
1368	QUERCUS VIRGINIANA	OAK TREE	24''			3.3. TREE BARRICADE FENCING SI
1369	DIMOCARPUS LONGAN	LONGAN TREE	15''		REMOVE	
1370	SABAL PALMETTO	CABBAGE PALM	12''		RELOCATE	حكرح
1371	SABAL PALMETTO	CABBAGE PALM	12''		RELOCATE	
1372	SABAL PALMETTO	CABBAGE PALM	6''		RELOCATE	
1373	SABAL PALMETTO	CABBAGE PALM	10''		RELOCATE	A Stand
1374	SABAL PALMETTO	CABBAGE PALM	12"		RELOCATE	
1375	SABAL PALMETTO	CABBAGE PALM	12"		RELOCATE	
1376	SABAL PALMETTO	CABBAGE PALM	12"		RELOCATE	Ca for concerterie
1370		CABBAGE PALM	12 8''			· Cr
	SABAL PALMETTO				RELOCATE	
1392	FICUS MACROCARPA	FICUS TREE	48''			
1393	SABAL PALMETTO	CABBAGE PALM	12"			
1394	SABAL PALMETTO	CABBAGE PALM	10''			
1395	SABAL PALMETTO	CABBAGE PALM	6''			
1396	SABAL PALMETTO	CABBAGE PALM	12''			
1397	SABAL PALMETTO	CABBAGE PALM	15''			
1398	SABAL PALMETTO	CABBAGE PALM	12''			NO ENTRY OR STORAGE NO DRIP LINE
1399	SABAL PALMETTO	CABBAGE PALM	15''			
1400	DYPSIS LUTESCENS	ARECA PALM	36''			
1401	SABAL PALMETTO	CABBAGE PALM	10''			
1402	SABAL PALMETTO	CABBAGE PALM	6''		RELOCATE	4' MIN.
1403	SABAL PALMETTO	CABBAGE PALM	8''		RELOCATE	
1404	SABAL PALMETTO	CABBAGE PALM	12''		RELOCATE	$+\frac{1}{2}$
1405	SABAL PALMETTO	CABBAGE PALM	6''		RELOCATE	2' MIN.
1406	SABAL PALMETTO	CABBAGE PALM	12''		RELOCATE	L XXXXXXXXXXXXXXXXXXXXXXXXXXXXXXXXXXXX
1407	SABAL PALMETTO	CABBAGE PALM	6''		RELOCATE	
1408	SABAL PALMETTO	CABBAGE PALM	12''		RELOCATE	
1409	SABAL PALMETTO	CABBAGE PALM	12"		RELOCATE	TREE PRESERV
1410	LAGERSTROEMIA SPP.	CRAPE MYRTLE	6"		REMOVE	1/4" = 1'-0"
1410	SABAL PALMETTO	CABBAGE PALM	0 4''		RELOCATE	-
1440	SABAL PALMETTO	CABBAGE PALM	4 12''		RELOCATE	
1442 1442	SABAL PALMETTO	CABBAGE PALM	12'' 12''		RELOCATE	
1443	SABAL PALMETTO	CABBAGE PALM	12"		RELOCATE	
1444	SABAL PALMETTO	CABBAGE PALM	12"		RELOCATE	
1445	SABAL PALMETTO	CABBAGE PALM	12''		RELOCATE	
1446	SABAL PALMETTO	CABBAGE PALM	12''		RELOCATE	
1447	QUERCUS VIRGINIANA	OAK TREE	4''		REMOVE	
1448	QUERCUS VIRGINIANA	OAK TREE	3''		REMOVE	
1449	QUERCUS VIRGINIANA	OAK TREE	4''		REMOVE	
1450	CARICA PAPAYA	PAPAYA TREE	6''		REMOVE	
1451	MANGIFERA SPP.	MANGO TREE	18''			

Bortak ate Dog Ma - 000.088 088.006 -3:17:09 PM ts\2016\16-(NG PRIOR TO CONSTRUCTION:

and trimming, shall be performed under the supervision of a

INIMUM OF EIGHT (8) WEEKS PRIOR TO CONSTRUCTION. PRIOR TO ROOT WATER THE ROOT ZONE WITH AT LEAST 2 TO 3 INCHES OF WATER FOR 2 TO 3 UNING. SEE BELOW FOR RELOCATION TIMELINE.

Y IRRIGATION FOR EACH TREE THROUGHOUT THE DURATION OF

SHOWN ON PLAN IN AREAS WHERE ROOTS WILL CONFLICT WITH

TIVITY. PRUNING OF ROOTS SHOULD BE DONE IN A MANNER TO PRESERVE UNT OF THE ROOT BASE AS POSSIBLE.

/ITH PLANTING SOIL.

ROOT ZONE (SEE NOTE 1.4).

E ACCOMPLISHED BY DIGGING A TRENCH AROUND THE TREE IN AREAS WORK WILL BE PERFORMED. TRENCHING SHALL BE AT A MINIMUM OF 24" ILY WITH A MECHANICAL ROOT-PRUNING SAW OR A TRENCHER WITH A

ALL BE CUT OFF SMOOTHLY, WITH SHARP INSTRUMENTS. BACKFILL TRENCHES OF 30% SILICA SAND AND 70% MUCK. WATER THOROUGHLY AFTER ROOT WEEKLY DURING THE ROOT REGENERATION PERIOD, WITH A SOLUBLE 0.20.20 ANALYSIS AT MANUFACTURER'S RECOMMENDED RATE.


REES AFTER ROOT PRUNING

SHALL BE PROVIDED TO ASSURE THE TREES' STABILITY DURING THE ROOT AS PER THE APPLICABLE DETAIL(S).

STRUCTION PERIOD ALL REASONABLE EFFORTS SHALL BE MADE TO PROTECT DAMAGE. TREE PROTECTION BARRICADING SHALL BE ERECTED AROUND THE TERIAL DESIGNATED TO BE SAVED, OR OUTSIDE OF THE LIMITS OF BE PROTECTED DURING CONSTRUCTION WORK. WORK UNDER THESE ITEMS JCTION AND MAINTENANCE OF TEMPORARY BARRICADE FENCING TO ES OF EXISTING TREES AND OTHER PLANTINGS.

OR TEMPORARY FENCE OF AT LEAST 4 FEET IN HEIGHT SHALL BE INSTALLED BE PROTECTED AND PRESERVED. THE TREE PROTECTION SHALL BE INSTALLED CONSTRUCTION START AND MAINTAINED FOR THE DURATION OF THE

JG SHALL BE; AS PER THE APPLICABLE DETAIL(S).

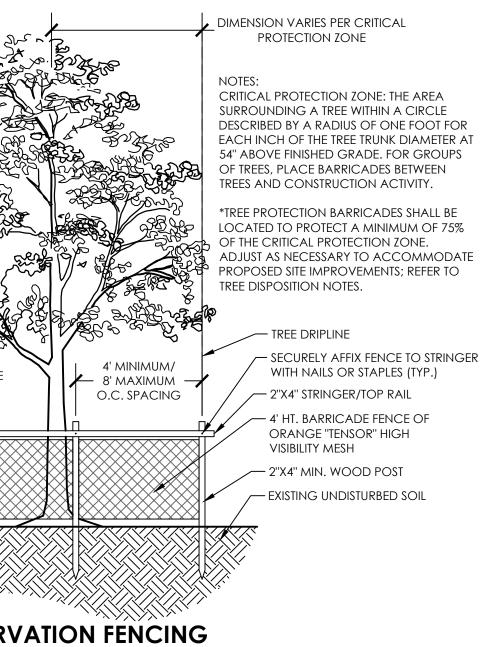

32 9343-24

65% CONSTRUCTION DOCUMENTS



SPECIFICATIONS

TREE DISPOSITION CHART AND

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CITY OF MARGATE,

MARGATE DOG PARK



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CLIENT


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REGISTRATION


EB4593 LC26000425

&ASSOCIATES 500 West Cypress Creek Road Suite 630 Ft. Lauderdale, FL 33309 954.730.0707 www.chenmoore.com **CERTIFICATES OF AUTHORIZATION**

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HARDSCAPE

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MARGATE DOG PARK

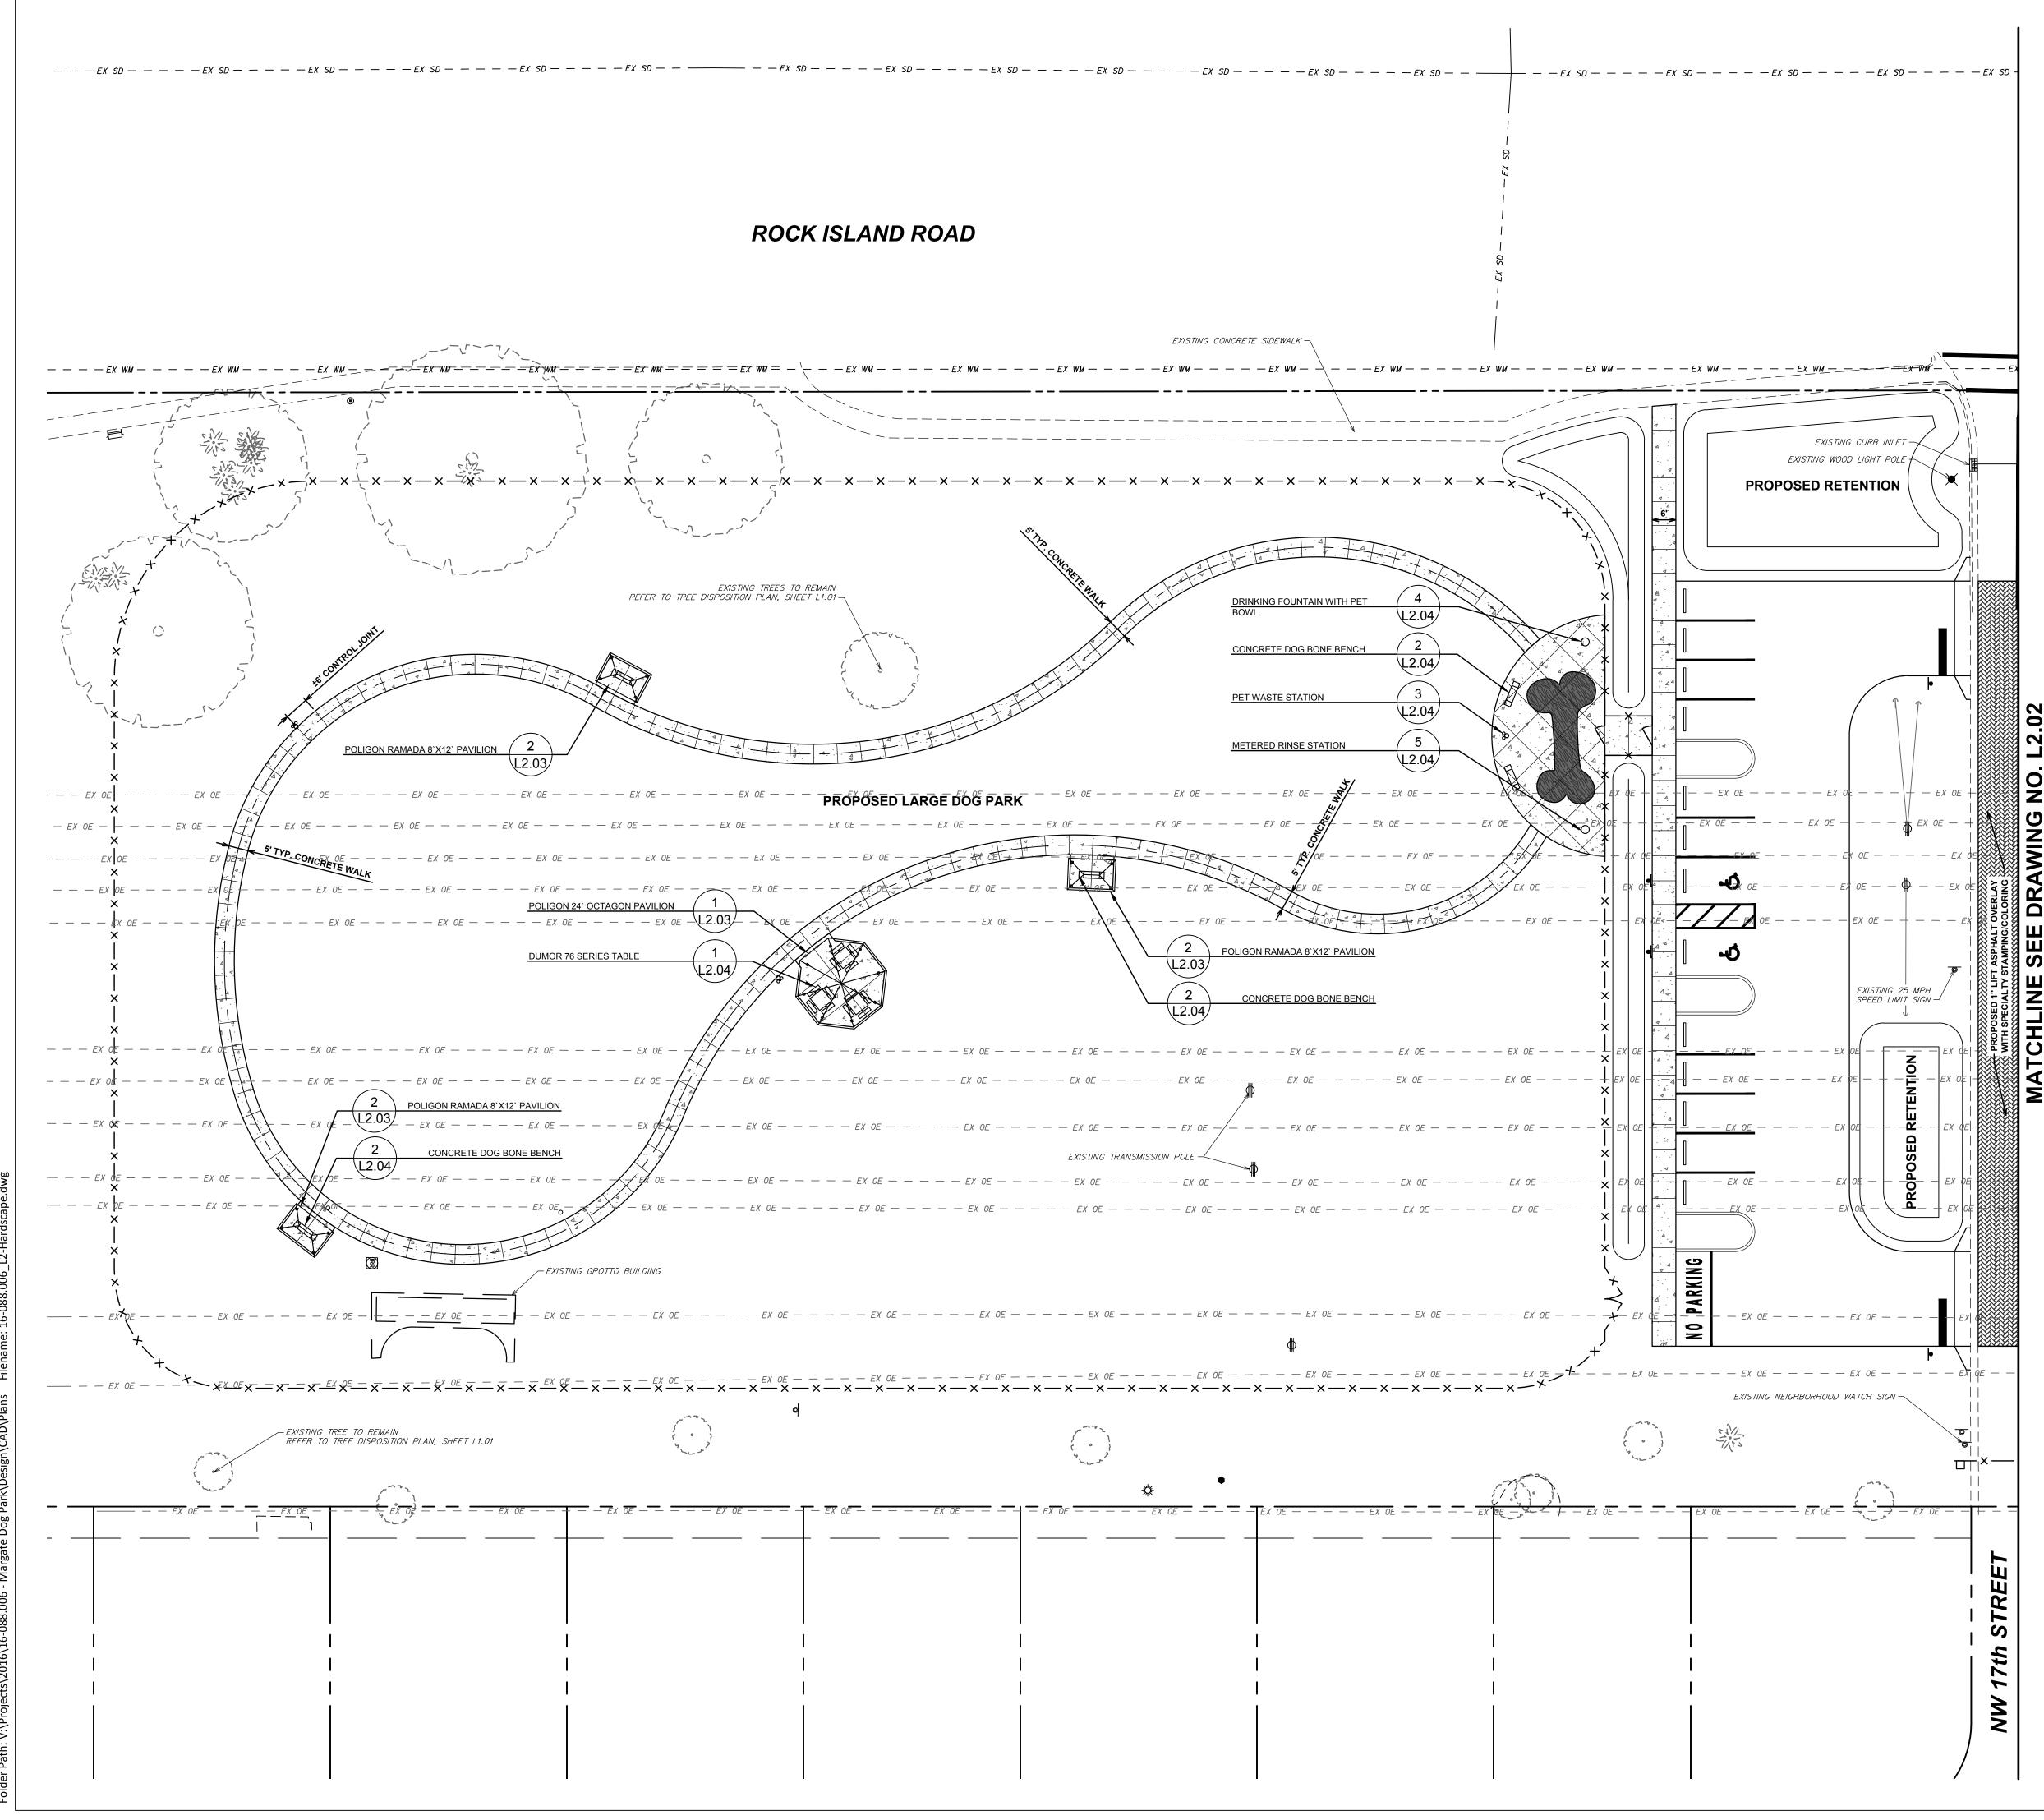
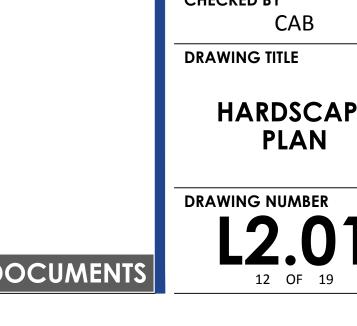
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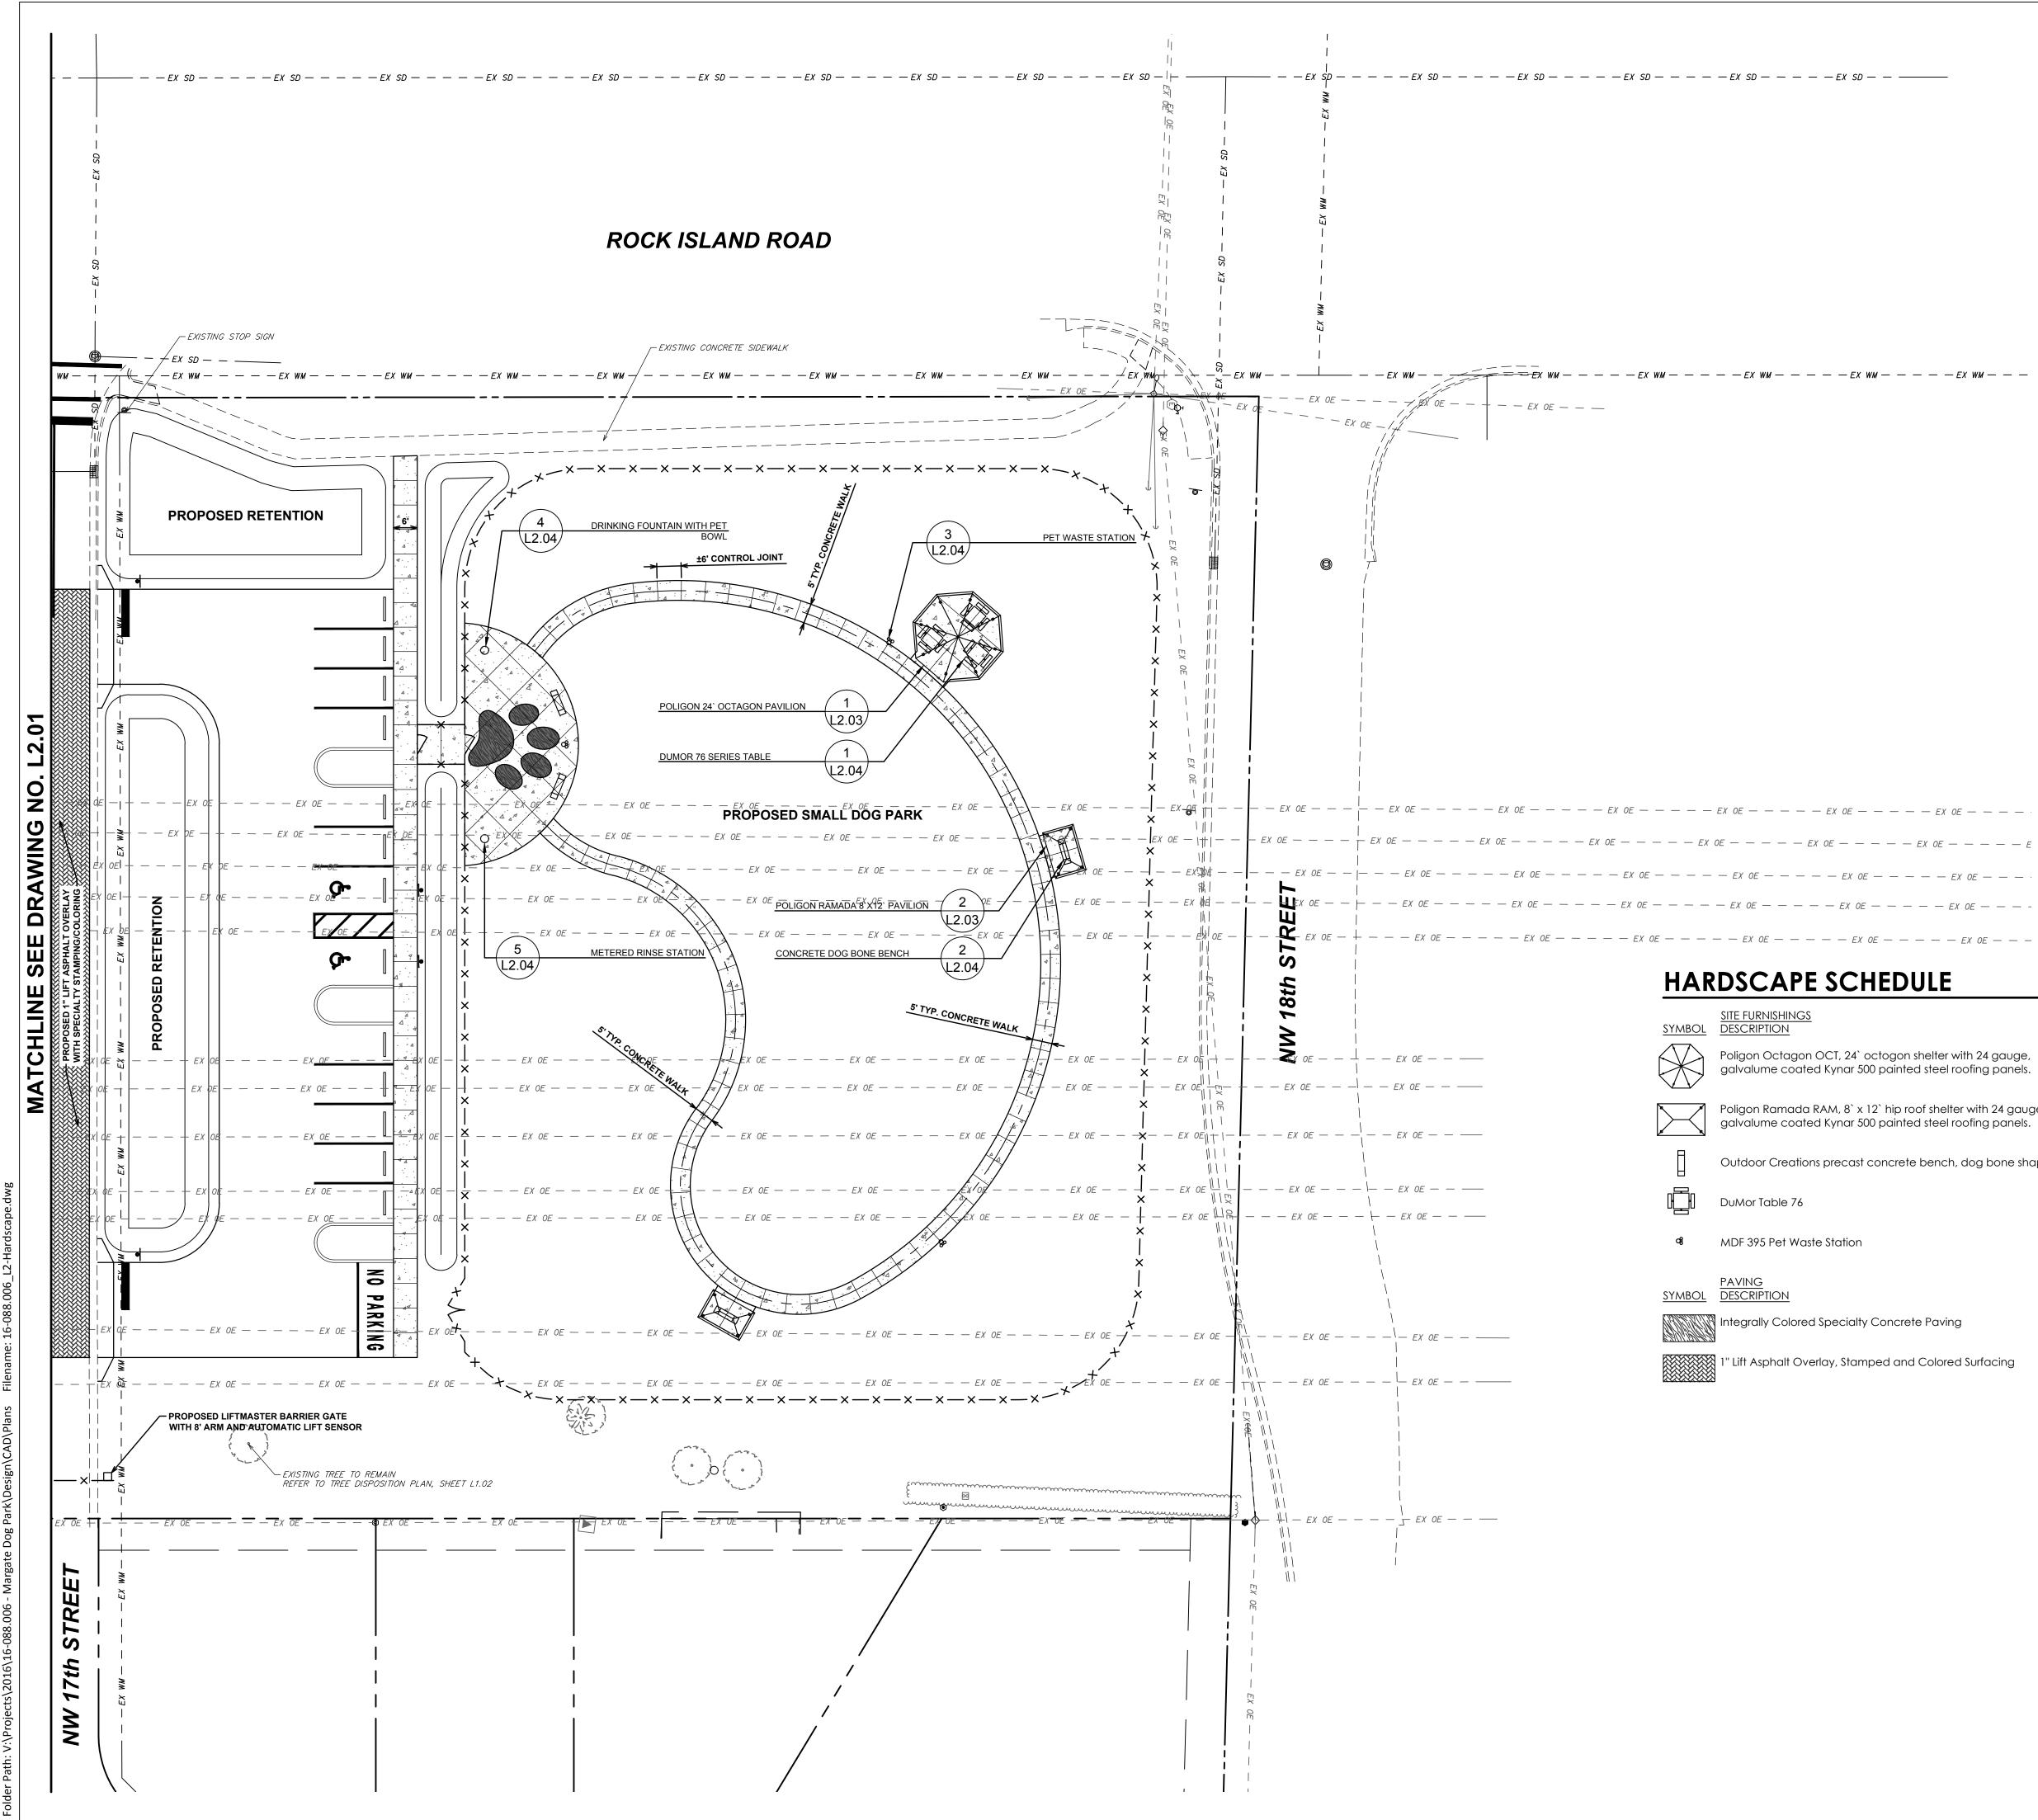
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GRAPHIC SCALE

1 INCH = 20 FEET



Layout Park\De SBortak gate Dog 016-10-18 3:18:34 PM Username: V:\Projects\2016\16-088.006 - Ma

	GRAPHIC SCALE 10 20 40 10 20 40 1 INCH = 20 FEET	CHEN-MODE CHEN-MODE CASSOCIATES Soo West Cypress Creek Roa Suite 630 Ft. Lauderdale, FL 33309 954.730.0707 Www.chenmoore.com CERTIFICATES OF AUTHORIZAT EB4593 LC26000425
		REGISTRATION CRISTOBAL A. BETANCOUR REGISTRATION NO. 666694 DATE:
ИМ — — — — — EX WM — — —		
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		CLIENT
— — — EX OE — — — — E		CITY OF MARGATE Together We Make It Great
— — — — EX OE — — —		PROJECT INFORMATION

— — — — EX OE — — —

	<u>QTY</u>	DETAIL	MANUFACTURER	MODEL
T, 24` octogon shelter with 24 gauge, mar 500 painted steel roofing panels.	2		Poligon	Octagon OCT-24
1, 8` x 12` hip roof shelter with 24 gauge, mar 500 painted steel roofing panels.	5		Poligon	Ramada RAM-8X12
ecast concrete bench, dog bone shape.	9		Outdoor Creations	499
	6		DuMor	76-4
ation	6		MDF	395-SM
	<u>QTY</u>	DETAIL	MANUFACTURER	COLOR
ecialty Concrete Paving	571 sf	4/L2.03	Scofield	Chromix Brownstone, 1010
, Stamped and Colored Surfacing	3,859 sf			

65% CONSTRUCTION DOCUMENTS

PARK

MARGATE DOG

CITY OF MARGATE, FLORIDA PROJECT NUMBER

16-088.006

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PO#160934

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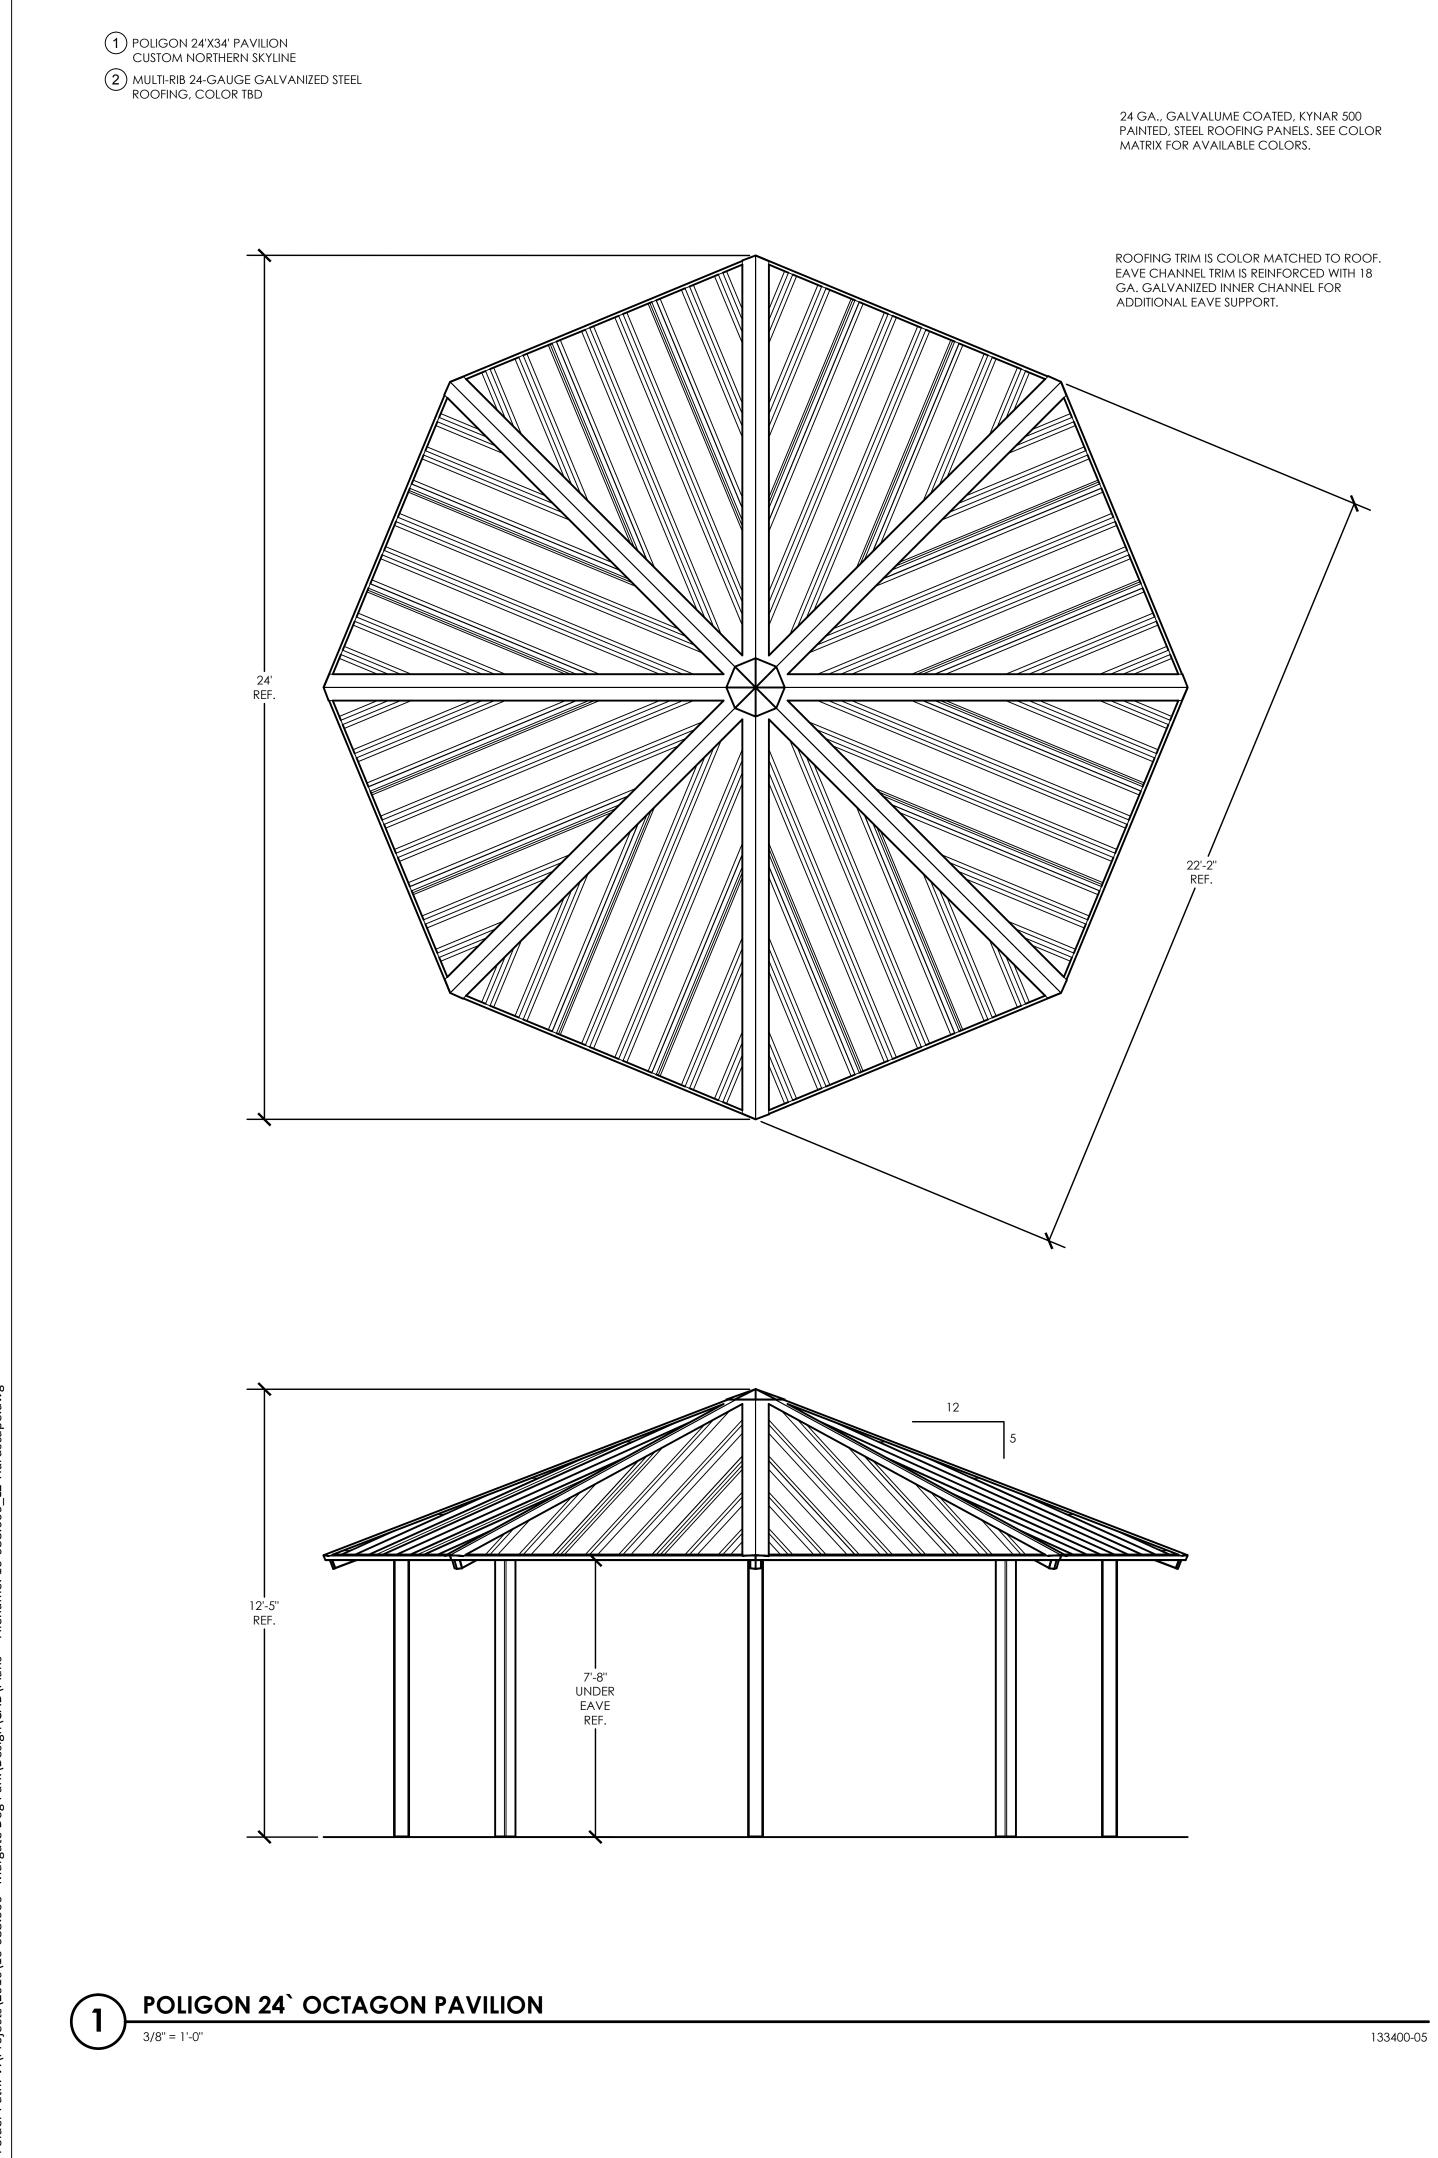
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HARDSCAPE

PLAN

13 OF 19





SBortak gate Dog 18 3:18:35 PM Username: jects\2016\16-088.006 - Mai : 2016-10[.] th: V:\Pro Date: ler Pat

1 POLIGON 24'X34' PAVILION CUSTOM NORTHERN SKYLINE 2 MULTI-RIB 24-GAUGE GALVANIZED STEEL ROOFING, COLOR TBD

24 GA., GALVALUME COATED, KYNAR 500 PAINTED, STEEL ROOFING PANELS. SEE COLOR MATRIX FOR AVAILABLE COLORS.

ROOFING TRIM IS COLOR MATCHED TO ROOF. EAVE CHANNEL TRIM IS REINFORCED WITH 18 GA. GALVANIZED INNER CHANNEL FOR ADDITIONAL EAVE SUPPORT.

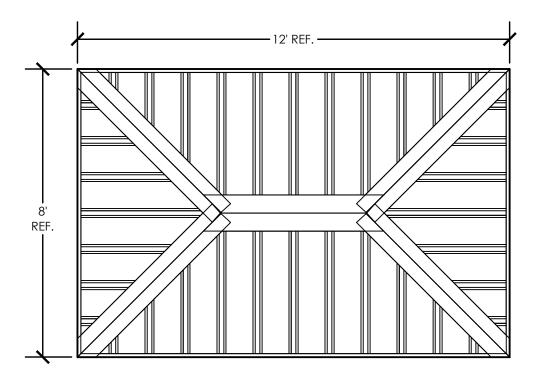


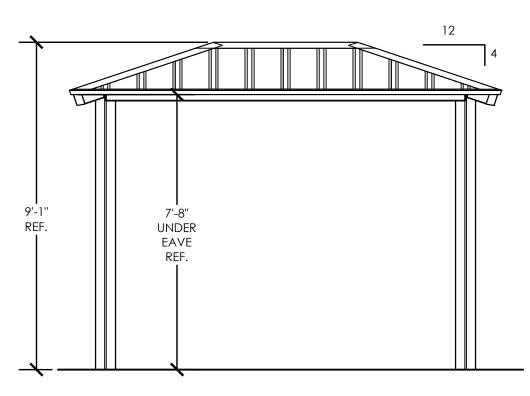



65% CONSTRUCTION DOCUMENTS

14 OF 19

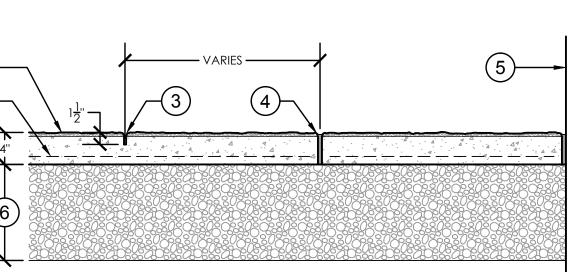

TEXTURED CONCRETE PAVING

TYPICAL 1/4" TOOLED -

TYPICAL 1/4" TOOLED -RADIUS EDGE

TYPICAL 1/4" TOOLED -

MIN. 2"

CLEARANCE

FACE OF BUILDING OR WALL —

1 TEXTURED + INTEGRALLY COLORED CONCRETE, SEE PLANS

TYPICAL 1/4" TOOLED -RADIUS EDGE

RADIUS EDGE

RADIUS EDGE

1분'' DEPTH 🚛

TOOLED CONTROL JOINT

CONSTRUCTION JOINT

DOWELED CONSTRUCTION JOINT

CONSTRUCTION JOINT AT BUILDING OR WALL

TYPICAL CONCRETE PAVING JOINTS

PREMOLDED FILLER

DOWEL AT 24" O.C. WITH

1'' = 1'-0''

(4)

3

1 1/2" = 1'-0"


2 WIRE MESH


(3) CONTROL JOINT

(4) CONSTRUCTION JOINT

(5) FACE OF BUILDING OR WALL

6 COMPACTED FILL PER CIVIL PLANS

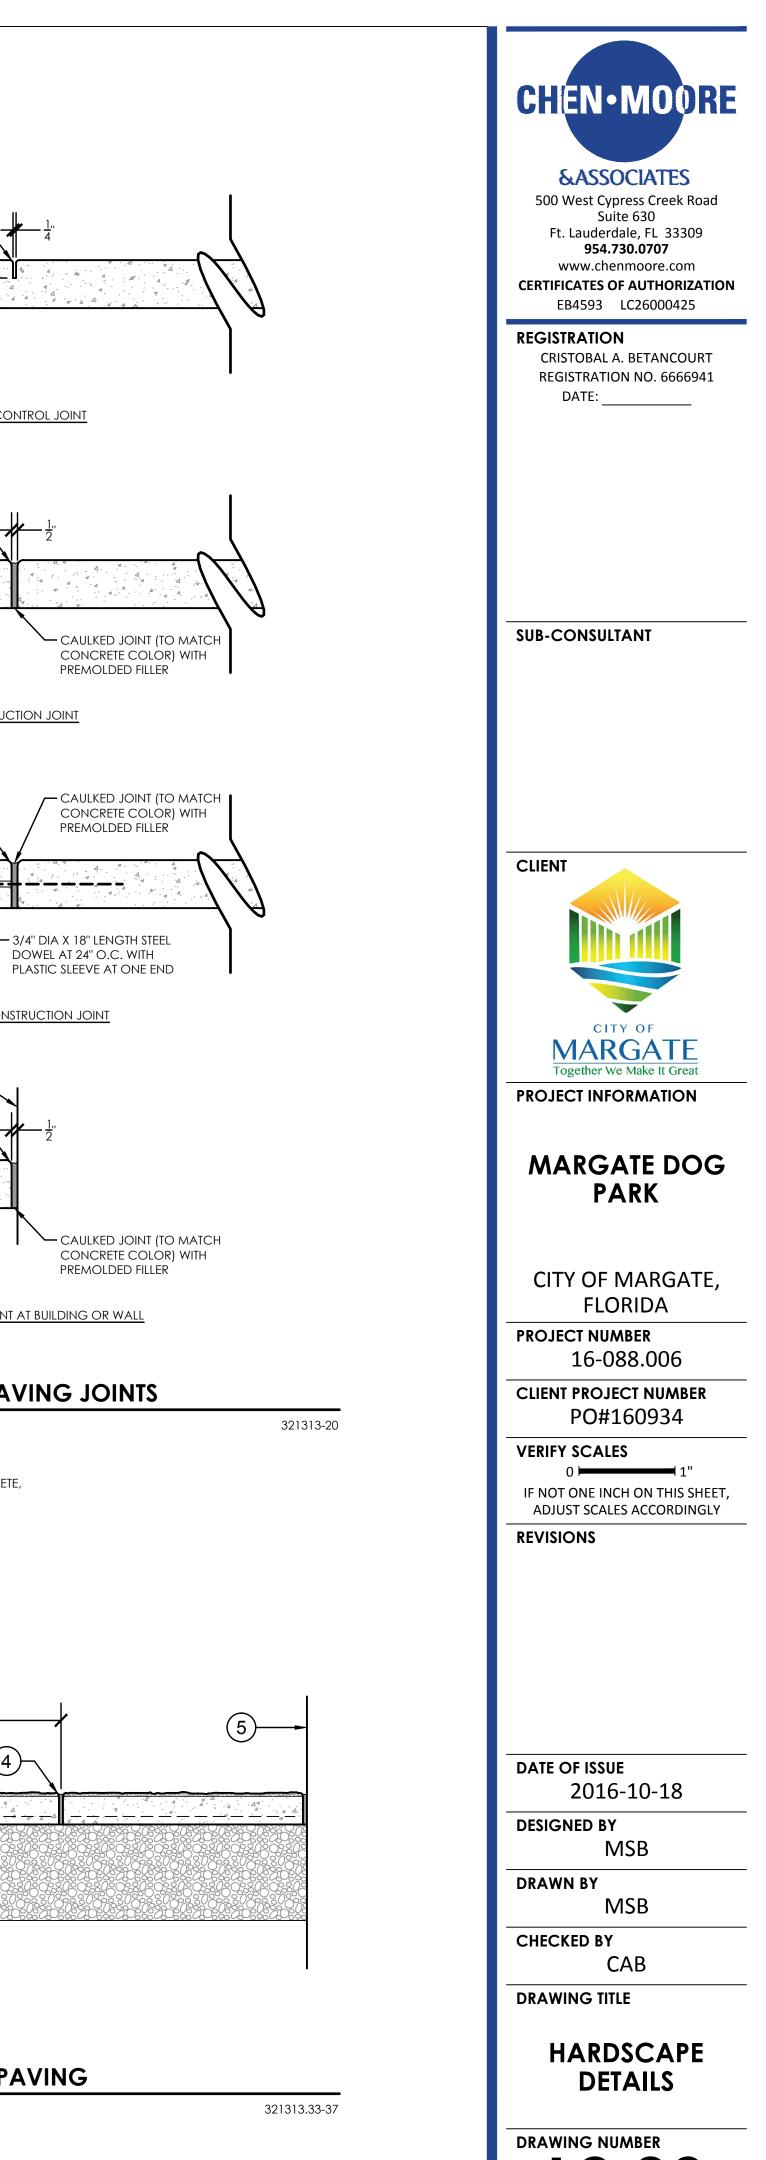

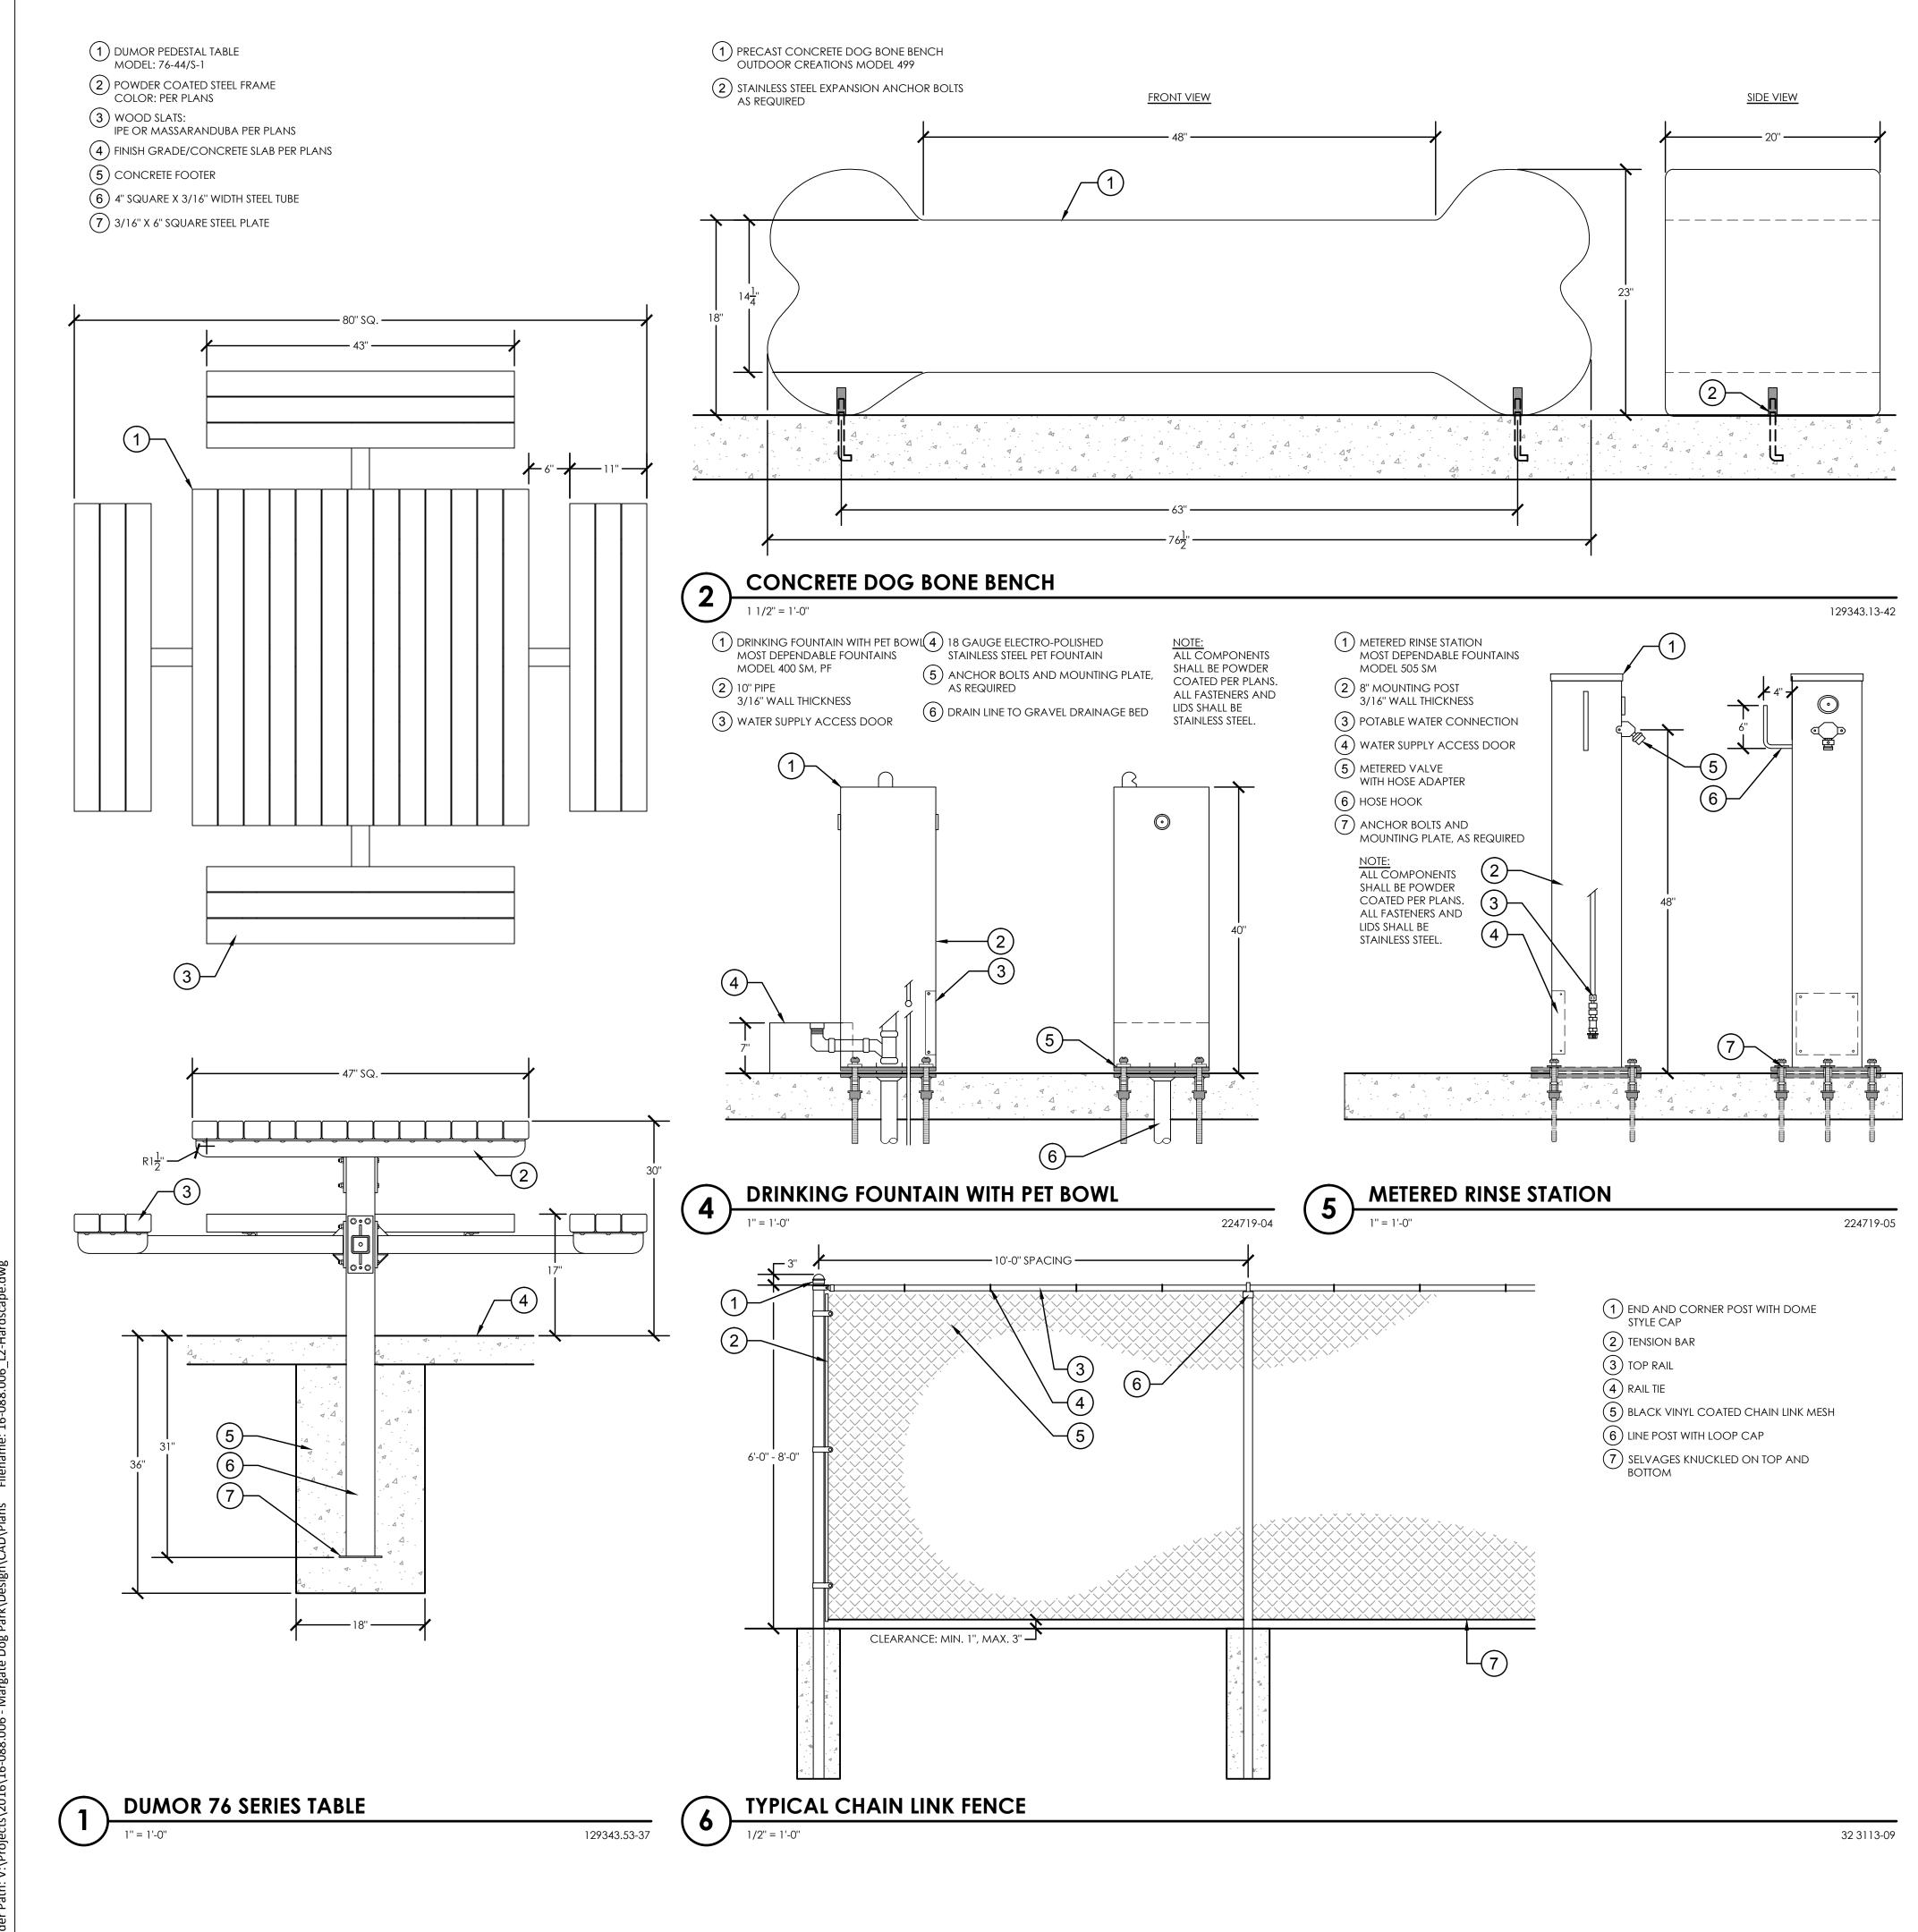

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3

1'' = 1'-0

65% CONSTRUCTION DOCUMENTS



HARDSCAPE DETAILS

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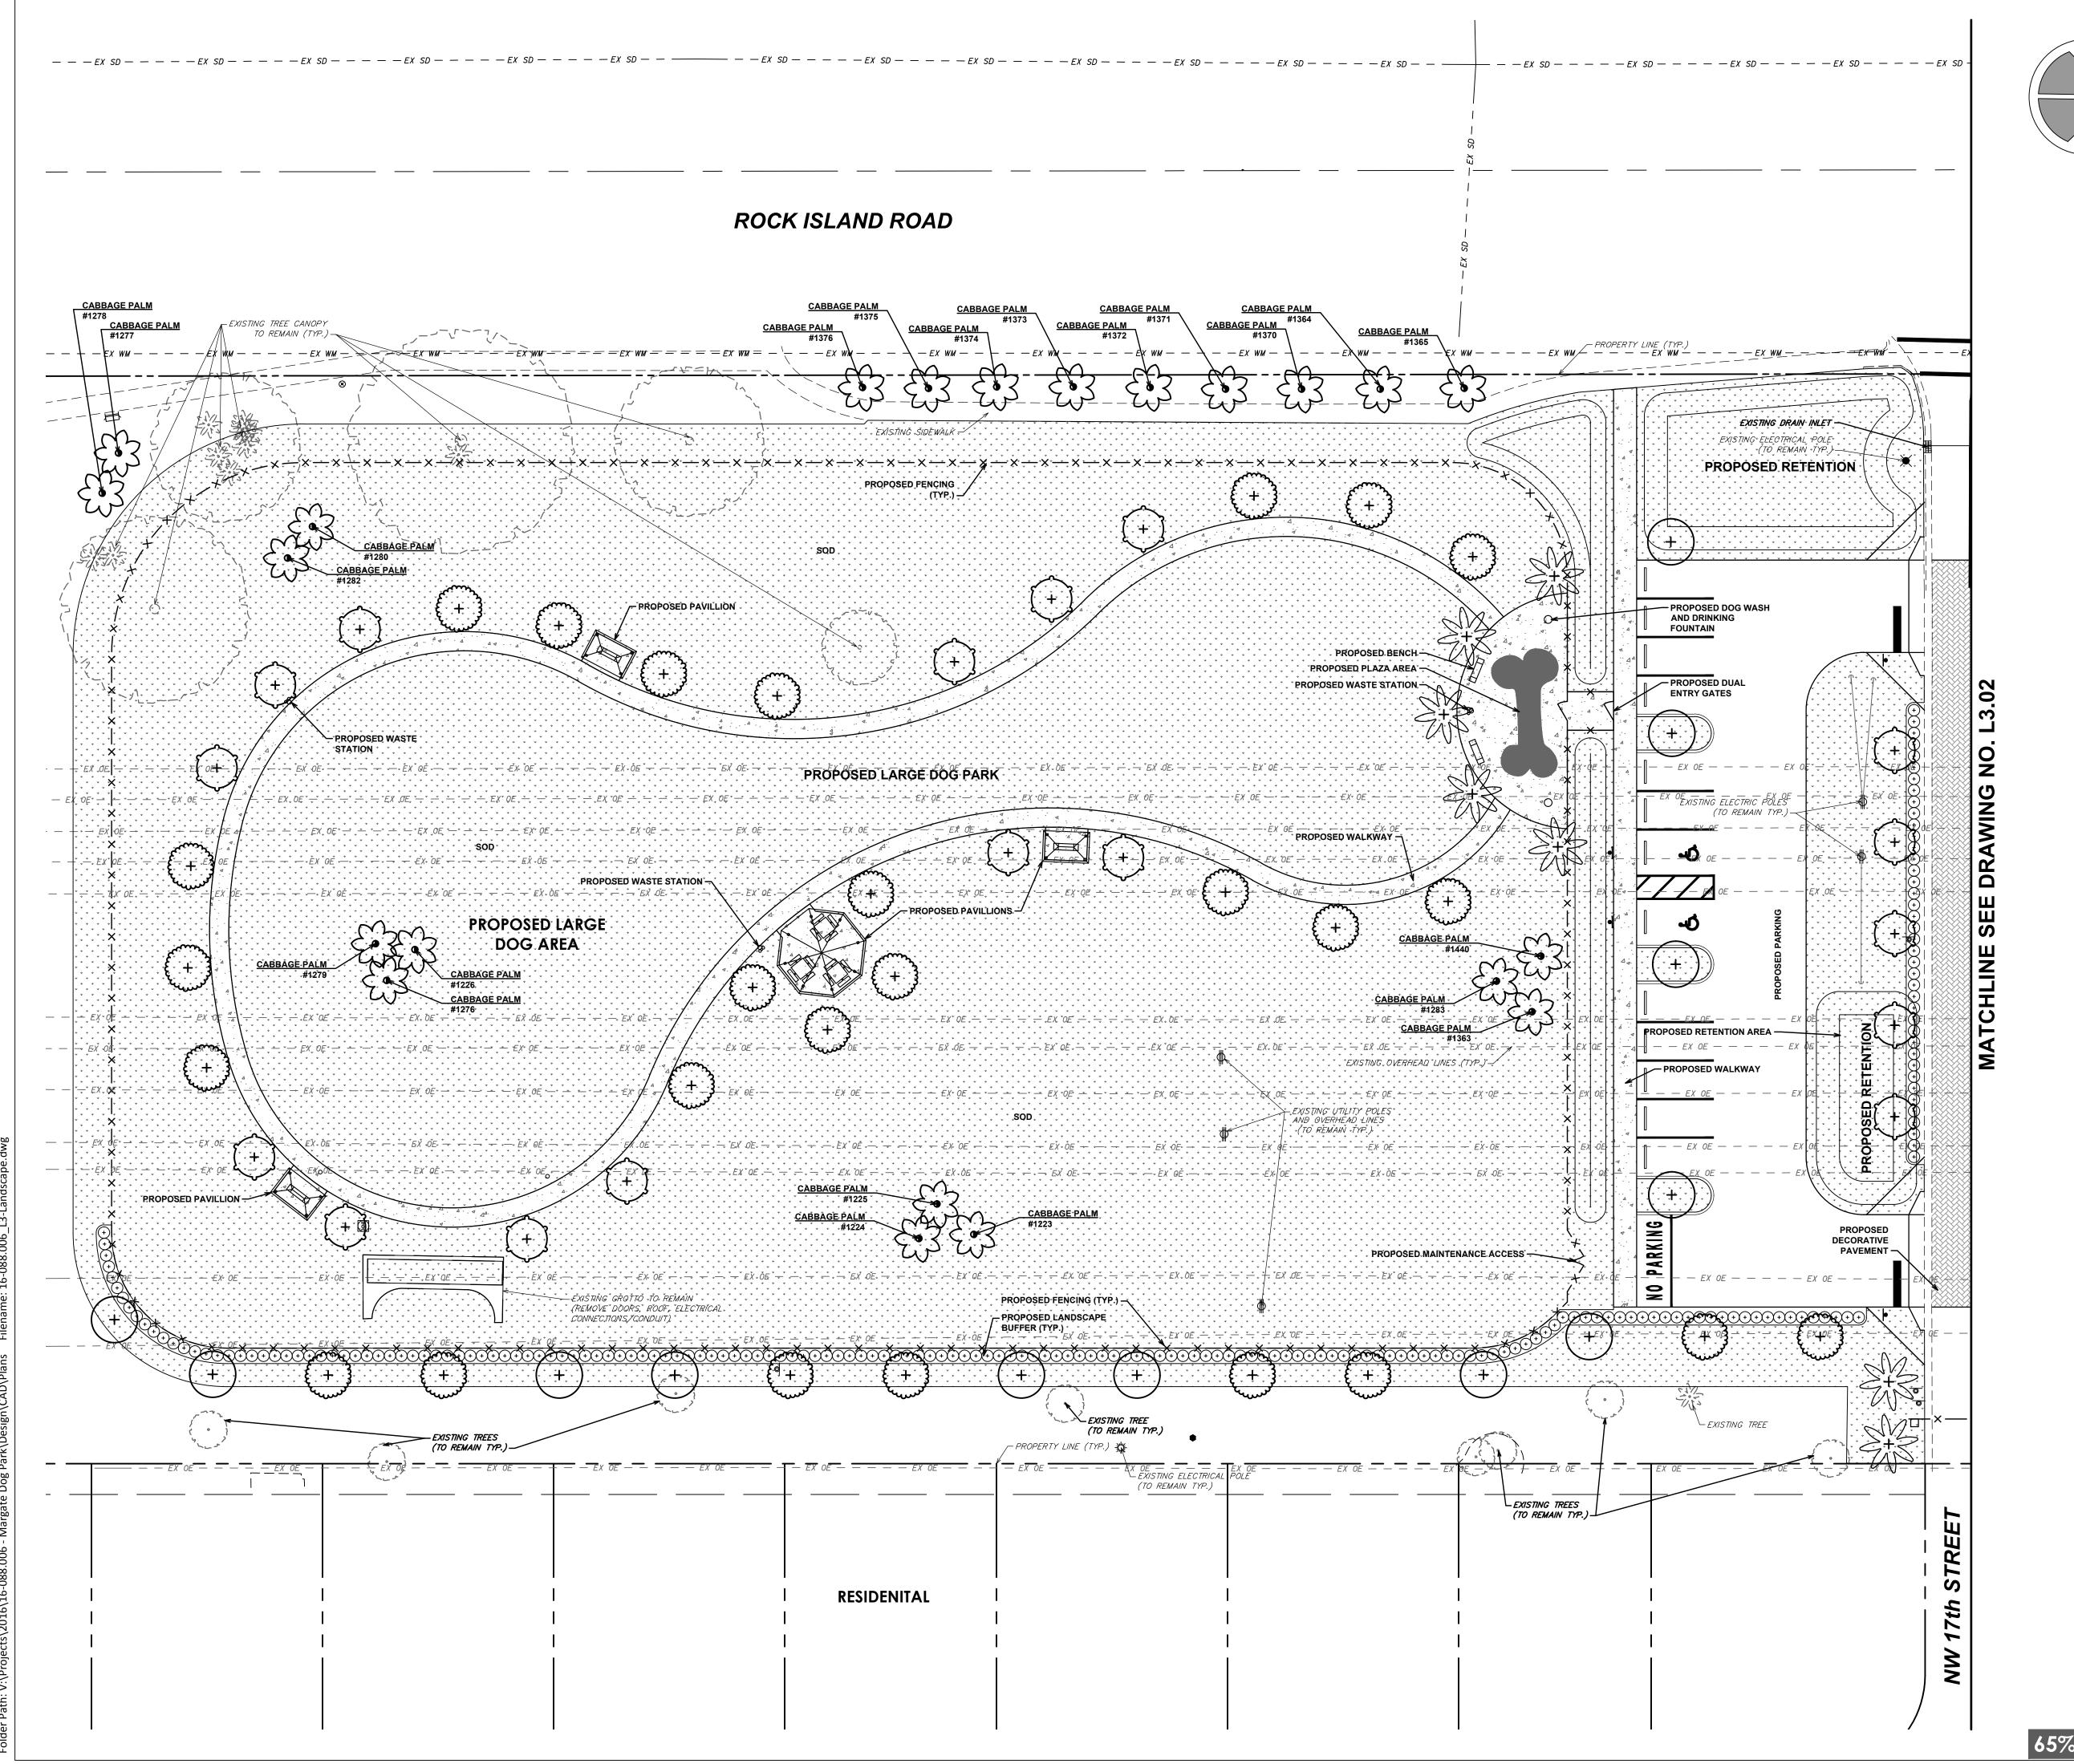
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DATE:

4 10 GALLON TRASH RECEPTACLE WITH STAINLESS STEEL LID 1 PET WASTE STATION MOST DEPENDABLE FOUNTAINS MODEL 395 SM 5 ANCHOR BOLTS AND MOUNTING PLATE, 2 4" MOUNTING POST AS REQUIRED 3/16" WALL THICKNESS LIDS SHALL BE 3 6" BAG DISPENSERS WITH STAINLESS STEEL LID STAINLESS STEEL. (5)-.. 4 . . . · 4. . . . ∢ ⊿. . FRONT VIEW SIDE VIEW PET WASTE STATION


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<u>NOTE:</u> ALL COMPONENTS SHALL BE POWDER COATED PER PLANS. ALL FASTENERS AND



2016-10-18 3:19:33 PM Username: SBortak Layout Name: L3.01 0: V.\Proiects\2016\16-088.006 - Margate Dog Park\Design\CAD\Plans Filename: 16-088.006 13-



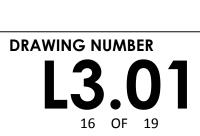

LANDSCAPE PLAN

CAB DRAWING TITLE

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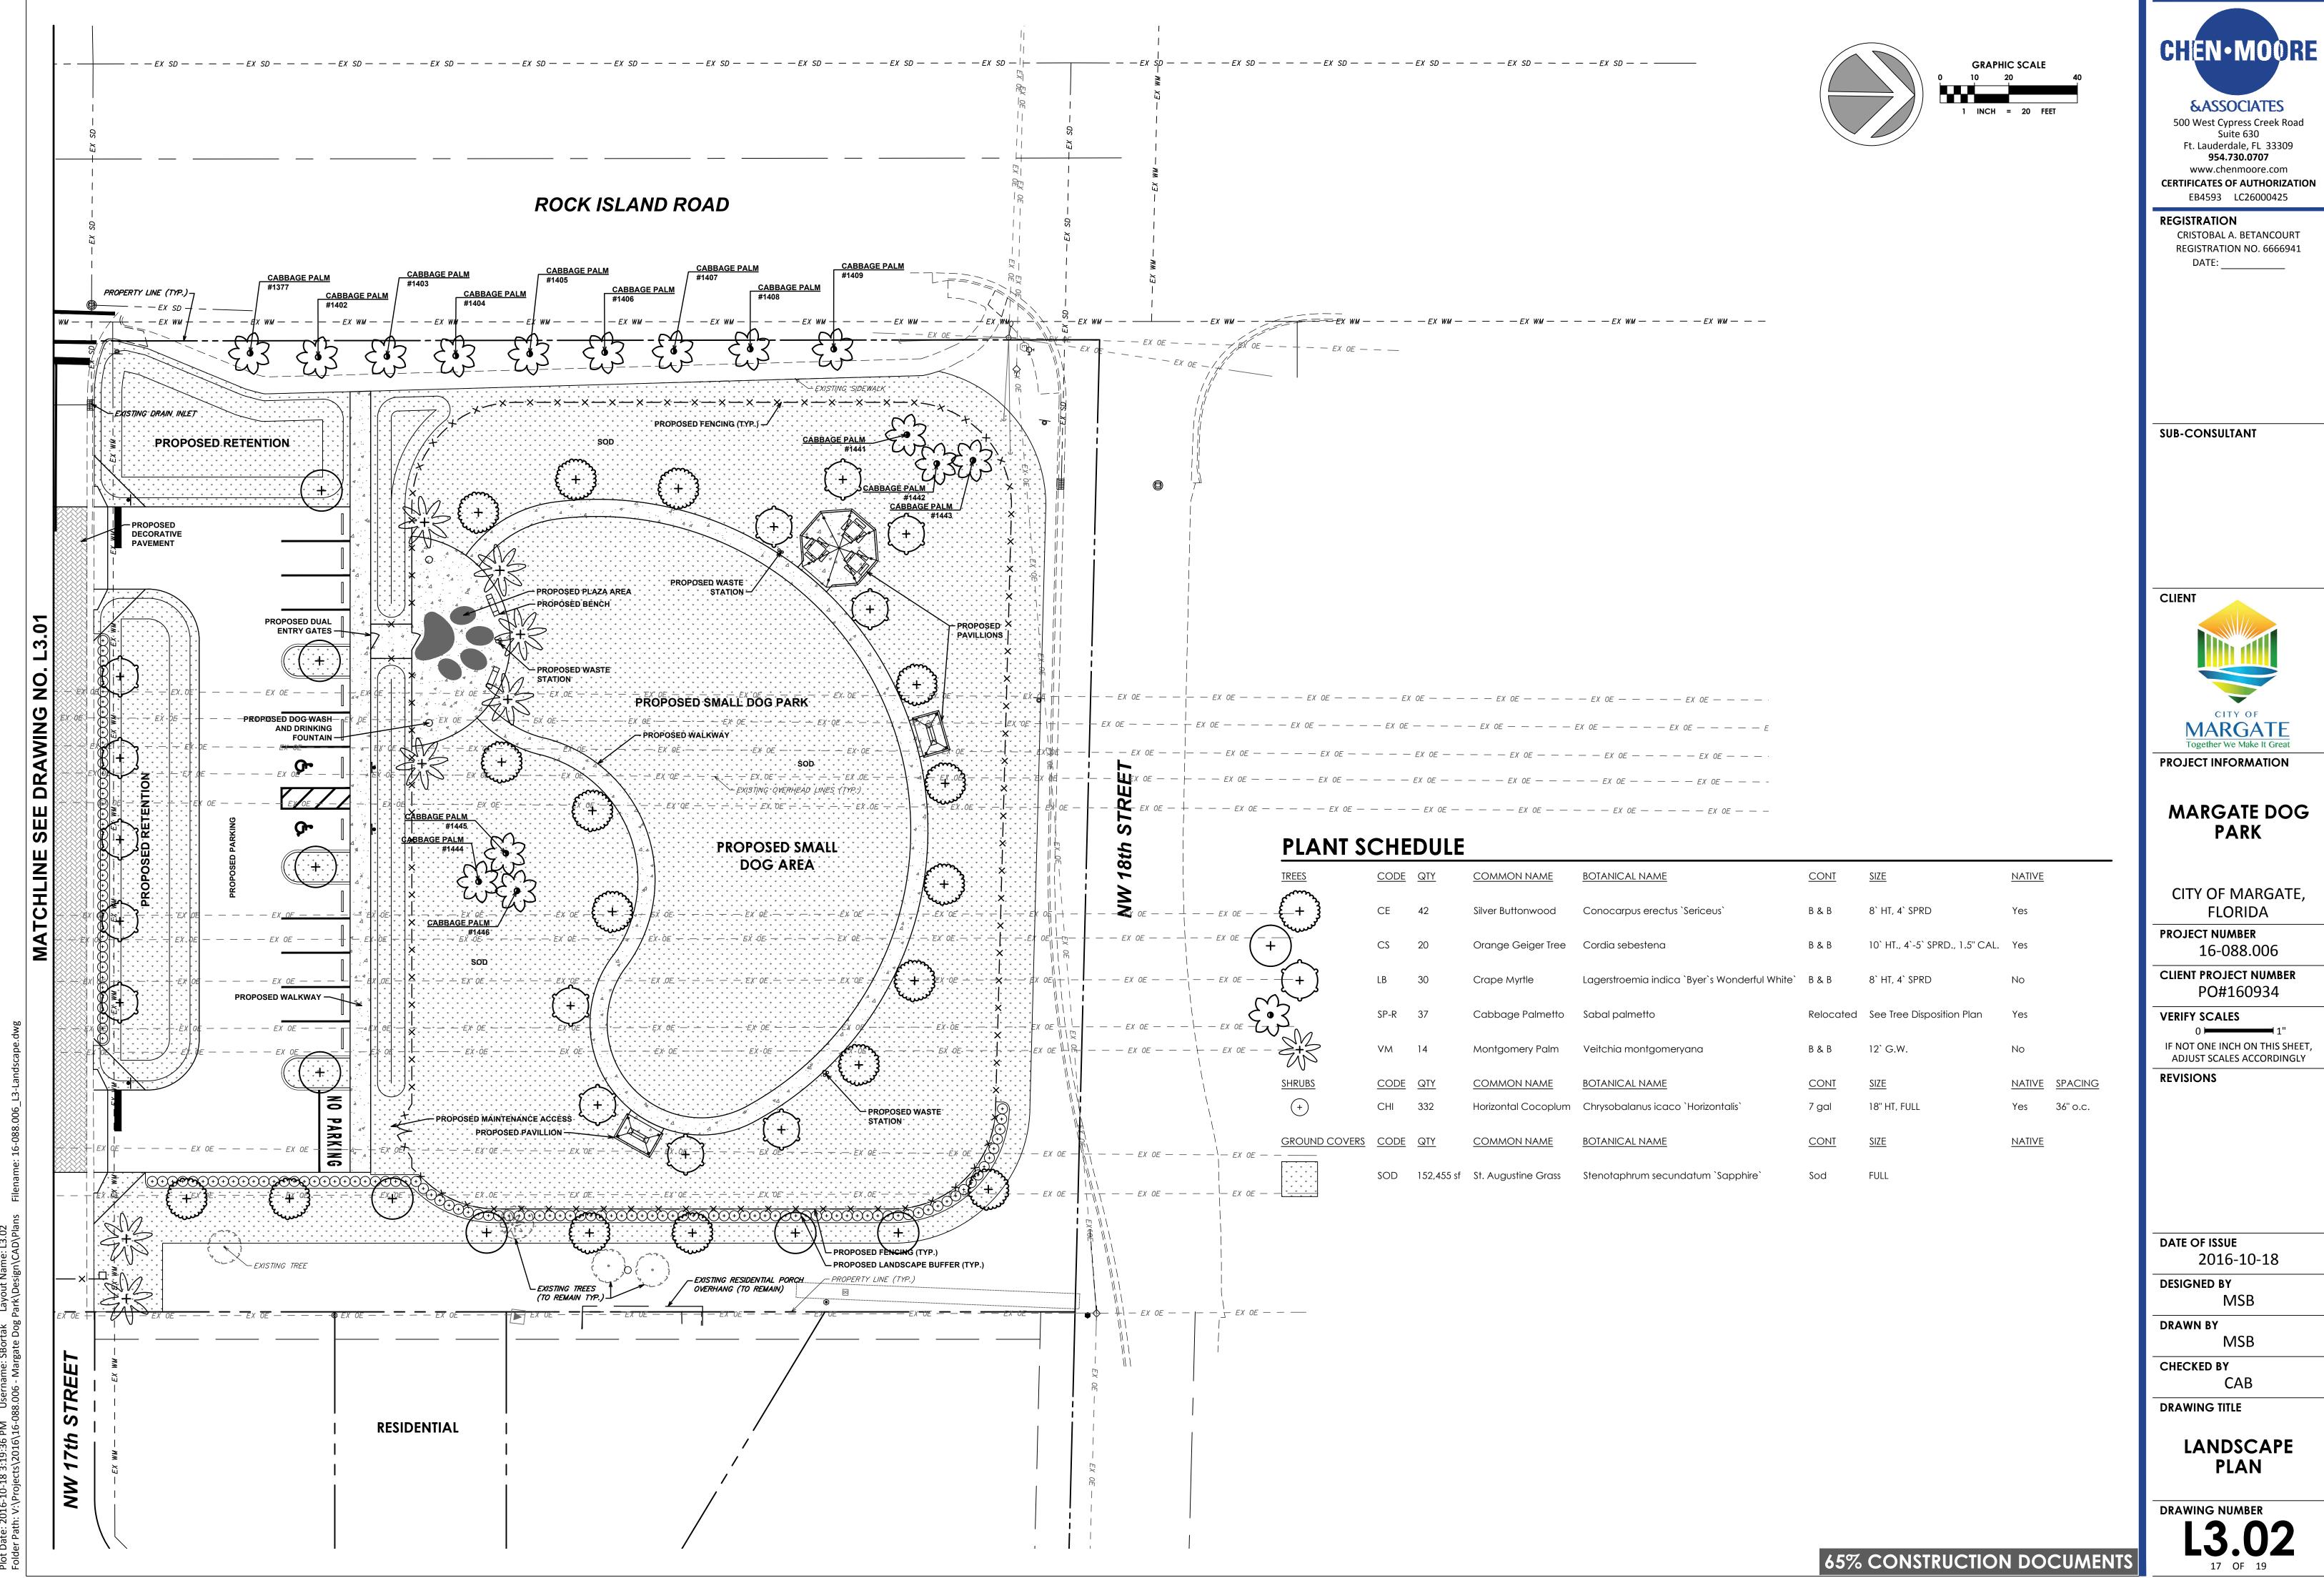
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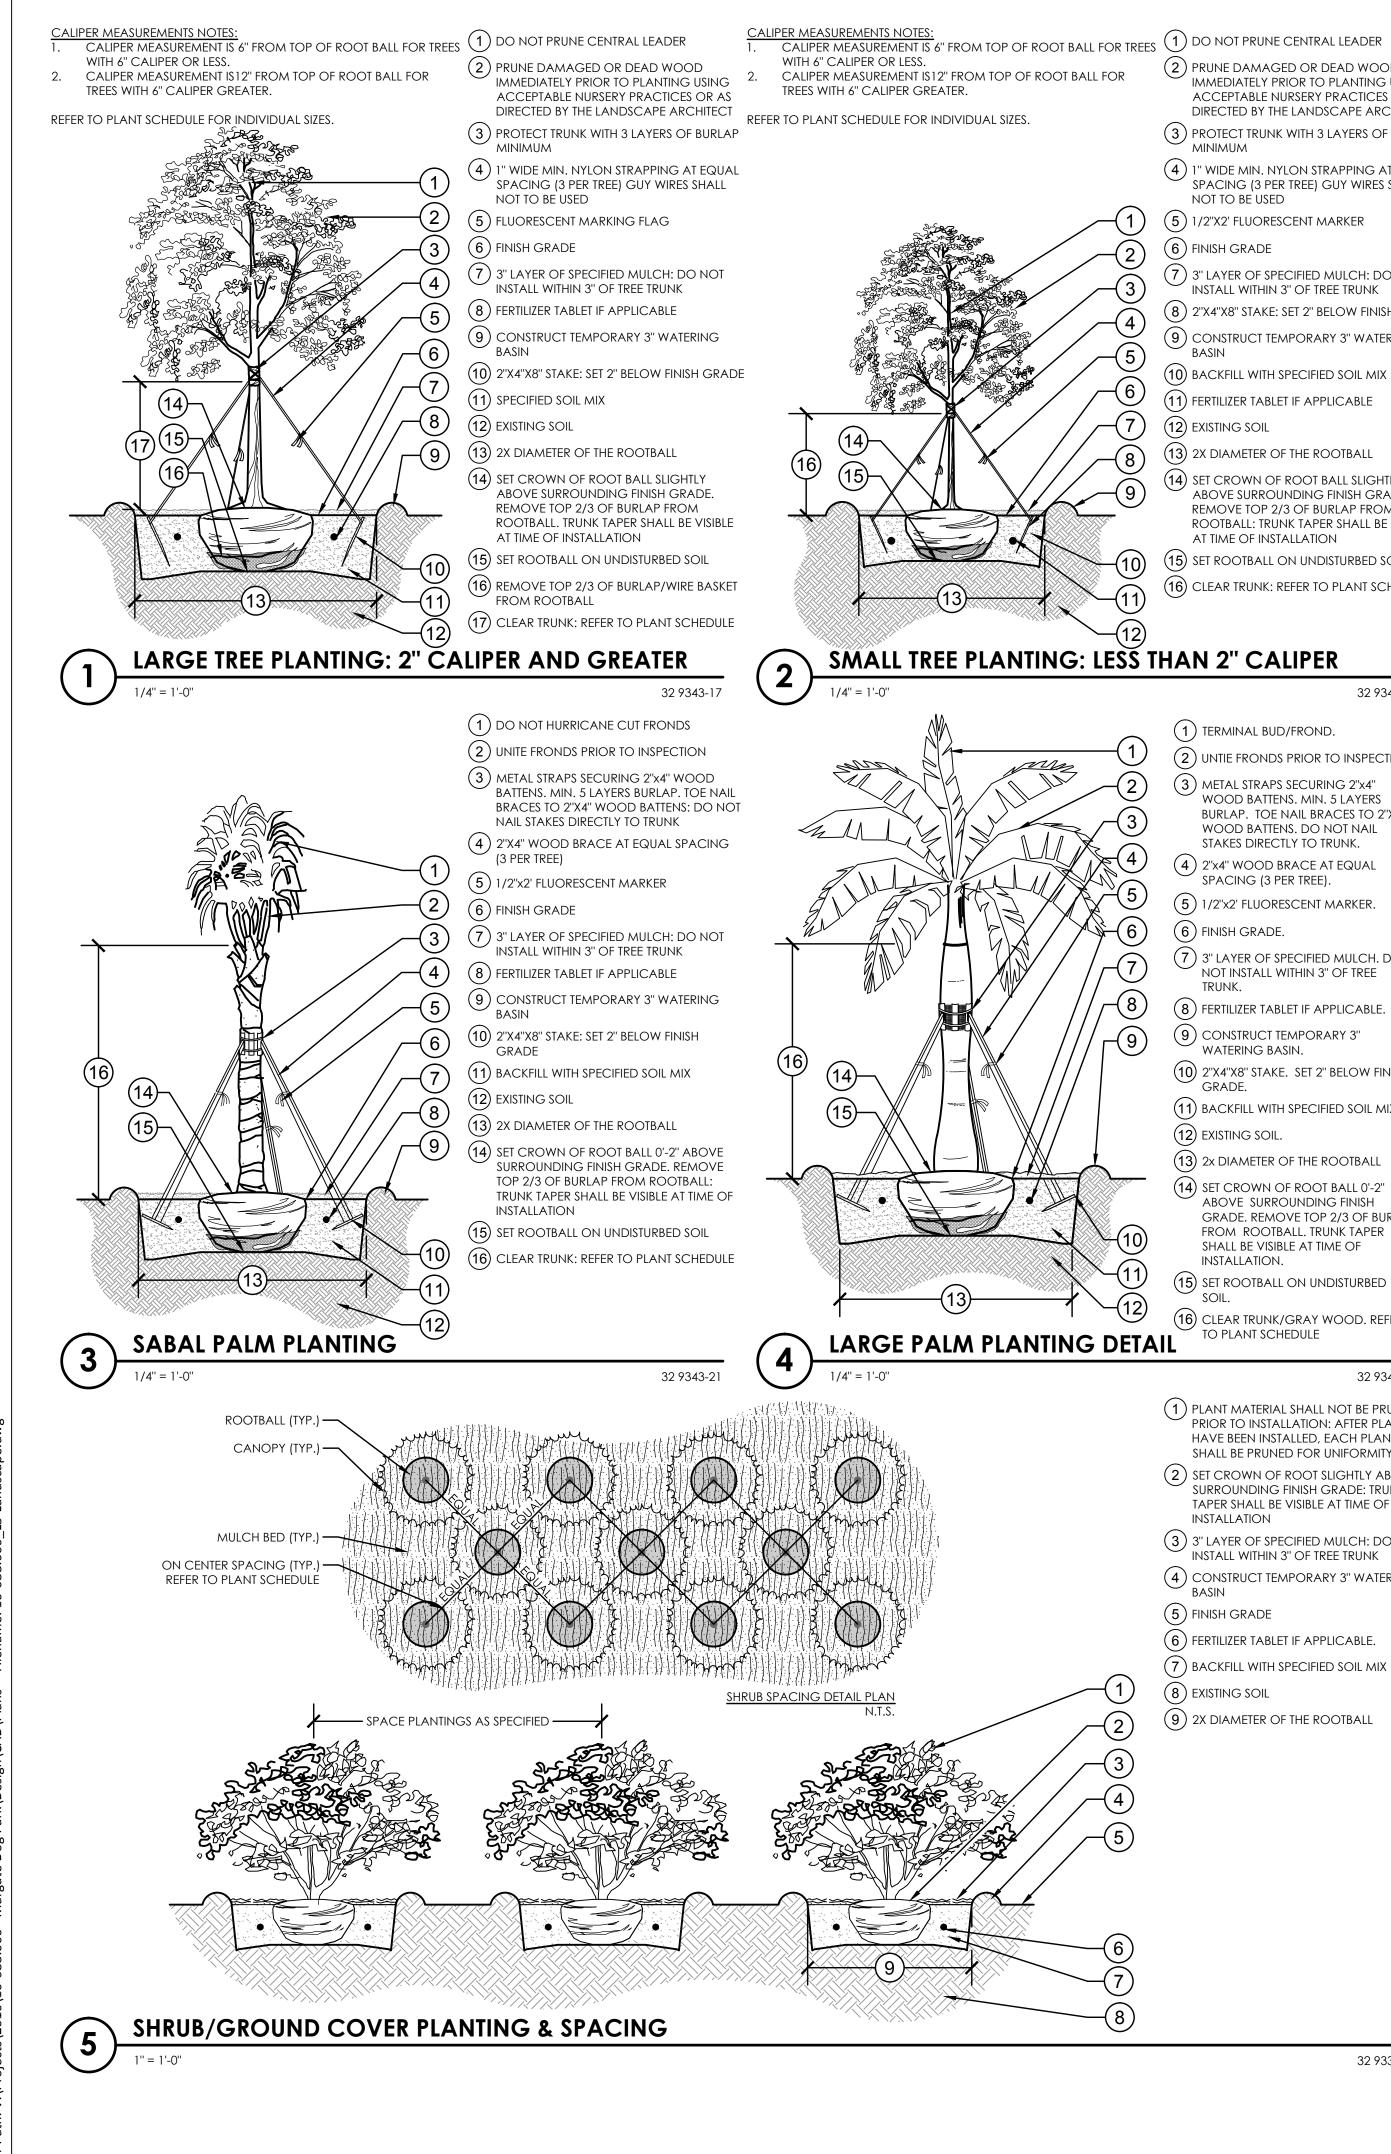
GRAPHIC SCALE

1 INCH = 20 FEET



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TANICAL NAME	CONT	SIZE	NATIVE
nocarpus erectus `Sericeus`	B & B	8` HT, 4` SPRD	Yes
rdia sebestena	B & B	10` HT., 4`-5` SPRD., 1.5" CAL.	Yes
gerstroemia indica `Byer`s Wonderful White`	B & B	8` HT, 4` SPRD	No
palmetto	Relocated	See Tree Disposition Plan	Yes
tchia montgomeryana	B & B	12` G.W.	No
TANICAL NAME		SIZE	NATIVE SPACING
ysobalanus icaco `Horizontalis`	7 gal	18" HT, FULL	Yes 36" o.c.
TANICAL NAME	CONT	SIZE	NATIVE
notaphrum secundatum `Sapphire`	Sod	FULL	



-(2)

-(4)

-(7)

-(11)

-(7)

-(8)

-(9)

- (2) PRUNE DAMAGED OR DEAD WOOD IMMEDIATELY PRIOR TO PLANTING USING
- ACCEPTABLE NURSERY PRACTICES OR AS DIRECTED BY THE LANDSCAPE ARCHITECT
- (3) PROTECT TRUNK WITH 3 LAYERS OF BURLAP MINIMUM
- (4) 1" WIDE MIN. NYLON STRAPPING AT EQUAL SPACING (3 PER TREE) GUY WIRES SHALL NOT TO BE USED
- (5) 1/2"X2' FLUORESCENT MARKER
- (6) FINISH GRADE
- (7) 3" LAYER OF SPECIFIED MULCH: DO NOT INSTALL WITHIN 3" OF TREE TRUNK
- (8) 2"X4"X8" STAKE: SET 2" BELOW FINISH GRADE
- (9) CONSTRUCT TEMPORARY 3" WATERING BASIN
- (10) BACKFILL WITH SPECIFIED SOIL MIX
- -(6) (11) FERTILIZER TABLET IF APPLICABLE
 - (12) EXISTING SOIL
 - (13) 2X DIAMETER OF THE ROOTBALL
 - (14) SET CROWN OF ROOT BALL SLIGHTLY ABOVE SURROUNDING FINISH GRADE. REMOVE TOP 2/3 OF BURLAP FROM ROOTBALL: TRUNK TAPER SHALL BE VISIBLE AT TIME OF INSTALLATION
 - (15) SET ROOTBALL ON UNDISTURBED SOIL
 - (16) CLEAR TRUNK: REFER TO PLANT SCHEDULE

SMALL TREE PLANTING: LESS THAN 2" CALIPER

32 9343-18

- (1) TERMINAL BUD/FROND.
- (2) UNTIE FRONDS PRIOR TO INSPECTION.
- (3) METAL STRAPS SECURING 2''x4'' WOOD BATTENS. MIN. 5 LAYERS BURLAP. TOE NAIL BRACES TO 2"X4" WOOD BATTENS. DO NOT NAIL
- STAKES DIRECTLY TO TRUNK. 4 2"x4" WOOD BRACE AT EQUAL
- SPACING (3 PER TREE).
- (5) 1/2"x2' FLUORESCENT MARKER.
- (6) FINISH GRADE.
- (7) 3" LAYER OF SPECIFIED MULCH. DO NOT INSTALL WITHIN 3" OF TREE TRUNK.
- (8) FERTILIZER TABLET IF APPLICABLE.
- 9 CONSTRUCT TEMPORARY 3" WATERING BASIN.
- (10) 2"X4"X8" STAKE. SET 2" BELOW FINISH GRADE.
- (11) BACKFILL WITH SPECIFIED SOIL MIX. (12) EXISTING SOIL.
- (13) 2x DIAMETER OF THE ROOTBALL
- (14) SET CROWN OF ROOT BALL 0'-2" ABOVE SURROUNDING FINISH GRADE. REMOVE TOP 2/3 OF BURLAP
- FROM ROOTBALL, TRUNK TAPER SHALL BE VISIBLE AT TIME OF INSTALLATION.
- 15 SET ROOTBALL ON UNDISTURBED SOIL.
- (16) CLEAR TRUNK/GRAY WOOD. REFER TO PLANT SCHEDULE

32 9343-25

- (1) PLANT MATERIAL SHALL NOT BE PRUNED PRIOR TO INSTALLATION: AFTER PLANTS HAVE BEEN INSTALLED, EACH PLANT SHALL BE PRUNED FOR UNIFORMITY
- (2) SET CROWN OF ROOT SLIGHTLY ABOVE SURROUNDING FINISH GRADE: TRUNK TAPER SHALL BE VISIBLE AT TIME OF INSTALLATION
- (3) 3" LAYER OF SPECIFIED MULCH: DO NOT INSTALL WITHIN 3" OF TREE TRUNK
- (4) CONSTRUCT TEMPORARY 3" WATERING
- BASIN
- (5) FINISH GRADE
- (6) FERTILIZER TABLET IF APPLICABLE.
- (7) backfill with specified soil mix
- (8) EXISTING SOIL
- (9) 2X DIAMETER OF THE ROOTBALL

32 9333-08

65% CONSTRUCTION DOCUMENTS



LANDSCAPE DETAILS

CAB DRAWING TITLE

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DRAWN BY MSB

MSB

DESIGNED BY

DATE OF ISSUE 2016-10-18

REVISIONS

VERIFY SCALES IF NOT ONE INCH ON THIS SHEET, ADJUST SCALES ACCORDINGLY

CLIENT PROJECT NUMBER PO#160934

FLORIDA PROJECT NUMBER 16-088.006

CITY OF MARGATE.

MARGATE DOG PARK



SUB-CONSULTANT

DATE:

REGISTRATION CRISTOBAL A. BETANCOURT REGISTRATION NO. 6666941

500 West Cypress Creek Road Suite 630 Ft. Lauderdale, FL 33309 954.730.0707 www.chenmoore.com **CERTIFICATES OF AUTHORIZATION** EB4593 LC26000425

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	ERAL	4.2.	TREE PROTECTION BARRICA
1.1.	WORK PERFORMED SHALL COMPLY WITH THE FOLLOWING:		DRIP LINE OF EXISTING TRE
1.1.1.	THESE GENERAL NOTES, CONSTRUCTION DOCUMENTS AND SPECIFICATIONS.		BARRICADES SHALL BE LEFT I
1.1.2. 1.2.	ALL APPLICABLE LOCAL, STATE AND FEDERAL CODES, ORDINANCES AND REGULATIONS. SOURCE OF BASE INFORMATION IS PROVIDED BY [ADD HERE] ON [ADD DATE HERE] AND IS	4.3.	PRIOR TO ANY CONSTRUCTI BY THE LANDSCAPE ARCHIT
۷.	ASSUMED TO BE CORRECT. IF SITE DISCREPANCIES ARE PRESENT, CONTRACTOR SHALL NOTIFY		PRESERVATION BARRICADE
	OWNER'S REPRESENTATIVE IMMEDIATELY. IF CONTRACTOR CONTINUES WORK WITHOUT THE PROPER	4.4.	IF EXCAVATION IN THE VIC
	NOTIFICATION, CONTRACTOR DOES SO AT HIS OWN RISK.		PRUNE TREES, UNDER THE
.3.	THE CONTRACTOR SHALL FURNISH ALL MATERIALS, LABOR, SUPERVISION, AND EQUIPMENT REQUIRED		FOLLOWING CONDITIONS:
	FOR THE WORK AS SHOWN ON THE CONSTRUCTION DOCUMENTS DESCRIBED HEREIN.	4.4.1.	ROOT PRUNE TREES A M
4.	CONTRACTOR SHALL BE RESPONSIBLE FOR ANY COORDINATION WITH SUB-CONTRACTORS AS		PRUNING, THOROUGHL
5	REQUIRED TO COMPLETE THE WORK OF THIS PROJECT. CONTRACTOR SHALL VERIFY LOCATIONS OF PERTINENT SITE IMPROVEMENTS INSTALLED UNDER		
.5.	OTHER CONTRACTS. IF ANY PART OF THIS PLAN CANNOT BE FOLLOWED DUE TO SITE CONDITIONS,		1. PROVIDE TEMPOR CONSTRUCTION.
	CONTACT OWNER'S REPRESENTATIVE FOR INSTRUCTIONS PRIOR TO COMMENCING WORK.		2. ROOT PRUNE TREE
.6.	CONTRACTOR TO NOTIFY "SUNSHINE STATE ONE CALL OF FLORIDA, INC." AT 1-800-432-4770 TWO		CONSTRUCTION ACTIV
	FULL BUSINESS DAYS PRIOR TO DIGGING FOR UNDERGROUND UTILITY LOCATIONS.		THE GREATEST AMOUNT
7.	CONTRACTOR IS RESPONSIBLE FOR DETERMINING ALL UTILITY LOCATIONS AND INSTALLING FACILITIES		3. BACKFILL TRENCH
	SO AS TO NOT CONFLICT. THE LOCATION OF EXISTING UTILITIES OR SITE FEATURES AS SHOWN ON THE		4. FERTILIZE WITHIN TH
	PLANS MAY VARY IN RELATION TO ACTUAL EXISTING CONDITIONS. ANY DIFFERING SITE CONDITIONS	4.4.2.	
	FROM THAT WHICH IS REPRESENTED HEREON, WHETHER ABOVE, ON OR BELOW THE SURFACE OF THE GROUND, SHOULD BE BROUGHT TO THE IMMEDIATE ATTENTION OF THE LANDSCAPE ARCHITECT AND		WHERE PROPOSED SITE DEEP. ROOT PRUNE ON
	THE OWNER IN WRITING. NO CLAIM FOR EXPENSES INCURRED BY THE CONTRACTOR DUE TO		MAXIMUM TRENCH WID
	DIFFERING SITE CONDITIONS WILL BE ALLOWED IF THE CONTRACTOR FAILS TO PROVIDE THE	4.4.3.	
	REQUIRED WRITTEN NOTIFICATION OF SUCH CONDITIONS FOR REVIEW BY THE LANDSCAPE		TRENCHES WITH SOIL C
	ARCHITECT AND THE OWNER.		AFTER ROOT PRUNING,
.8.	CONTRACTOR SHALL NOTIFY ALL APPROPRIATE UTILITY COMPANIES OF PROPOSED START OF WORK		SOLUBLE FERTILIZER THAT
	IN ACCORDANCE WITH THEIR STANDARD REQUIREMENTS, INCLUDING BUT NOT LIMITED TO, WATER,	4.5.	THE CONTRACTOR SHALL FIE
9.	SANITARY SEWER, POWER, NATURAL GAS, TELEPHONE AND CABLE TV COMPANIES. IT SHALL BE THE CONTRACTOR'S SOLE RESPONSIBILITY TO TAKE THE NECESSARY PRECAUTIONS TO		BE APPROVED BY THE LAND FOR IRRIGATION OR ELECT
<i>.</i> .	ENSURE PROPER SAFETY AND WORKMANSHIP WHEN WORKING IN THE VICINITY OF EXISTING UTILITY		TRENCHING REQUIRED FOR
		4.6.	ROOT PRUNING SHALL OC
10.	PERFORM EXCAVATION IN THE VICINITY OF UNDERGROUND UTILITIES WITH CARE AND BY HAND, IF		PLANS.
	NECESSARY. THE CONTRACTOR BEARS FULL RESPONSIBILITY FOR THIS WORK AND DISRUPTION OF	5. <u>PLA</u>	NTING SOIL
	DAMAGE TO UTILITIES SHALL BE REPAIRED IMMEDIATELY AND AT NO EXPENSE TO THE OWNER.	5.1.	ALL TREES SHALL BE PLAN
11.	THE SUCCESSFUL BIDDER SHALL FURNISH TO THE OWNER A UNIT PRICE BREAKDOWN FOR ALL		ROOTBALL.
	MATERIALS. THE OWNER MAY, AT ITS DISCRETION, ADD OR DELETE FROM THE MATERIALS UTILIZING THE UNIT PRICE BREAKDOWN SUBMITTED.	5.2.	ALL TREES SHALL BE PLAN
2.	IT IS THE RESPONSIBILITY OF THE CONTRACTOR TO ENSURE THAT ALL REQUIRED PERMITS ARE	5.3.	ROOTBALL. MINIMUM TOPSOIL SHALL BE
	OBTAINED AND ARE IN HAND AT THE JOB SITE PRIOR TO THE COMMENCEMENT OF CONSTRUCTION.	5.4.	PLANTING SOIL MIX SHALL BE
	CONTRACTOR SHALL ABIDE BY ALL PERMIT CONDITIONS.	5.4.1.	DICOT TREES & SHRUBS:
PRE	CONSTRUCTION RESPONSIBILITY	5.4.2.	MONOCOT PALMS: 709
.1.	UPON RECEIPT OF NOTICE OF AWARD, THE CONTRACTOR SHALL ARRANGE A PRE-CONSTRUCTION	5.4.3.	turf: 80% Sand, 10% Pi
	CONFERENCE TO INCLUDE ALL INVOLVED GOVERNMENTAL AGENCIES, ALL AFFECTED UTILITY	6. <u>Lan</u>	IDSCAPE PLANTING
0	OWNERS, THE OWNER, THE LANDSCAPE ARCHITECT, ANY OTHER PERTINENT PARTIES AND HIMSELF.	6.1.	THIS PLAN HAS BEEN DESIGN
	CONTRACTOR SHALL PROVIDE TEMPORARY SANITARY FACILITIES ONSITE. LOCATION TO BE	6.2.	THE PLANTING PLAN SHAL
	DETERMINED BY THE OWNER. JANITORIAL SERVICES SHALL BE PROVIDED BY CONTRACTOR THROUGHOUT THE DURATION OF PROJECT.	6.3.	APPLICABLE DEED RESTRICTION PLANT MATERIAL: ALL PLANT
3.	PRIOR TO BEGINNING CONSTRUCTION, THE CONTRACTOR SHALL VERIFY THE SIZE, LOCATION,	0.0.	AND STANDARDS FOR NURS
	ELEVATION, AND MATERIAL OF ALL EXISTING UTILITIES WITHIN THE AREA OF CONSTRUCTION.	6.4.	ALL PLANT MATERIAL SHALL
4.	IF UPON EXCAVATION, AN EXISTING UTILITY IS FOUND TO BE IN CONFLICT WITH THE PROPOSED		DESIGNATION.
	CONSTRUCTION OR TO BE OF A SIZE OR MATERIAL DIFFERENT FROM THAT SHOWN ON THE PLANS;	6.5.	ALL TREES, SHRUBS AND GRO
	THE CONTRACTOR SHALL IMMEDIATELY NOTIFY THE LANDSCAPE ARCHITECT.		THE PLANT LIST. CONTAINER
5.	IT SHALL BE THE CONTRACTOR'S RESPONSIBILITY TO MAKE ARRANGEMENTS FOR THE FIELD		MEET OR EXCEED THE MINIM
	LOCATIONS AND FOR ANY TREES PROPOSED FOR RELOCATION. THIS SHALL BE DONE IN A TIMELY	6.6.	QUANTITIES LISTED ON THE F
	MANNER TO MINIMIZE IMPACT ON CONSTRUCTION SCHEDULE. ANY DELAY CAUSED BY THE CONTRACTOR BY THE RELOCATION OF TREES SHALL BE INCIDENTAL TO THE CONTRACT AND NO		ALL QUANTITIES. MULCH, TO
	EXTRA COMPENSATION WILL BE ALLOWED.	6.7.	PLANTS.
6.	CONTRACTOR SHALL VERIFY LIMITS OF CONSTRUCTION AS NOTED ON THE PLANS. ANY WORK	0./.	WHERE THERE IS A DISCREF BETWEEN THE PLAN OR PLAN
	PERFORMED OUTSIDE OF THE AGREED UPON LIMITS OF CONSTRUCTION SHALL BE DONE AT THE	6.8.	ALL SUBSTITUTIONS AND CH
	EXPENSE OF THE CONTRACTOR.		DISCREPANCIES BETWEEN P
<u>SITE</u>	DEMOLITION		ATTENTION OF THE LANDSC
.1.	ITEMS SHALL REMAIN UNLESS OTHERWISE NOTED ON THE PLAN(S). REMOVE DESIGNATED ITEMS	6.9.	CONTRACTOR SHALL BE
	SHOWN ON THE PLAN TO THE FULL DEPTH OF THEIR CONSTRUCTION UNLESS OTHERWISE NOTED.		PLANTING AREAS.
.2.	ALL HARDSCAPE DESIGNATED FOR REMOVAL SHALL BE SAW CUT, LEAVING UNIFORM EDGES TO THE	6.10.	AFTER FINAL GRADE, LAND
	GREATEST EXTENT POSSIBLE. MATERIAL EDGES TO REMAIN SHALL BE SHORED UP AND PROTECTED		FOREIGN INORGANIC MATE
	DURING CONSTRUCTION TO PRESERVE EDGE INTACT. REPAIRS TO DAMAGED EDGES SHALL BE REPAIRED BY CONTRACTOR AT NO ADDITIONAL COST TO THE OWNER.	6.11.	ALL PLANTING HOLES TO BE
.3.	NO EXISTING MATERIAL SHALL BE USED IN NEW CONSTRUCTION UNLESS NOTED ON THE PLANS OR	6.12.	AFFECT EXISTING TREES, DAN ALL PLANTING BEDS IN OPE
	APPROVED DURING THE SHOP DRAWING APPROVAL PROCESS.	U.TZ.	TO A DEPTH OF TWENTY-F
.4.	SALVAGE EXISTING MATERIALS AS INDICATED ON THE PLANS. SALVAGED MATERIALS SHALL BE		SECTION 5.00. PLANTING E
	HANDLED WITH CARE AND STORED ON-SITE OR AS DIRECTED BY OWNER. CLEAN ALL DEBRIS AND		EXTRANEOUS MATERIAL.
	Construction material from salvaged items; reuse as directed by owner's	6.13.	ALL PLANTING BEDS IN ME
	REPRESENTATIVE.		MATERIAL SHALL BE EXCAV
.5.	REMOVE DEMOLISHED MATERIALS FROM SITE AND DISPOSE OF AS REQUIRED BY LOCAL, STATE OR		ENCOUNTERED TO ENSURE
	FEDERAL LAWS.		PLANTING BED SHALL BE
.6.	CONTRACTOR SHALL PROTECT ADJACENT WATER BODIES, COASTAL DUNE SYSTEMS AND		MATERIAL.
	PROPERTIES FROM DAMAGE BY SEDIMENTATION OR OTHER POTENTIAL CONSTRUCTION RELATED	6.14.	EXCAVATE PLANTING PITS TO
7	CAUSES.		WILL BE PLANTED AT FINI
7.	ALL IRRIGATION IN DEMOLITION AREA TO BE CAPPED AND ADJUSTED AS NECESSARY TO ENSURE	,	CONSIDERED FIRST ORDER R
TDE	OVERALL SYSTEM IS NOT AFFECTED. PRESERVATION	6.15.	BURLAP, SYNTHETIC STRING
<u>IRE</u> 1.1.	<u>PRESERVATION</u> ALL TREES TO BE PRESERVED AS INDICATED ON THE TREE DISPOSITION PLAN SHALL BE PROTECTED BY		ROOTBALLS BEFORE ANY TR HE TOP OF THE ROOTBALLS.
	A TREE PROTECTION BARRICADE, UNLESS OTHERWISE NOTED ON PLAN.		THE BOTTOM 2/3RDS SHALL I
			THE DOTTOM Z/DRUS STALL

- EES TO BE PRESERVED IN PLACE, AS SHOWN ON PLAN. PRESERVATION T IN PLACE THROUGHOUT DURING ALL PHASES OF CONSTRUCTION.
- TION A TREE PROTECTION BARRICADE INSPECTION SHALL BE CONDUCTED
- E FENCING DETAIL. CINITY OF A PROTECTED TREE IS REQUIRED, CONTRACTOR SHALL ROOT E SUPERVISION OF A CERTIFIED ARBORIST IN ACCORDANCE TO THE

- ILY WATER THE ROOT ZONE WITH AT LEAST 2 TO 3 INCHES OF WATER FOR 2 ROOT PRUNING. SEE BELOW FOR RELOCATION TIMELINE.
- RARY IRRIGATION FOR EACH TREE THROUGHOUT THE DURATION OF
- EES, SHOWN ON PLAN IN AREAS WHERE ROOTS WILL CONFLICT WITH VITY. PRUNING OF ROOTS SHOULD BE DONE IN A MANNER TO PRESERVE NT OF THE ROOT BASE AS POSSIBLE.
- I WITH PLANTING SOIL.
- HE ROOT ZONE (SEE BELOW).
- L BE ACCOMPLISHED BY DIGGING A TRENCH AROUND THE TREE IN AREAS "E WORK WILL BE PERFORMED. TRENCHING SHALL BE AT A MINIMUM OF 24" /IDTH OF 8".
- INLY WITH A MECHANICAL ROOT-PRUNING SAW OR A TRENCHER WITH A SHALL BE CUT OFF SMOOTHLY, WITH SHARP INSTRUMENTS. BACKFILL 7. TURF GRASSES
- , AND ONCE WEEKLY DURING THE ROOT REGENERATION PERIOD, WITH A IAT HAS A 20.20.20 ANALYSIS AT MANUFACTURER'S RECOMMENDED RATE. FIELD STAKE THE LIMIT OF ROOT PRUNING. LIMITS OF ROOT PRUNING SHALL NDSCAPE ARCHITECT PRIOR TO ANY EXCAVATION. DO NOT ROOT PRUNE 8. R UTILITY WORK WITH THE LANDSCAPE PLANS.
- CCUR IN ACCORDANCE WITH TREE RELOCATION NOTES AS NOTED ON
- NTED WITH A MINIMUM OF 12" TOPSOIL AROUND AND BENEATH THE 8.3.

- NTED WITH A MINIMUM OF 6" TOPSOIL AROUND AND BENEATH THE
- BE 2" FOR SODDED GRASS AREAS.
- BE A WEED FREE MIX AS FOLLOWS:
- S: 50% SAND, 40% MUCK & 10% PEAT
- 0% SAND & 30% MUCK PEAT & 10% MUCK
- NED TO MEET OR EXCEED ALL APPLICABLE CODES.
- TIONS.
- NT MATERIAL SHALL BE FLORIDA #1 OR BETTER AS ESTABLISHED BY "GRADES RSERY PLANTS" OF THE STATE OF FLORIDA, DEPARTMENT OF AGRICULTURE. ALL BE TRUE TO THE BOTANICAL NAME, GENUS, SPECIES AND/OR HYBRID 10. PROJECT CLOSEOUT
- ROUNDCOVERS SHALL BE OF THE SIZES (HEIGHT & SPREAD) AS SPECIFIED IN IER SIZE IS FOR REFERENCE PURPOSES ONLY. ALL PLANT MATERIAL SHALL MUM SIZES AT INSTALLATION, AS SPECIFIED IN THE PLANT LIST.
- PLANT LIST ARE FOR ESTIMATING PURPOSES. CONTRACTOR SHALL VERIFY TOPSOIL, FERTILIZER, ETC. SHALL BE INCLUDED IN THE UNIT COST OF THE
- EPANCY EITHER IN QUANTITIES, PLANT NAMES, SIZES OR SPECIFICATIONS ANT LIST, THE PLAN TAKES PRECEDENCE.
- CHANGES SHALL BE APPROVED IN WRITING PRIOR TO INSTALLATION. ANY PLANS, SITE AND SPECIFICATIONS SHALL BE BROUGHT TO THE IMMEDIATE CAPE ARCHITECT, THE OWNER AND/OR GOVERNING MUNICIPALITY.
- RESPONSIBLE FOR PROVIDING FINAL GRADING OF ALL ASSOCIATED
- NDSCAPE AREAS ARE TO BE RAKED TO A DEPTH OF 6". ALL ROCK AND TERIALS SHALL BE REMOVED AND DISPOSED OF PROPERLY OFF-SITE.
- BE HAND DUG EXCEPT WHERE MACHINE DUG HOLES WILL NOT ADVERSELY AMAGE UTILITIES OR OTHER IMPROVEMENTS.
- PEN AREAS AND AROUND BUILDING FOUNDATIONS SHALL BE EXCAVATED FOUR INCHES (24") AND BACK FILLED WITH SOIL MIX AS SPECIFIED IN BED SHALL BE FREE FROM ROCK, CONSTRUCTION DEBRIS OR OTHER
- vated to a depth of thirty-six inches (36") or until native soils E DRAINAGE. BACK FILL WITH SOIL MIX AS SPECIFIED IN SECTION 5.00. FREE FROM ROCK, CONSTRUCTION DEBRIS OR OTHER EXTRANEOUS
- TO A DEPTH SO THAT THE TRUNK FLARE AND FIRST ORDER LATERAL ROOT(S) NISH GRADE OR SLIGHTLY HIGHER. ADVENTITIOUS ROOTS ARE NOT ROOTS.
- NG, CORDS AND/OR LIFTING ROPES SHALL BE REMOVED FROM THE REES ARE PLANTED. THE TOP 1/3RD OF BURLAP MUST BE REMOVED FROM 5. THE TOP 1/3RD OF WIRE BASKETS SHALL BE COMPLETELY REMOVED AND L BE CUT BEFORE THE TREES ARE INSTALLED. EE OR PALM WILL BE ACCEPTED.

- CADES SHALL BE PROVIDED BY LANDSCAPE CONTRACTOR AROUND THE 6.17. NO PLANT MATERIAL WILL BE ACCEPTED SHOWING EVIDENCE OF CABLE, CHAIN MARKS, EQUIPMENT SCARS, OR OTHERWISE DAMAGED.
 - 6.18. PLANT MATERIAL WILL NOT BE ACCEPTED WHEN THE BALL OF EARTH SURROUNDING ITS ROOTS HAS BEEN CRACKED, BROKEN OR OTHERWISE DAMAGED.
- ITECT, OWNER OR GOVERNING MUNICIPALITY. REFER TO PLANS FOR TREE 6.19. ALL TREES SPECIFIED AS FIELD GROWN OR B&B TREES SHALL BE ROOT-PRUNED AT THE NURSERY A MINIMUM OF (8) WEEKS PRIOR TO PLANTING.
 - 6.20. ALL PLANT MATERIAL PLANTED WITHIN THE SIGHT DISTANCE TRIANGLE AREAS SHALL BE MAINTAINED TO PROVIDE UNOBSTRUCTED CROSS-VISIBILITY AT A HORIZONTAL LEVEL BETWEEN 30 INCHES AND 8 FEET ABOVE ADJACENT STREET GRADE.
- MINIMUM OF EIGHT (8) WEEKS PRIOR TO CONSTRUCTION. PRIOR TO ROOT 6.21. NO CANOPY TREES SHALL BE PLANTED WITHIN 12 FEET OF A LIGHT POLE. NO PALM SPECIES SHALL BE PLANTED WITHIN 6 FEET OF A LIGHT POLE.
 - 6.22. GROUND COVER PLANTINGS SHALL PROVIDE NOT LESS THAN 50 PERCENT COVERAGE IMMEDIATELY UPON PLANTING AND 100 PERCENT COVERAGE WITHIN 6 MONTHS AFTER PLANTING.
 - 6.23. TREES AND PALMS SHALL BE MAINTAINED TO ALLOW FOR CLEAR PASSAGE 8' IN ALL PEDESTRIAN AREAS.
 - 6.24. ALL LANDSCAPE MATERIAL SHALL BE SETBACK A MINIMUM OF 10' FROM ANY FIRE HYDRANT.
 - 6.25. CONTRACTOR SHALL REMOVE ALL NURSERY STAKES, CONDUIT, FLAGGING AND NURSERY TAPE PRIOR TO STAKING.
 - 6.26. CONTRACTOR SHALL STAKE & GUY ALL TREES AND PALMS AT TIME OF PLANTING AS PER THE APPROPRIATE DETAIL. CONTRACTOR IS RESPONSIBLE FOR THE MAINTENANCE AND/OR REPAIR OF ALL STAKING AND GUYING DURING WARRANTY PERIOD AND REMOVAL & DISPOSAL OF STAKING AFTER ESTABLISHMENT/WARRANTY PERIOD.
 - 6.27. TREES THAT CANNOT STAND WITHOUT THE SUPPORT OF STAKES AND/OR GUYS SHALL BE REJECTED.
- Consisting of 30% silica sand and 70% muck. Water thoroughly 7.1. All areas not used for buildings, vehicular use areas, walks or planting beds shall be GRASSED. GRASSING SHALL EXTEND TO ANY ABUTTING STREET PAVEMENT EDGE AND TO THE MEAN WATERLINE OF ANY ABUTTING CANAL, LAKE OR WATERWAY. REFER TO PLANTING SCHEDULE FOR ESTIMATED QUANTITY AND SPECIES.
 - MULCH & FERTILIZER
- CTRICAL LINES WITHIN DRIP LINES OF EXISTING TREES. COORDINATE ALL 8.1. ALL PLANTING BEDS AND WATER BASINS FOR TREES SHALL BE COVERED WITH A 3" MINIMUM DEPTH OF SHREDDED FLORI-MULCH, MELALEUCA OR EUCALYPTUS MULCH GRADE 'B' OR BETTER, UNLESS OTHERWISE SPECIFIED.
 - 8.2. INDIVIDUAL TREES PLANTED IN LAWN AREAS SHALL BE MULCHED WITH A MINIMUM 3' DIAMETER MULCH RING.
 - MULCH SHALL NOT BE INSTALLED WITHIN 3" OF TREE TUNKS.
 - 8.4. FERTILIZER MIX AS FOLLOWS:
 - 8.4.1. DICOT TREES & SHRUBS: NPK 18-4-2, SLOW RELEASE W/ MICRONUTRIENTS
 - 8.4.2. MONOCOT PALMS: NPK 8-2-12, SLOW RELEASE W/ MICRONUTRIENTS
 - 8.4.3. TURF: NPK 16-4-8, SLOW RELEASE W/ MICRONUTRIENTS
 - 9. <u>WATERING</u>
 - 9.1. ALL LANDSCAPED AREAS WILL BE IRRIGATED BY AN UNDERGROUND, AUTOMATIC, RUST-FREE IRRIGATION SYSTEM PROVIDING 100% COVERAGE AND 50% SPRAY OVERLAP. THE SYSTEM SHALL BE MAINTAINED IN GOOD WORKING ORDER AND DESIGNED TO MINIMIZE WATER ON IMPERVIOUS SERVICES AND NOT OVERSPRAY WALKWAYS. A RAIN SENSOR DEVICE SHALL BE INSTALLED TO OVERRIDE THE IRRIGATION CYCLE OF THE SYSTEM WHEN ADEQUATE RAINFALL HAS OCCURRED.
- ALL BE INSTALLED IN COMPLIANCE WITH ALL EXISTING CODES AND 9.2. ALL PLANT MATERIAL SHALL BE WATERED IN AT TIME OF PLANTING IN ACCORDANCE WITH STANDARD NURSERY PRACTICES. IN ADDITION, CONTRACTOR WILL CONTINUE THE WATERING OF PLANT MATERIAL UNTIL SUBSTANTIAL COMPLETION AND THE LANDSCAPE IS TURNED OVER TO THE OWNER.

 - 10.1. DURING CONSTRUCTION, THE PROJECT SITE AND ALL ADJACENT AREAS SHALL BE MAINTAINED IN A NEAT AND CLEAN MANNER. UPON FINAL CLEAN UP, THE PROJECT SITE SHALL BE LEFT CLEAR OF ALL SURPLUS MATERIAL OR TRASH. THE PAVED AREAS SHALL BE SWEPT BROOM CLEAN.
 - 10.2. THE CONTRACTOR SHALL RESTORE, REPLACE OR AS DIRECTED BY THE LANDSCAPE ARCHITECT, ANY PUBLIC OR PRIVATE PROPERTY DAMAGED BY THE WORK OF THE CONTRACTOR, HIS EQUIPMENT, EMPLOYEES OR THOSE OF HIS SUB-CONTRACTORS. THIS WORK SHALL BE RESTORED TO A CONDITION EQUAL TO OR BETTER THAN THAT OF THE EXISTING ADJACENT AREAS. THE RESTORATION WORK SHALL BE AT THE CONTRACTOR'S EXPENSE. SUITABLE MATERIALS AND METHODS SHALL BE USED FOR SUCH restoration.
 - WHERE MATERIAL OR DEBRIS HAS WASHED OR FLOWED INTO OR BEEN PLACED IN WATER COURSES, 10.3. DITCHES, DRAINS, CATCH BASINS, OR ELSEWHERE AS A RESULT OF THE CONTRACTOR'S OPERATIONS, SUCH MATERIAL OR DEBRIS SHALL BE REMOVED AND SATISFACTORILY DISPOSED OF DURING PROGRESS OF THE WORK. THESE AREAS SHALL BE KEPT IN A CLEAN AND NEAT CONDITION.
 - 10.4. THE CONTRACTOR SHALL MAINTAIN ACCURATE AND COMPLETE RECORDS OF WORK ITEMS COMPLETED.
 - 10.5. UPON COMPLETION OF CONSTRUCTION, THE CONTRACTOR SHALL SUBMIT TO THE LANDSCAPE ARCHITECT OF RECORD COMPLETE SETS OF "AS-BUILT" CONSTRUCTION DRAWINGS. THESE DRAWINGS SHALL BE MARKED TO SHOW "AS-BUILT" CONSTRUCTION CHANGES AND DIMENSIONED LOCATIONS AND ELEVATIONS OF ALL IMPROVEMENTS INCLUDING PRODUCT/EQUIPMENT AS SPECIFIED OR REVISED DURING THE SHOP DRAWING SUBMITTAL PROCESS. AS-BUILT DRAWINGS SHALL BE SIGNED AND SEALED BY A FLORIDA REGISTERED LAND SURVEYOR.
 - 11. GUARANTEE
- IEDIANS, HARDSCAPE AREAS OR AREAS ENCOMPASSED BY IMPERVIOUS 11.1. ALL NEW PLANT MATERIAL SHALL BE GUARANTEED FOR 1 YEAR FROM TIME OF FINAL ACCEPTANCE OF PROJECT. ANY PLANT MATERIAL NOT IN A HEALTHY GROWING CONDITION WILL BE REPLACED IN KIND BY THE CONTRACTOR AT NO ADDITIONAL COST TO THE OWNER WITHIN 10 DAYS OF NOTIFICATION.
 - 11.2. FOR ALL REPLACEMENT PLANT MATERIAL, THE WARRANTY PERIOD SHALL BE EXTENDED AN ADDITIONAL 90 DAYS BEYOND THE ORIGINAL WARRANTY PERIOD. REPLACEMENT MATERIAL SHALL BE REPLACED IN KIND AS IT RELATES TO SPECIES, QUANTITY AND SIZE.
 - 11.3. ALL TREES THAT LEAN OR ARE BLOWN OVER, CAUSED BY WINDS LESS THAN 74 MPH AS DETERMINED BY THE NATIONAL HURRICANE CENTER, WILL BE RE-SET AND BRACED BY THE CONTRACTOR AT NO ADDITIONAL COST TO THE OWNER.

65% CONSTRUCTION DOCUMENTS



LANDSCAPE **SPECIFICATIONS**

CAB DRAWING TITLE

CHECKED BY

DRAWN BY MSB

MSB

DESIGNED BY

DATE OF ISSUE 2016-10-18

REVISIONS

VERIFY SCALES IF NOT ONE INCH ON THIS SHEET, ADJUST SCALES ACCORDINGLY

CLIENT PROJECT NUMBER PO#160934

FLORIDA PROJECT NUMBER 16-088.006

CITY OF MARGATE,

MARGATE DOG PARK



SUB-CONSULTANT

CLIENT

REGISTRATION JASON J. MCCLAIR **REGISTRATION NO. 56962**

DATE:

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&ASSOCIATES

CHEN-MOORE