

DINING / LIVING ROOM

132'-8"

UNIT C GL

1597

UNIT D GL

1687

DINING / LIVING ROOM

5'-10" 2'-5" 5'-6" 2'-5"

UNIT B GL

1455

LIVING ROOM

GARAGE

GARAGE

UNIT C GL

1597

0

LIVING ROOM

DINING / LIVING ROOM

UNIT D GL


1687

DINING / LIVING

24"8" 8"

UNIT E GL

1741

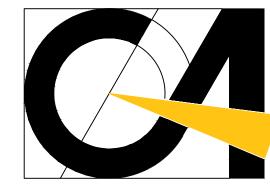

CORWILARCHITECTS 4210 LAGUNA ST. CORAL GABLES FL. 33146 LIC.NO. AA-C002151 T.305.448.7383

PROJECT:

CELEBRATION POINTE SOUTH BROWARD COUNTY FLORIDA

OWNER:

LENNAR **HOMES** 

**PHASE** 

PERMIT SET

**REVISIONS** 

SEAL

THIS DRAWINGS IS THE PROPERTY OF CORWIL ARCHITECTS INC. UNLESS OTHERWISE PROVIDED FOR BY CONTRACT THE CONTENTS OF THIS DRAWINGS ARE CONFIDENTIAL AND SHALL NOT BE TRANSMITTED TO ANY OTHER PARTY EXCEPT AS AGREED TO BY THE ARCHITECT/ ENGINEERS.

DATE: 04-06-17 JOB NO. 2014-46 DRAWN BY AO

APPR BY AMC PRINTED DATE 04-06-17

SHEET NUMBER:


A - 3.0

PROVIDED 2 HOUR FIRE RATED WALL AT TYPICAL DEMISING WALL BETWEEN UNITS, SEE TYPICAL WALL SECTION 4, SHEET A-7.0 FOR DETAILS. 2. ALL ENTRY DOORS SHALL BE DESIGNATED EMERGENCY MEANS OF ESCAPE AND SHALL COMPLY WITH F.B.C. 1005.4.5


GROUND LEVEL FLOOR PLAN SCALE: 1/8" = 1'-0"

NOTE:


FOR ELEVATION DETAILS, AND
WINDOWS PRESSURES, REFER TO
INDIVIDUAL EXTERIOR UNIT
ELEVATIONS.

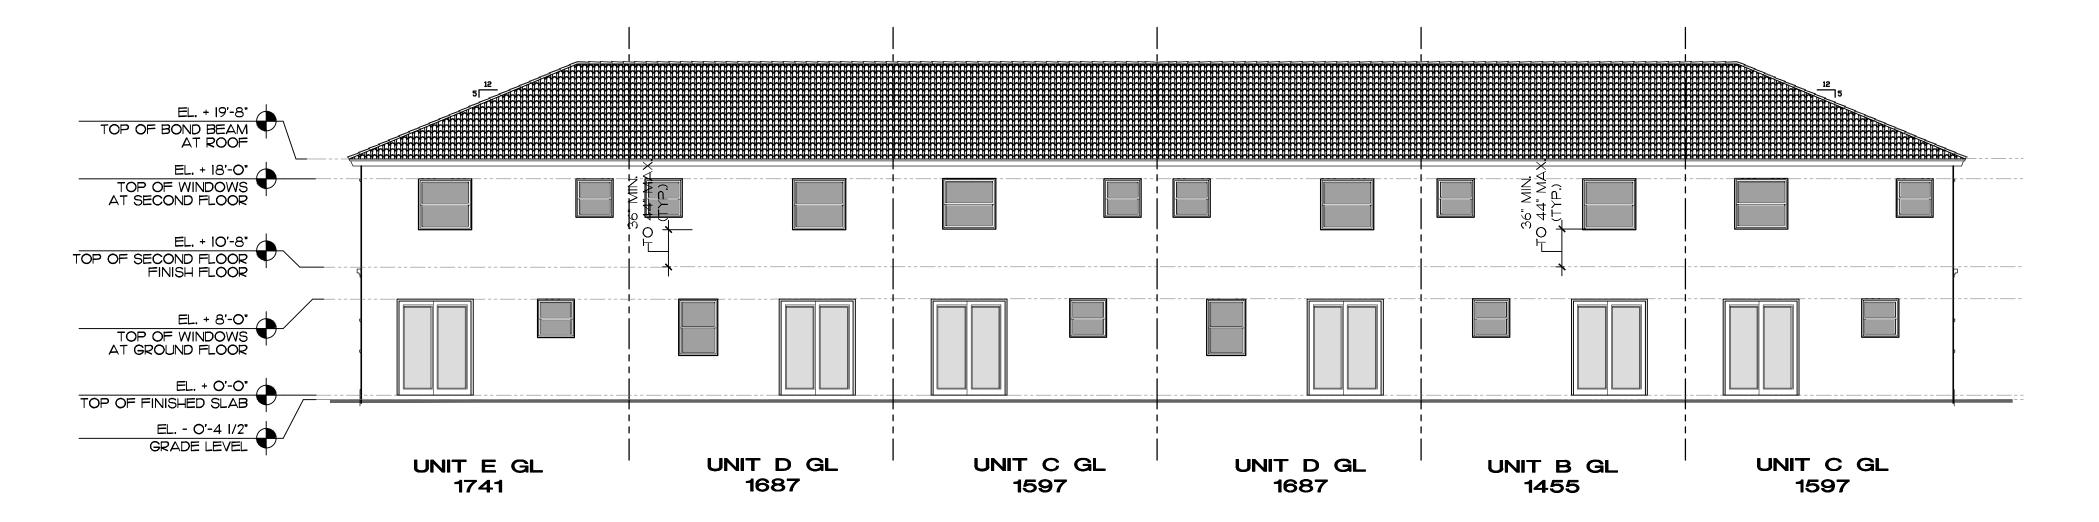

# REAR ELEVATION SCALE: 1/8" = 1'-0"

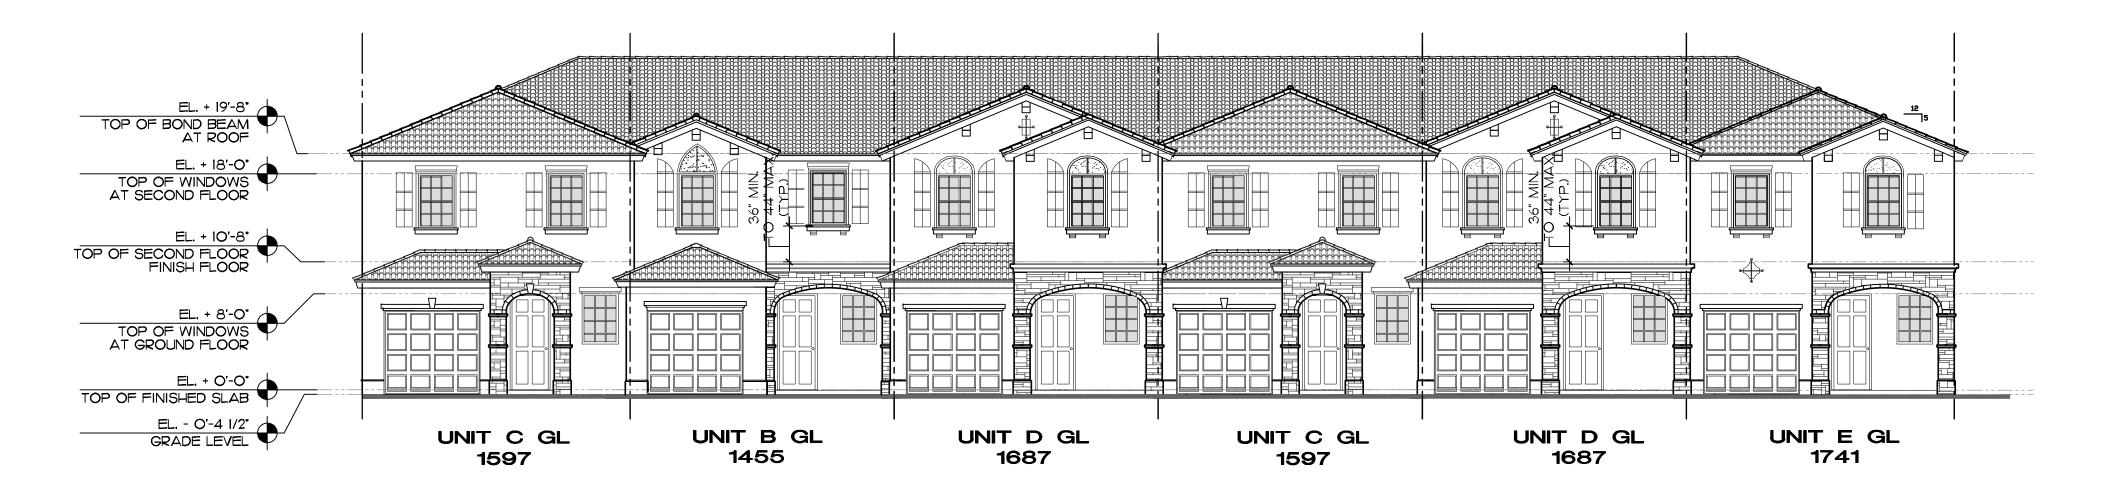


# FRONT ELEVATION SCALE: 1/8" = 1'-0"

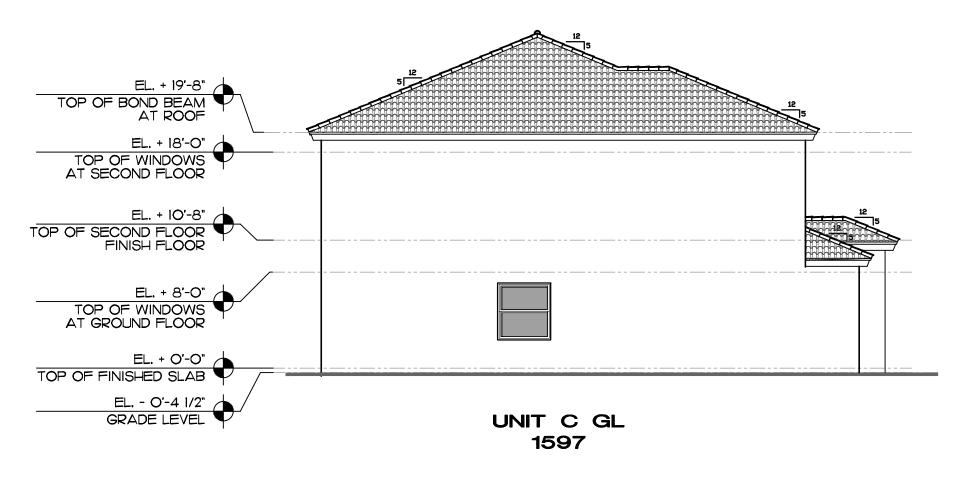


LEFT END ELEVATION

SCALE: 1/8" = 1'-0"

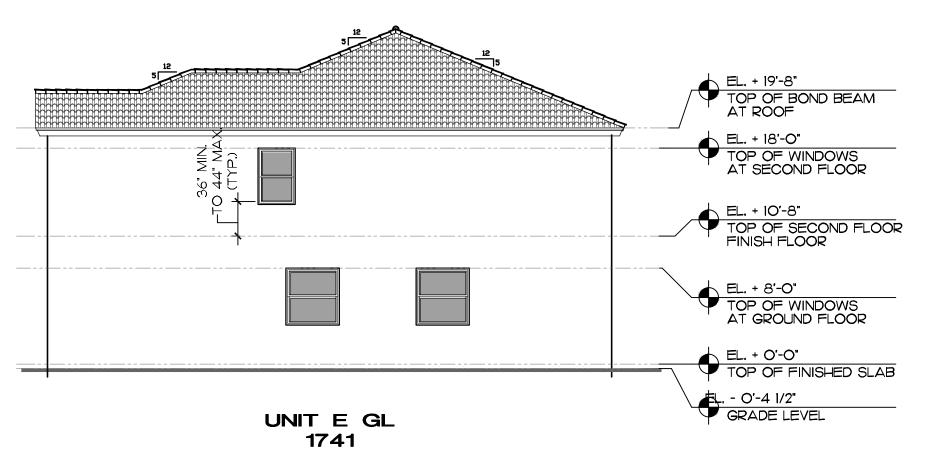

RIGHT END ELEVATION

SCALE: 1/8" = 1'-0"

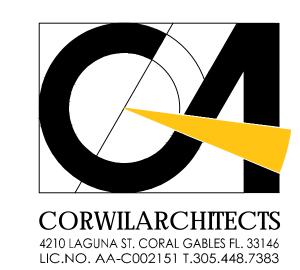

PROJECT:

CELEBRATION POINTE

SOUTH

BROWARD COUNTY

FLORIDA

OWNER:

LENNAR HOMES

> BUILDING - 6 UNITS ELEVATIONS

PERMIT SET

REVISIONS

THIS DRAWINGS IS THE PROPERTY OF CORWIL ARCHITECTS INC. UNLESS OTHERWISE PROVIDED FOR BY CONTRACT, THE CONTENTS OF THIS DRAWINGS ARE CONFIDENTIAL AND SHALL NOT BE TRANSMITTED TO ANY OTHER PARTY EXCEPT AS AGREED TO BY THE ARCHITECT/ ENGINEERS.

DATE: 04-06-17

JOB NO. 2014-46

DRAWN BY AO


APPR BY AMC

PRINTED DATE 04-06-17


SHEET NUMBER:

SEAL

A-4.0

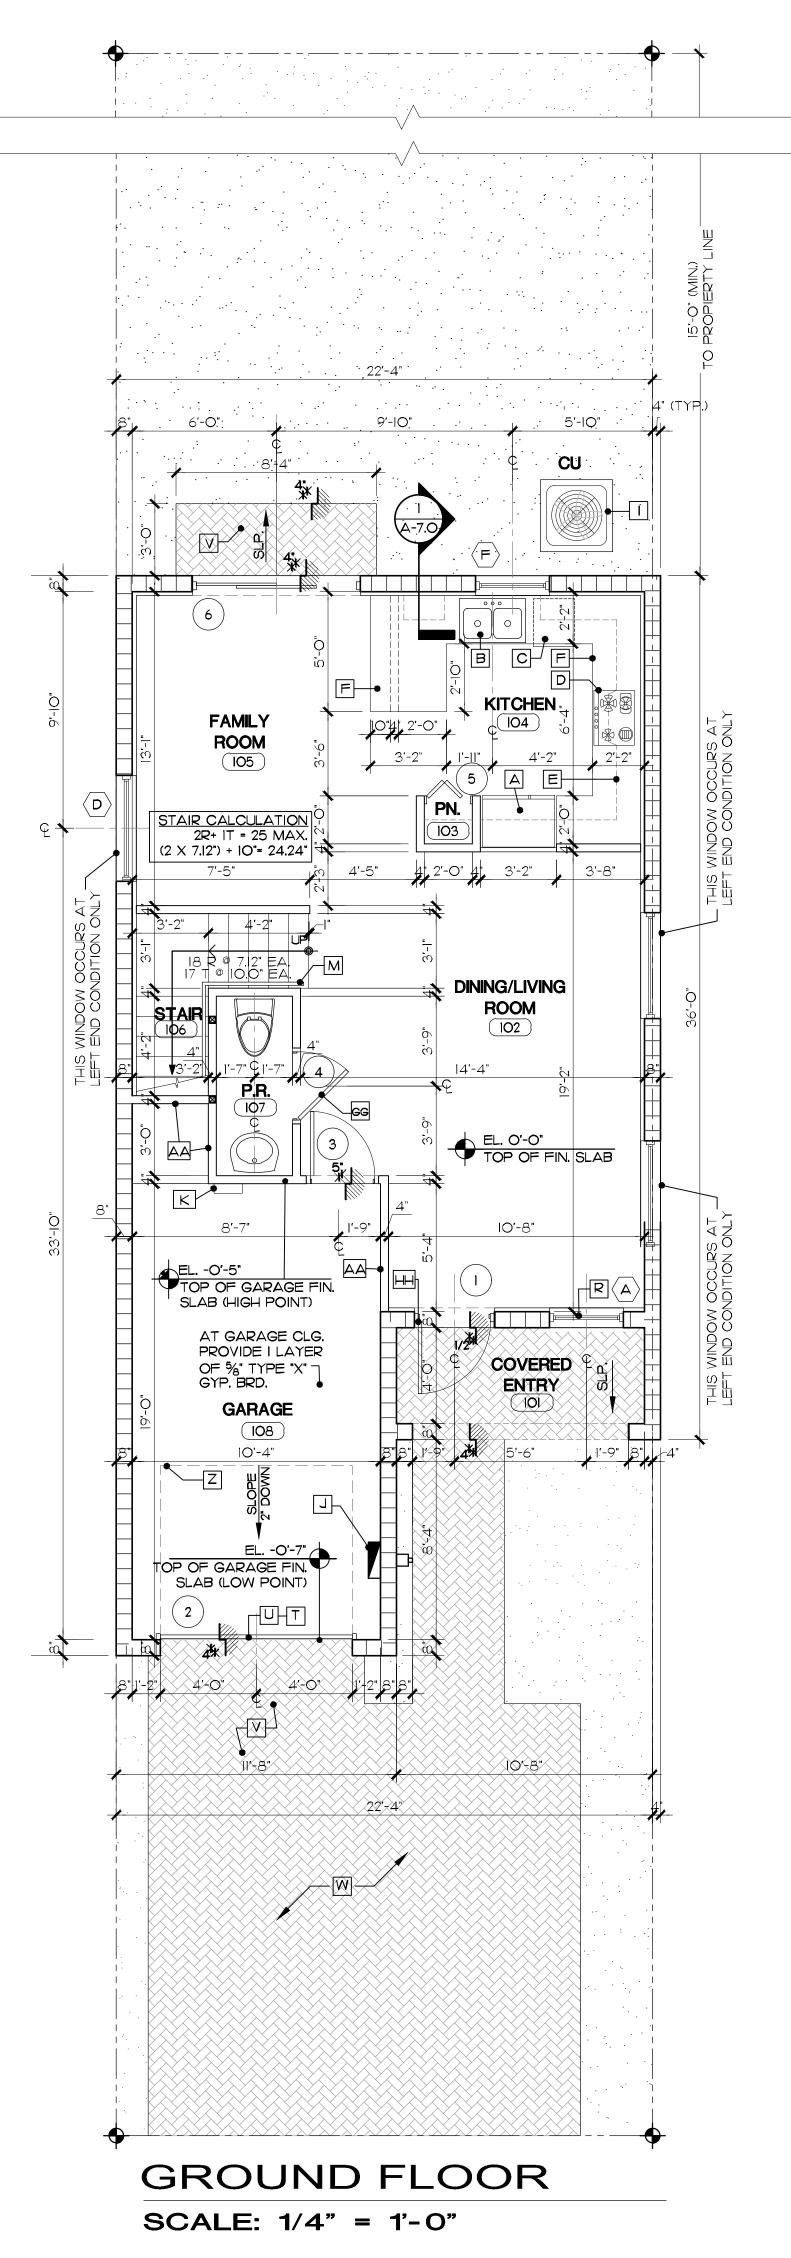

AREA CALCULATIO	N UNIT-B
GROUND FLOOR GROSS AREA	631 S.F.
SECOND FLOOR GROSS AREA	855 S.F.
TOTAL GROSS LIVING SPACE	1,486 S.F.
GARAGE GROSS AREA	238 S.F.
COV. ENTRY	51 S.F.
PATIO AREA	25 S.F.
TOTAL	1,800 S.F.
PRIVATE OUTDOOR PATIO LIVING AREA	667 S.F.

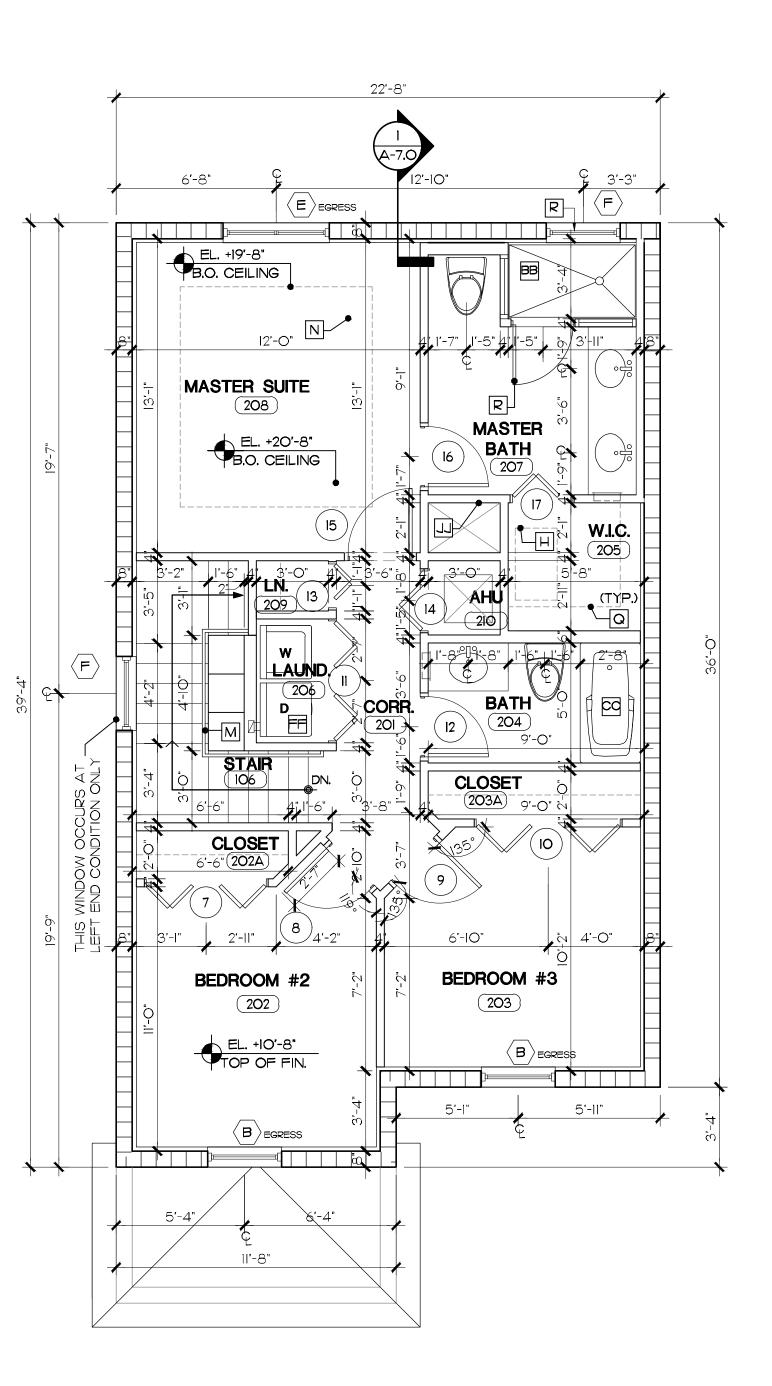

SECOND FLOOR

SCALE: 1/4" = 1'-0"

WALL TYPE LEGEND

3-5/8" OR 6" AT 24" O.C. METAL STUD PARTITION WITH 1/2" GYPSUM WALLBOARD EACH SIDE. 3-5/8" AT 16" O.C. METAL STUD PARTITION WITH

STRUCTURAL DRAWINGS ).

A REFRIGERATOR SPACE

D RANGE WITH MICROWAVE ABOVE.

E LINE OF CABINETS ABOVE

H 22"X36" ATTIC ACCESS PANEL.

K TANKLESS WATER HEATER

DETAIL NO. 2 SHEET A-6.3.2

MI 42" HIGH MIN. WOOD GUARDRAIL

N COFFER CEILING +9'-0" TO +10'-0"

J ELECTRICAL PANEL SURFACE MOUNTED

B SINK

C DISHWASHER

F 36" HIGH COUNTER

G 42" HIGH COUNTER

O ELECT. METER

SCHEDULE)

P MEDICINE CABINET

Q SHELVING BY BUILDER

R CAT. II SAFETY GLASS

S KNEE WALL AT 42" A.F.F.

FLOOR PLAN LEGEND

A/C CONDENSING UNIT PAD (VERIFY SIZE AND LOCATION)

M 34" MIN. TO 38" MAX. HIGH WALL MOUNTED WOOD HANDRAIL

HANDRAIL/ GUARDRAIL 36" MIN, 38" MAX REFER TO

T PROVIDE "DANGER" SIGN (SEE FLOOR PLAN NOTES)

V INTERLOCKING CONCRETE PAVERS ON 1-1/2" SAND

W DRIVEWAY (SEE SITE PLAN FOR CONTINUATION)

BASE OVER WELL COMPACTED FILL

ADJACENT FLOOR SURFACE OF 2"

AA R-II BATT, INSUL, IN WALLS BETWEEN AIR

SUBMIT SHOP DWGS. FOR APPROVAL.

X WALKWAY (PAVERS BY BUILDER)

Z LINE OF OVERHEAD DOOR

THAN 7" A.F.F.

U GARAGE VENTILATION AT GARAGE DOORS, SEE DOOR

42" HIGH, ALUMINUM RAILINGS TO REJECT 4" OBJECTS,

CONDITIONED & NON-CONDITIONED SPACES. R-19 INSUL. IN FLOOR TRUSSES ABOVE GARAGE CEILING.

CC COORDINATE DIMENSION WITH TUB MANUFACTURER.

SQ. FT. PROVIDED (2)-8"XI6" FLOOD VENTS= 256 SQ. IN. FLOOD VENTS SHALL NOT BE LOCATED MORE

EE REINFORCED CMU WALL, REFER TO STRUCTURAL DWGS

HH DESIGNATED MEANS OF ESCAPE WHEN HURRICANE

KK 1/2" RECESS AT FRONT DOOR WITH FULL WIDTH OF 10"

PROTECTION DEVICES ARE IN PLACE.

ARCHED TRANSOM TOP OF OPENING +8'-0"


GG BATHROOM DOOR SHALL BE 29" CLEAR AS PER FBC. R320.I.I

BB SHOWER / TUB STALL SHALL HAVE A SMOOTH, IMPERVIOUS FINISH UP TO 72" PER F.B.C. R307.2

DD IF REQUIRED FLOOD VENTS: GARAGE SIZE =

FF DRYER EXHAUST THROUGH ROOF

WITH MAX, CLEARANCE BETWEEN BOTTOM RAIL AND

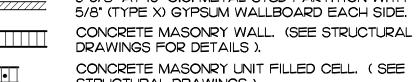



CONCRETE COLUMN, SEE STRUCT. DRAWINGS FOR CORWILARCHITECTS 4210 LAGUNA ST. CORAL GABLES FL. 33146 LIC.NO. AA-C002151 T.305.448.7383

PROJECT:

**CELEBRATION POINTE** SOUTH **BROWARD COUNTY FLORIDA** 

OWNER:

**LENNAR HOMES** 

 $\otimes$ 

PHASE	
	PERMIT SET

FLOOR PLAN NOTES: REFER TO STRUCTURAL DWGS, FOR STRUCTURAL DETAILS REVISIONS FOR WINDOW AND DOOR ELEVATIONS / SEE DETAILS THIS

B. GARAGE NOTES A) \* PROVIDE PERMANENT SIGN ( WITH LETTERS NOT LESS

THAN 1/2", READING: "DANGER DO NOT OPERATE ENGINES W/ DOOR CLOSED CARBON, MONOXIDE EMISSION IS B) \* PROVIDE SCREENED OPENINGS THROUGH GARAGE DOOR W/ THE CLEAR EFFECTIVE AREA NOT LESS THAN 60 SQ. IN. PER

OF THE FLOOR). . EGRESS WINDOWS SHALL BE OPERABLE FROM THE INSIDE WITHOUT THE USE OF TOOLS, EGRESS WINDOWS SHALL HAVE A MINIMAL NET OPENING OF 24" HIGH, 20" WIDE, AND MIN. NET AREA OF 5.7 S.F. FOR 2ND FLOOR WINDOWS AND 5.0 S.F. FOR IST FLOOR WINDOWS. THE BOTTOM OF THE OPENING SHALL NOT BE MORE THAN 44" ABOVE THE FLOOR, LATCH AT 54" A.F.F. MAX. IN HVHZ AREAS WHERE THERE IS MORE THAN A 4'-O" DROP, THE SILL SHALL BE NO LESS THAN 42" A.F.F. OR PROVIDE AN APPROVED SAFEGUARD.

MOTOR VEHICLE (LOCATED WITHIN 7 IN. OF THE HIGHEST PART

. EVERY CLOSET DOOR LATCH SHALL BE SUCH THAT CHILDREN CAN OPEN THE DOOR FROM INSIDE THE CLOSET AS PER NFPA IOI.

. EVERY BATHROOM DOOR SHALL BE DESIGNED TO ALLOW OPENING FROM THE OUTSIDE DURING AN EMERGENCY WHEN LOCKED AS PER NFPA IOI.

A PERMANENT SIGN WHICH IDENTIFIES THE TERMITE TREATMENT PROVIDER AND NEED FOR REINSPECTION AND TREATMENT CONTRACT RENEWAL SHALL BE PROVIDED. THE SIGN SHALL BE POSTED NEAR THE WATER HEATER OR ELECTRICAL PANEL.

8. ALL BATHROOM FLOORS AND BASES SHALL BE OF APPROVED IMPERVIOUS MATERIALS.

9. ALL BATHTUB AND SHOWER FLOORS AND WALLS ABOVE BATHTUBS WITH INSTALLED SHOWER HEADS AND IN SHOWER COMPARTMENTS SHALL BE FINISHED WITH A NONABSORBANT SURFACE TO A HEIGHT OF NOT LESS

THAN 6 FEET. IO. IN HVHZ AREAS PROVIDE HURRICANE SHUTTERS AS PER F.B.C. SECTION 2413 UNLESS THE EXTERIOR WALL COMPONENTS OF THE ENCLOSED BUILDING HAS SPECIFIC PRODUCT APPROVAL TO PRESERVE THE ENCLOSED BUILDING ENVELOPE AGAINST IMPACT LOADS AS SET FORTH IN CHAPTER 16.

HURRICANE SHUTTERS FOR WINDOWS ABOVE THE FIRST FLOOR SHALL BE CLOSABLE / INSTALLABLE FROM THE INSIDE OF BUILDING WITHOUT THE USE OF A LADDER AS PER F.B.C. 2413.6.1 2. ALL ENTRY DOORS SHALL BE DESIGNATED EGRESS DOOR AS PER FBC R311

THIS DRAWINGS IS THE PROPERTY OF CORWIL ARCHITECTS INC. UNLESS OTHERWISE PROVIDED FOR BY CONTRACT, THE CONTENTS OF THIS DRAWINGS ARE CONFIDENTIAL AND SHALL NOT BE TRANSMITTED TO ANY OTHER PARTY EXCEPT AS AGREED TO BY THE ARCHITECT/ ENGINEERS.


DATE: 04-06-17


JOB NO. 2014-46 DRAWN BY AO


APPR BY AMC PRINTED DATE 04-06-17

SHEET NUMBER:

A-6.0.0

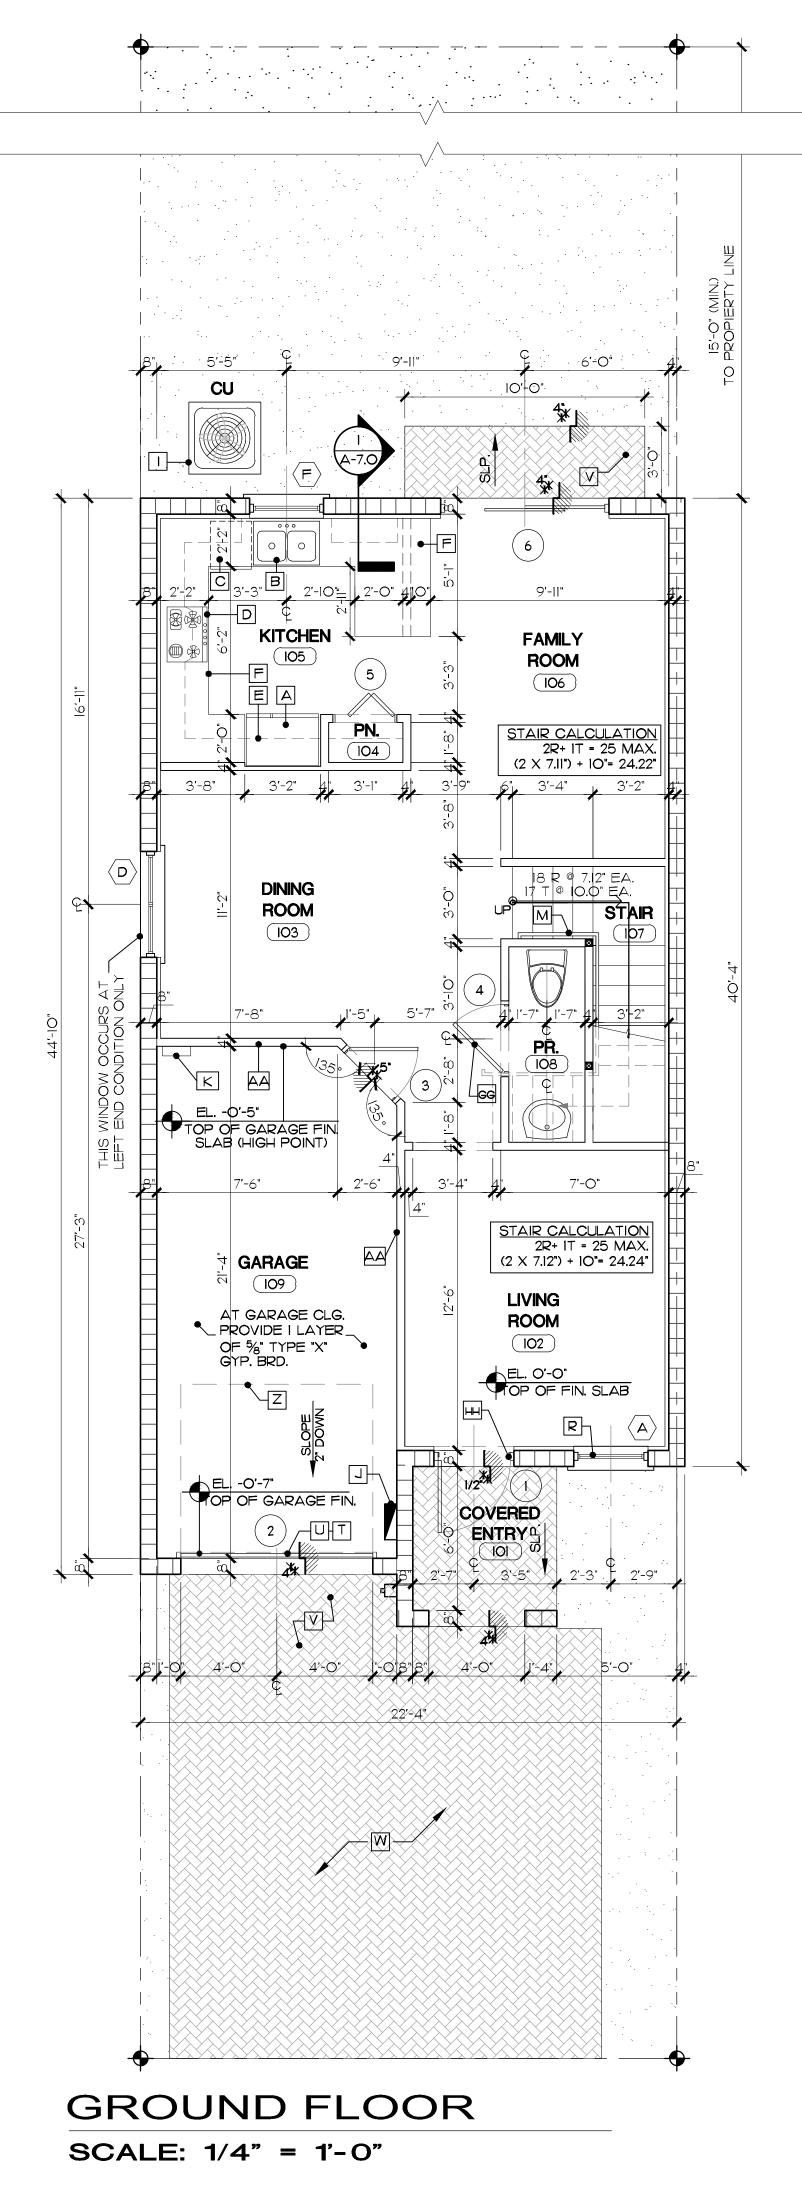

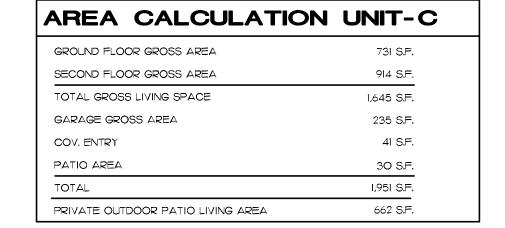

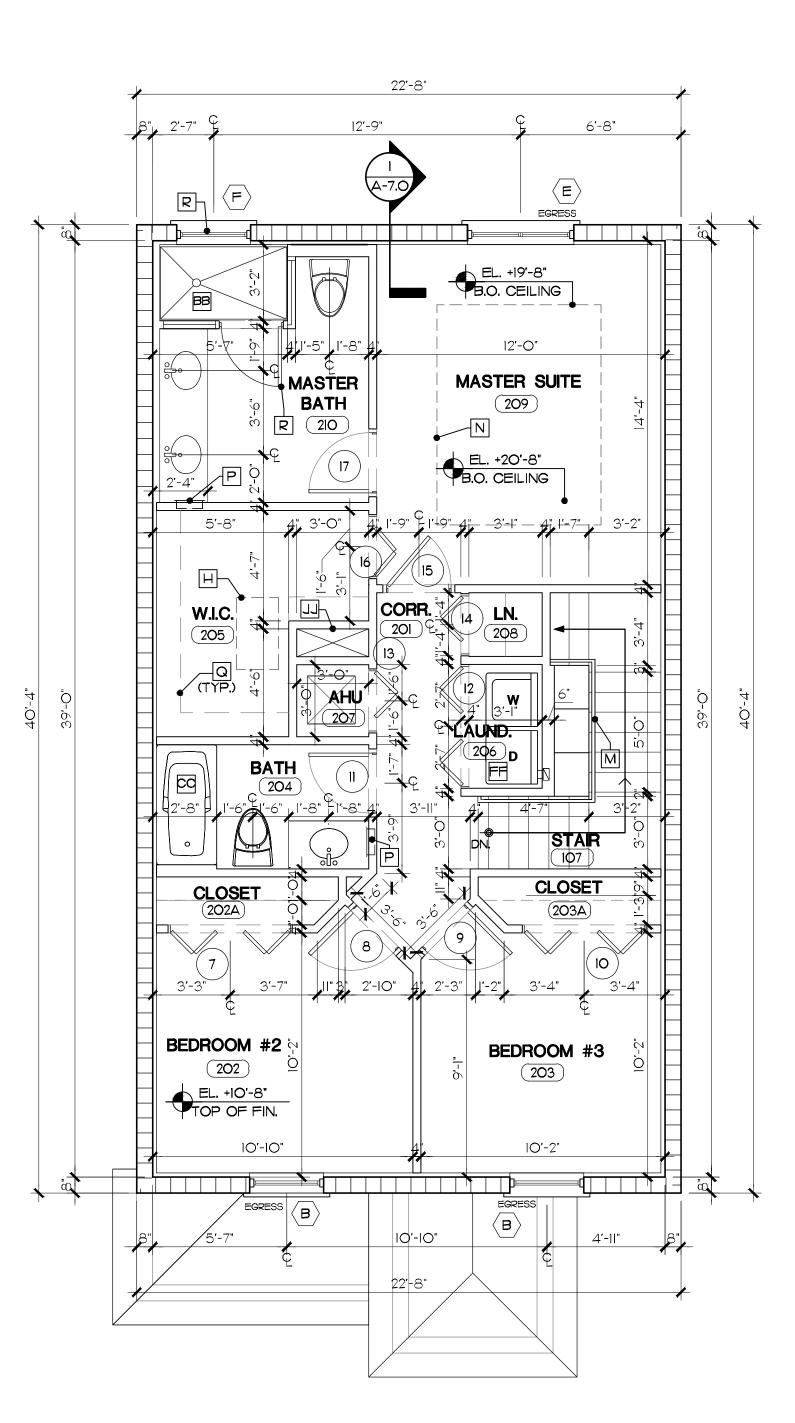

## SECOND FLOOR

SCALE: 1/4" = 1'-0"

WALL TYPE LEGEND

WITH I/2" GYPSUM WALLBOARD EACH SIDE.

3-5/8" AT I6" O.C. METAL STUD PARTITION WITH

5/8" (TYPE X) GYPSUM WALLBOARD EACH SIDE.

CONCRETE MASONRY WALL. (SEE STRUCTURAL DRAWINGS FOR DETAILS).

CONCRETE MASONRY UNIT FILLED CELL. (SEE STRUCTURAL DRAWINGS)

3-5/8" OR 6" AT 24" O.C. METAL STUD PARTITION

STRUCTURAL DRAWINGS ).

CONCRETE COLUMN, SEE STRUCT. DRAWINGS FOR

#### FLOOR PLAN LEGEND

A REFRIGERATOR SPACE

B SINK

C DISHWASHER

D RANGE WITH MICROWAVE ABOVE.

E LINE OF CABINETS ABOVE

F 36" HIGH COUNTER

G 42" HIGH COUNTER

H 22"X36" ATTIC ACCESS PANEL.

A/C CONDENSING UNIT PAD (VERIFY SIZE AND LOCATION)

J ELECTRICAL PANEL SURFACE MOUNTED

K TANKLESS WATER HEATER

HANDRAIL/ GUARDRAIL 36" MIN, 38" MAX REFER TO DETAIL NO. 2 SHEET A-6.3.2

M 34" MIN, TO 38" MAX. HIGH WALL MOUNTED WOOD HANDRAIL
MI) 42" HIGH MIN. WOOD GUARDRAIL

N COFFER CEILING +9'-0" TO +10'-0"

O ELECT. METER

P MEDICINE CABINET

Q SHELVING BY BUILDER

R CAT. II SAFETY GLASS

S KNEE WALL AT 42" A.F.F.

T PROVIDE "DANGER" SIGN (SEE FLOOR PLAN NOTES)

U GARAGE VENTILATION AT GARAGE DOORS, SEE DOOR SCHEDULE)

INTERLOCKING CONCRETE PAVERS ON 1-1/2" SAND BASE OVER WELL COMPACTED FILL

W DRIVEWAY (SEE SITE PLAN FOR CONTINUATION)

X WALKWAY (PAVERS BY BUILDER)

42" HIGH, ALUMINUM RAILINGS TO REJECT 4" OBJECTS, WITH MAX. CLEARANCE BETWEEN BOTTOM RAIL AND ADJACENT FLOOR SURFACE OF 2" SUBMIT SHOP DWGS. FOR APPROVAL.

Z LINE OF OVERHEAD DOOR

AA R-11 BATT, INSUL, IN WALLS BETWEEN AIR CONDITIONED & NON-CONDITIONED SPACES. R-19 INSUL, IN FLOOR TRUSSES ABOVE GARAGE CEILING.

BB SHOWER / TUB STALL SHALL HAVE A SMOOTH, IMPERVIOUS FINISH UP TO 72" PER F.B.C. R307.2

CC COORDINATE DIMENSION WITH TUB MANUFACTURER.

DD IF REQUIRED FLOOD VENTS: GARAGE SIZE = SQ. FT. PROVIDED (2)-8"X16" FLOOD VENTS = 256 SQ. IN. FLOOD VENTS SHALL NOT BE LOCATED MORE

THAN 7" A.F.F.

EE REINFORCED CMU WALL, REFER TO STRUCTURAL DWGS

FF DRYER EXHAUST THROUGH ROOF

GG BATHROOM DOOR SHALL BE 29" CLEAR AS PER FBC. R320.I.I

HH DESIGNATED MEANS OF ESCAPE WHEN HURRICANE PROTECTION DEVICES ARE IN PLACE.

ARCHED TRANSOM TOP OF OPENING +8'-0"

LI CHASE

#### FLOOR PLAN NOTES:

1. REFER TO STRUCTURAL DWGS. FOR STRUCTURAL DETAILS
2. FOR WINDOW AND DOOR ELEVATIONS / SEE DETAILS THIS

KK 1/2" RECESS AT FRONT DOOR WITH FULL WIDTH OF 10"

SHEET.

3. GARAGE NOTES:

AS PER FBC R3II

A) \* PROVIDE PERMANENT SIGN ( WITH LETTERS NOT LESS THAN I/2", READING: "DANGER DO NOT OPERATE ENGINES W/ DOOR CLOSED CARBON, MONOXIDE EMISSION IS

B) \* PROVIDE SCREENED OPENINGS THROUGH GARAGE DOOR W/ THE CLEAR EFFECTIVE AREA NOT LESS THAN 60 SQ. IN. PER MOTOR VEHICLE (LOCATED WITHIN 7 IN. OF THE HIGHEST PART OF THE FLOOR).

4. EGRESS WINDOWS SHALL BE OPERABLE FROM THE INSIDE WITHOUT THE USE OF TOOLS. EGRESS WINDOWS SHALL HAVE A MINIMAL NET OPENING OF 24" HIGH, 20" WIDE, AND MIN. NET AREA OF 5.7 S.F. FOR 2ND FLOOR WINDOWS AND 5.0 S.F. FOR IST FLOOR WINDOWS. THE BOTTOM OF THE OPENING SHALL NOT BE MORE THAN 44" ABOVE THE FLOOR, LATCH AT 54" A.F.F. MAX. IN HVHZ AREAS WHERE THERE IS MORE THAN A 4'-O" DROP, THE SILL SHALL BE NO LESS THAN 42" A.F.F. OR PROVIDE AN APPROVED SAFEGUARD.

5. EVERY CLOSET DOOR LATCH SHALL BE SUCH THAT CHILDREN CAN OPEN THE DOOR FROM INSIDE THE CLOSET AS PER NFPA IOI.

6. EVERY BATHROOM DOOR SHALL BE DESIGNED TO ALLOW OPENING FROM THE OUTSIDE DURING AN EMERGENCY WHEN LOCKED AS PER NFPA 101.

7. A PERMANENT SIGN WHICH IDENTIFIES THE TERMITE TREATMENT PROVIDER AND NEED FOR REINSPECTION AND TREATMENT CONTRACT RENEWAL SHALL BE PROVIDED. THE SIGN SHALL BE POSTED NEAR THE WATER HEATER OR ELECTRICAL PANEL.

8. ALL BATHROOM FLOORS AND BASES SHALL BE OF APPROVED IMPERVIOUS MATERIALS.


9. ALL BATHTUB AND SHOWER FLOORS AND WALLS ABOVE BATHTUBS WITH INSTALLED SHOWER HEADS AND IN SHOWER COMPARTMENTS SHALL BE FINISHED WITH A NONABSORBANT SURFACE TO A HEIGHT OF NOT LESS THAN 6 FEET.

O. IN HVHZ AREAS PROVIDE HURRICANE SHUTTERS AS PER F.B.C. SECTION 2413 UNLESS THE EXTERIOR WALL COMPONENTS OF THE ENCLOSED BUILDING HAS SPECIFIC PRODUCT APPROVAL TO PRESERVE THE ENCLOSED BUILDING ENVELOPE AGAINST IMPACT LOADS AS SET FORTH IN CHAPTER 16.

HURRICANE SHUTTERS FOR WINDOWS ABOVE THE FIRST FLOOR

SHALL BE CLOSABLE / INSTALLABLE FROM THE INSIDE OF
BUILDING WITHOUT THE USE OF A LADDER AS PER F.B.C. 2413.6.1

ALL ENTRY DOORS SHALL BE DESIGNATED EGRESS DOOR

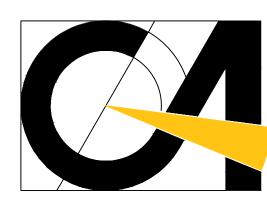

CORWILARCHITECTS
4210 LAGUNA ST. CORAL GABLES FL. 33146
LIC.NO. AA-C002151 T.305.448.7383

PROJECT:

CELEBRATION POINTE
SOUTH
BROWARD COUNTY
FLORIDA

OWNER:

LENNAR HOMES

UNIT 'C' LOOR PLANS & NOT

HASE	
	PERMIT SE

\_\_\_\_

SEAL

**REVISIONS** 

THIS DRAWINGS IS THE PROPERTY OF CORWIL ARCHITECTS INC.
UNLESS OTHERWISE PROVIDED FOR BY CONTRACT,
THE CONTENTS OF THIS DRAWINGS ARE CONFIDENTIAL
AND SHALL NOT BE TRANSMITTED TO ANY OTHER PARTY

THE CONTENTS OF THIS DRAWINGS ARE CONFIDENTIAL AND SHALL NOT BE TRANSMITTED TO ANY OTHER PARTY EXCEPT AS AGREED TO BY THE ARCHITECT/ ENGINEERS.

DATE: 04-06-17

JOB NO. 2014-46

AMC

04-06-17


APPR BY

PRINTED DATE

SHEET NUMBER:


DRAWN BY

A-6.1.0

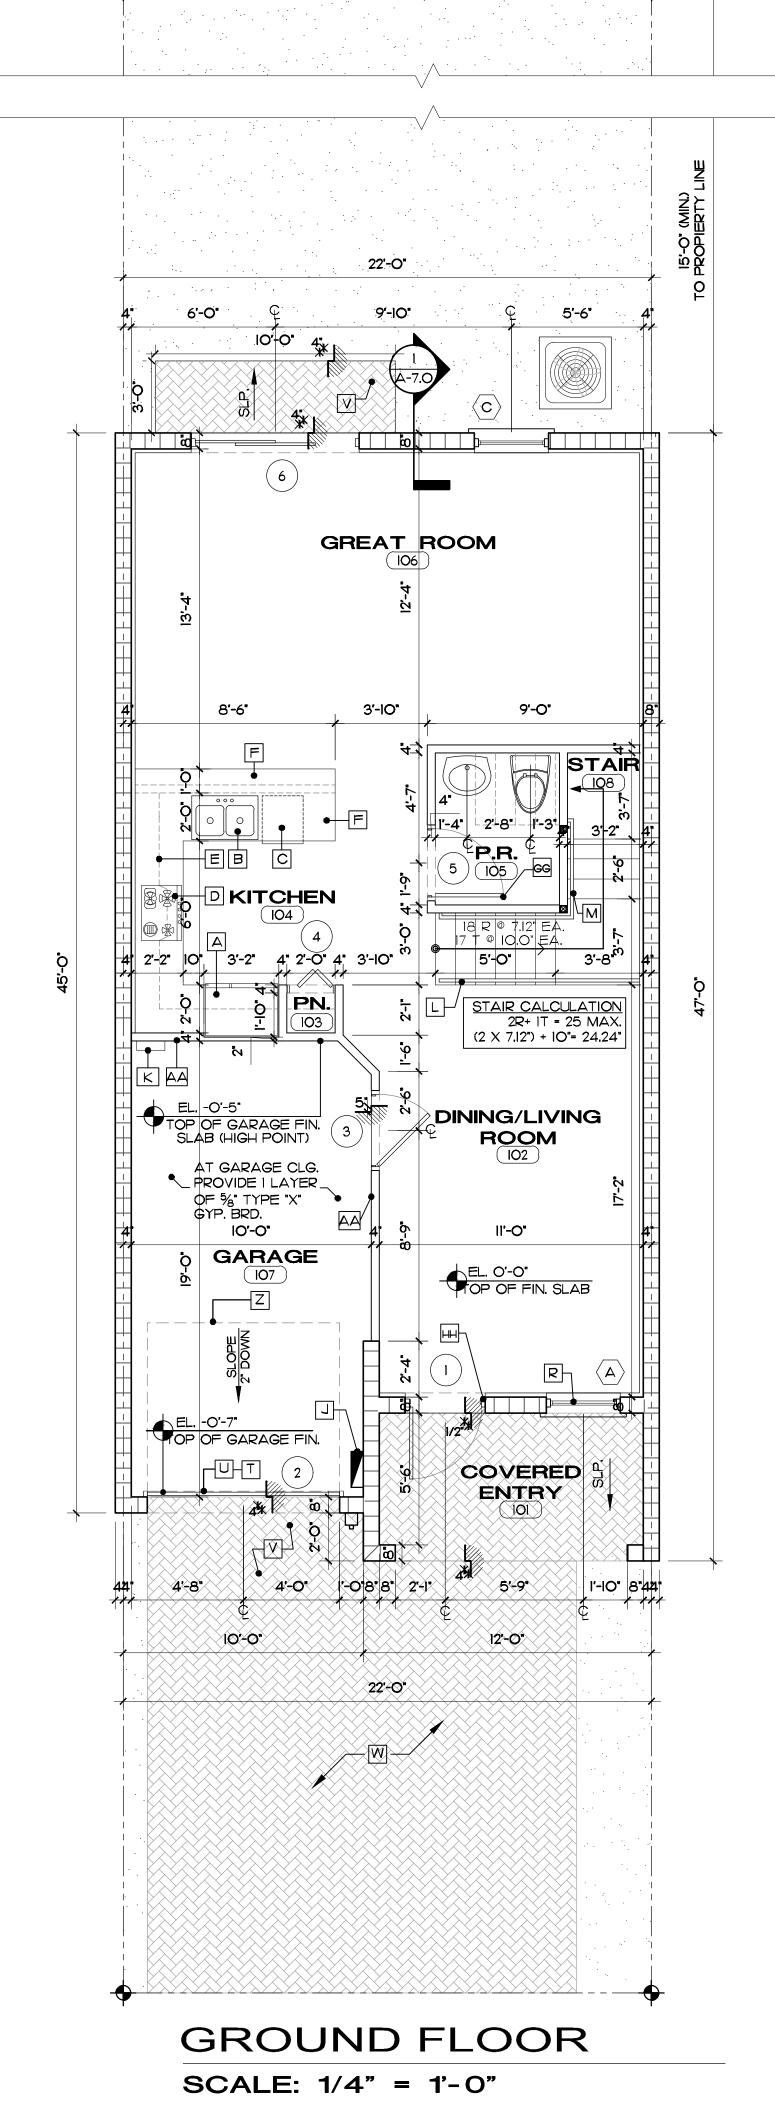

### AREA CALCULATION MODEL 'D'

GROUND FLOOR GROSS AREA	762 S.F.
SECOND FLOOR GROSS AREA	986 S.F.
TOTAL GROSS LIVING SPACE	1,748 S.F.
GARAGE GROSS AREA	209 S.F.
COV. ENTRY	73 S.F.
PATIO AREA	30 S.F.
TOTAL	2,060 S.F.
PRIVATE OUTDOOR PATIO LIVING AREA	652 S.F.

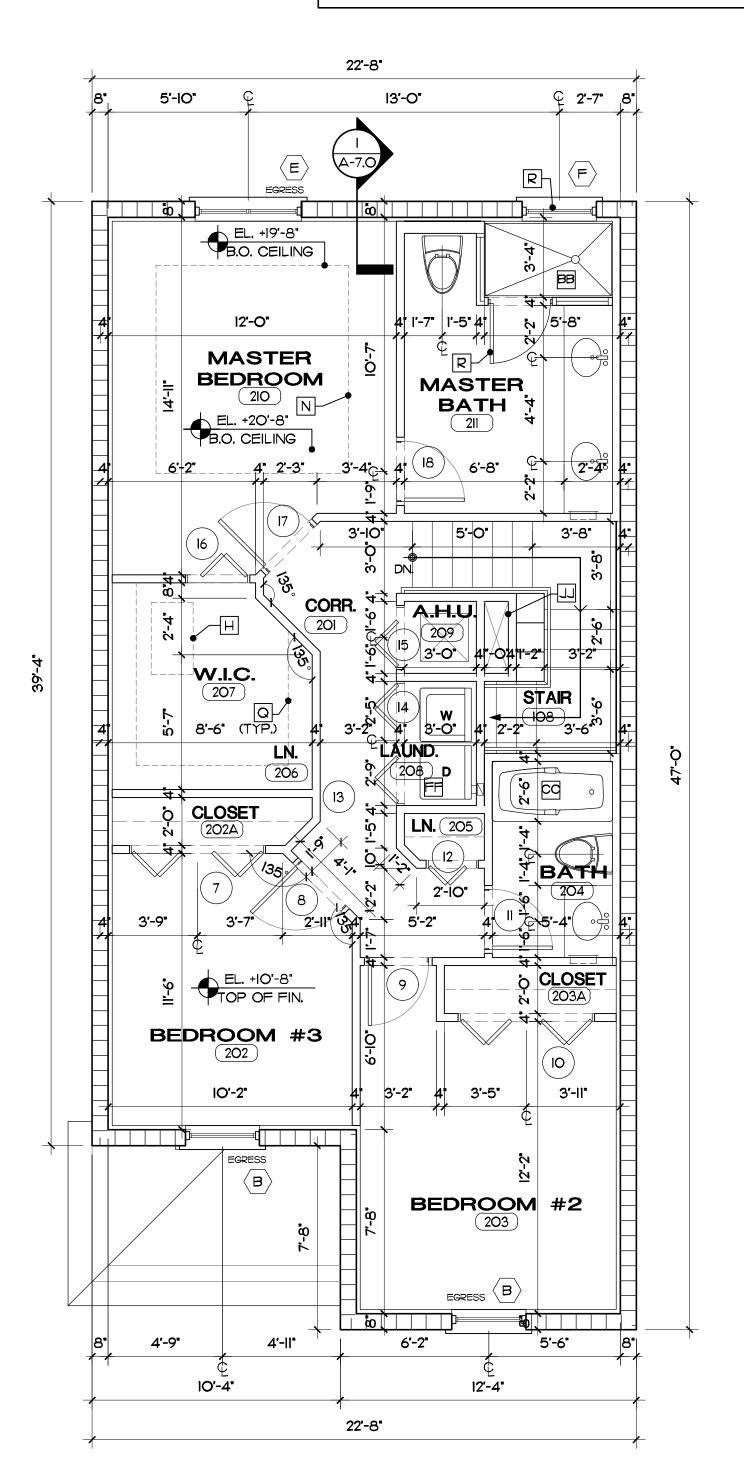

SECOND FLOOR

SCALE: 1/4" = 1'-0"

## WALL TYPE LEGEND

3-5/8" OR 6" AT 24" O.C. METAL STUD PARTITION WITH 1/2" GYPSUM WALLBOARD EACH SIDE. 3-5/8" AT 16" O.C. METAL STUD PARTITION WITH 5/8" (TYPE X) GYPSUM WALLBOARD EACH SIDE. CONCRETE MASONRY WALL. (SEE STRUCTURAL DRAWINGS FOR DETAILS ).

STRUCTURAL DRAWINGS ).

#### CONCRETE MASONRY UNIT FILLED CELL. ( SEE CONCRETE COLUMN, SEE STRUCT. DRAWINGS FOR DETAILS

#### FLOOR PLAN LEGEND

A REFRIGERATOR SPACE

B SINK C DISHWASHER

D RANGE WITH MICROWAVE ABOVE.

E LINE OF CABINETS ABOVE F 36" HIGH COUNTER

G 42" HIGH COUNTER

H 22"X36" ATTIC ACCESS PANEL.

A/C CONDENSING UNIT PAD (VERIFY SIZE AND LOCATION)

J ELECTRICAL PANEL SURFACE MOUNTED

K TANKLESS WATER HEATER

HANDRAIL/ GUARDRAIL 36" MIN, 38" MAX REFER TO DETAIL NO. 2 SHEET A-6.3.2

M 34" MIN. TO 38" MAX. HIGH WALL MOUNTED WOOD HANDRAIL MI 42" HIGH MIN. WOOD GUARDRAIL

N COFFER CEILING +9'-0" TO +10'-0"

O ELECT. METER P MEDICINE CABINET

Q SHELVING BY BUILDER

R CAT. II SAFETY GLASS

S KNEE WALL AT 42" A.F.F.

T PROVIDE "DANGER" SIGN (SEE FLOOR PLAN NOTES)

U GARAGE VENTILATION AT GARAGE DOORS, SEE DOOR SCHEDULE)

V INTERLOCKING CONCRETE PAVERS ON 1-1/2" SAND BASE OVER WELL COMPACTED FILL

W DRIVEWAY (SEE SITE PLAN FOR CONTINUATION)

X WALKWAY (PAVERS BY BUILDER)

Y 42" HIGH, ALUMINUM RAILINGS TO REJECT 4" OBJECTS, WITH MAX. CLEARANCE BETWEEN BOTTOM RAIL AND ADJACENT FLOOR SURFACE OF 2"

SUBMIT SHOP DWGS, FOR APPROVAL. |Z| LINE OF OVERHEAD DOOR

AA R-11 BATT. INSUL. IN WALLS BETWEEN AIR CONDITIONED & NON-CONDITIONED SPACES. R-19 INSUL. IN FLOOR TRUSSES ABOVE GARAGE CEILING.

BB SHOWER / TUB STALL SHALL HAVE A SMOOTH, IMPERVIOUS FINISH UP TO 72" PER F.B.C. R307.2

CO COORDINATE DIMENSION WITH TUB MANUFACTURER.

DD IF REQUIRED FLOOD VENTS: GARAGE SIZE = SQ. FT. PROVIDED (2)-8"XI6" FLOOD VENTS= 256 SQ. IN. FLOOD VENTS SHALL NOT BE LOCATED MORE

THAN 7" A.F.F. E REINFORCED CMU WALL, REFER TO STRUCTURAL DWGS

FF DRYER EXHAUST THROUGH ROOF

GG BATHROOM DOOR SHALL BE 29" CLEAR AS PER FBC. R320.I.I

HH DESIGNATED MEANS OF ESCAPE WHEN HURRICANE PROTECTION DEVICES ARE IN PLACE.

II ARCHED TRANSOM TOP OF OPENING +8'-O"

U CHASE

KK 1/2" RECESS AT FRONT DOOR WITH FULL WIDTH OF 10"

#### FLOOR PLAN NOTES: REFER TO STRUCTURAL DWGS. FOR STRUCTURAL DETAILS

FOR WINDOW AND DOOR ELEVATIONS / SEE DETAILS THIS

B. GARAGE NOTES:

A) \* PROVIDE PERMANENT SIGN ( WITH LETTERS NOT LESS THAN 1/2", READING: "DANGER DO NOT OPERATE ENGINES W/ DOOR CLOSED CARBON, MONOXIDE EMISSION IS

B) \* PROVIDE SCREENED OPENINGS THROUGH GARAGE DOOR W/ THE CLEAR EFFECTIVE AREA NOT LESS THAN 60 SQ. IN. PER MOTOR VEHICLE (LOCATED WITHIN 7 IN. OF THE HIGHEST PART OF THE FLOOR).

. EGRESS WINDOWS SHALL BE OPERABLE FROM THE INSIDE WITHOUT THE USE OF TOOLS. EGRESS WINDOWS SHALL HAVE A MINIMAL NET OPENING OF 24" HIGH, 20" WIDE, AND MIN. NET AREA OF 5.7 S.F. FOR 2ND FLOOR WINDOWS AND 5.0 S.F. FOR IST FLOOR WINDOWS. THE BOTTOM OF THE OPENING SHALL NOT BE MORE THAN 44" ABOVE THE FLOOR, LATCH AT 54" A.F.F. MAX. IN HVHZ AREAS WHERE THERE IS MORE THAN A 4'-O" DROP, THE SILL SHALL BE NO LESS THAN 42" A.F.F. OR PROVIDE AN APPROVED SAFEGUARD.

5. EVERY CLOSET DOOR LATCH SHALL BE SUCH THAT CHILDREN CAN OPEN THE DOOR FROM INSIDE THE CLOSET AS PER NFPA IOI.

. EVERY BATHROOM DOOR SHALL BE DESIGNED TO ALLOW OPENING FROM THE OUTSIDE DURING AN EMERGENCY WHEN LOCKED AS PER NFPA 101.

. A PERMANENT SIGN WHICH IDENTIFIES THE TERMITE TREATMENT PROVIDER AND NEED FOR REINSPECTION AND TREATMENT CONTRACT RENEWAL SHALL BE PROVIDED. THE SIGN SHALL BE POSTED NEAR THE WATER HEATER OR

ELECTRICAL PANEL. 8. ALL BATHROOM FLOORS AND BASES SHALL BE OF APPROVED IMPERVIOUS MATERIALS.

9. ALL BATHTUB AND SHOWER FLOORS AND WALLS ABOVE BATHTUBS WITH INSTALLED SHOWER HEADS AND IN SHOWER COMPARTMENTS SHALL BE FINISHED WITH A NONABSORBANT SURFACE TO A HEIGHT OF NOT LESS THAN 6 FEET.

O, IN HVHZ AREAS PROVIDE HURRICANE SHUTTERS AS PER F.B.C. SECTION 2413 UNLESS THE EXTERIOR WALL COMPONENTS OF THE ENCLOSED BUILDING HAS SPECIFIC PRODUCT APPROVAL TO PRESERVE THE ENCLOSED BUILDING ENVELOPE AGAINST IMPACT LOADS AS SET FORTH IN CHAPTER 16.

HURRICANE SHUTTERS FOR WINDOWS ABOVE THE FIRST FLOOR SHALL BE CLOSABLE / INSTALLABLE FROM THE INSIDE OF BUILDING WITHOUT THE USE OF A LADDER AS PER F.B.C. 2413.6.1 2. ALL ENTRY DOORS SHALL BE DESIGNATED EGRESS DOOR AS PER FBC R3II



CORWILARCHITECTS 4210 LAGUNA ST. CORAL GABLES FL. 33146 LIC.NO. AA-C002151 T.305.448.7383

PROJECT:

CELEBRATION POINTE SOUTH **BROWARD COUNTY FLORIDA** 

OWNER:

LENNAR **HOMES** 

**PHASE** 

PERMIT SET

**REVISIONS** 

THIS DRAWINGS IS THE PROPERTY OF CORWIL ARCHITECTS INC. UNLESS OTHERWISE PROVIDED FOR BY CONTRACT, THE CONTENTS OF THIS DRAWINGS ARE CONFIDENTIAL

EXCEPT AS AGREED TO BY THE ARCHITECT/ ENGINEERS. DATE: 04-06-17

AND SHALL NOT BE TRANSMITTED TO ANY OTHER PARTY


2014-46

DRAWN BY


PRINTED DATE 04-06-17

SHEET NUMBER:

A-6.2.0

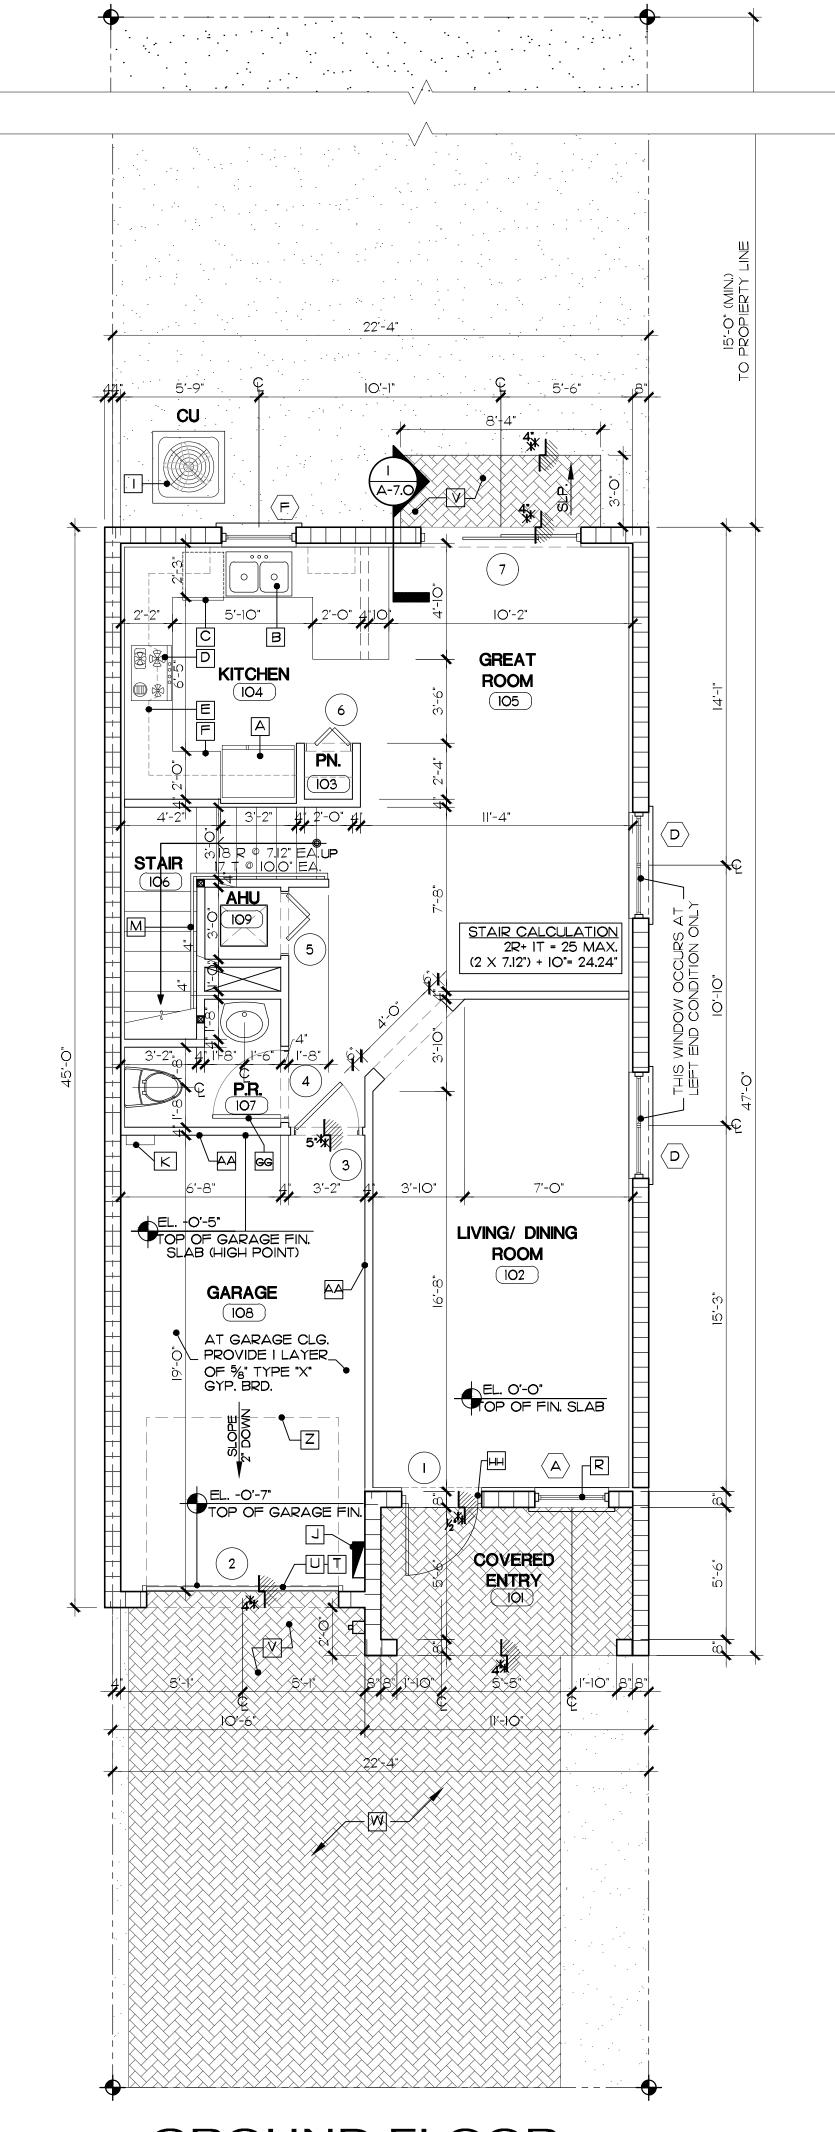

AREA CALCULATIO	N UNIT-E
GROUND FLOOR GROSS AREA	758 S.F.
SECOND FLOOR GROSS AREA	I,044 S.F.
TOTAL GROSS LIVING SPACE	1,802 S.F.
GARAGE GROSS AREA	216 S.F.
COV. ENTRY	70 S.F.
PATIO AREA	25 S.F.
TOTAL	2,113 S.F.
	((7.65

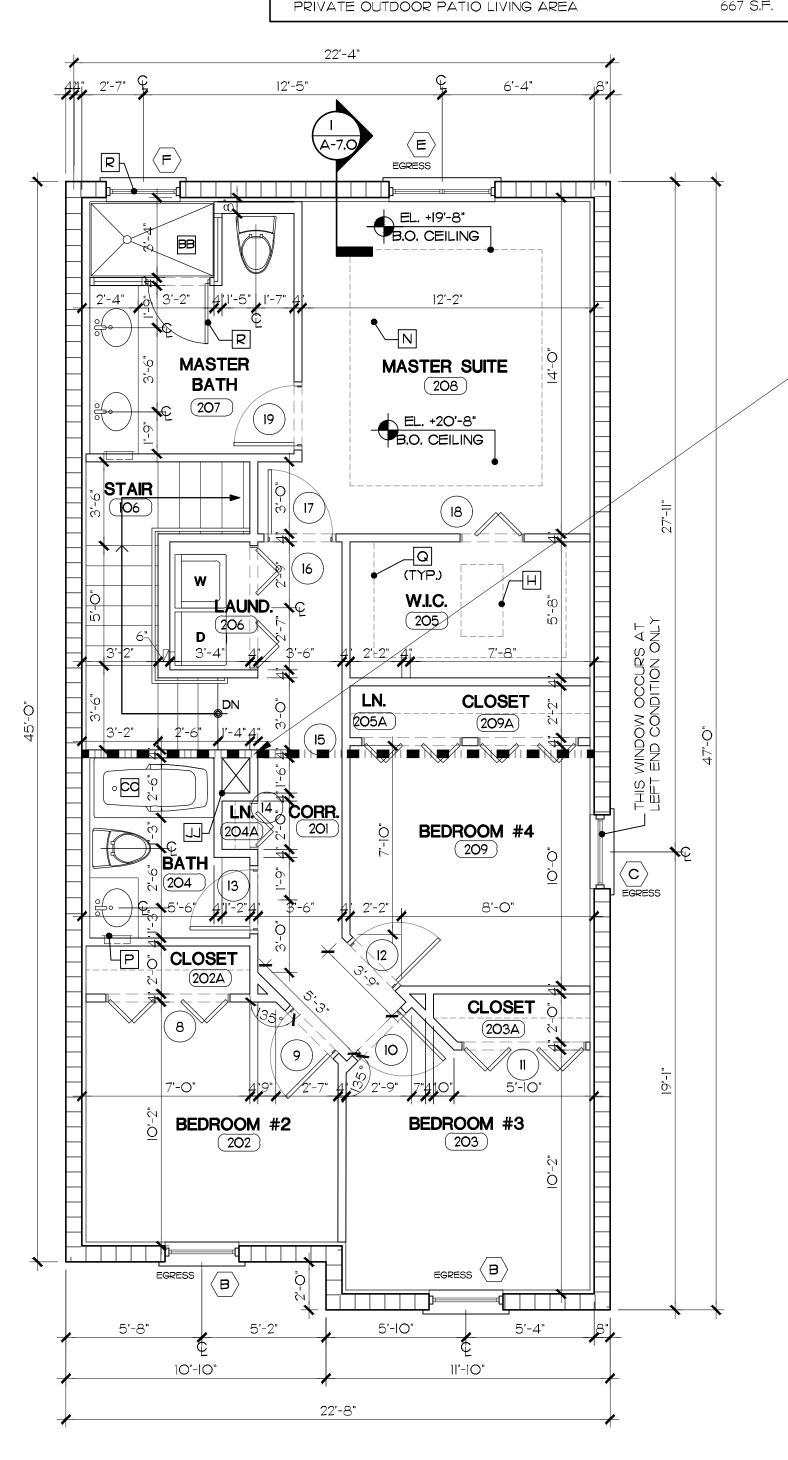

SECOND FLOOR

SCALE: 1/4" = 1'-0"

**GROUND FLOOR** SCALE: 1/4" = 1'-0"

WALL TYPE LEGEND

3-5/8" OR 6" AT 24" O.C. METAL STUD PARTITION WITH I/2" GYPSUM WALLBOARD EACH SIDE. 3-5/8" AT 16" O.C. METAL STUD PARTITION WITH 5/8" (TYPE X) GYPSUM WALLBOARD EACH SIDE. CONCRETE MASONRY WALL. (SEE STRUCTURAL

DRAWINGS FOR DETAILS ). CONCRETE MASONRY UNIT FILLED CELL. ( SEE STRUCTURAL DRAWINGS ).

CONCRETE COLUMN, SEE STRUCT. DRAWINGS FOR

# FLOOR PLAN LEGEND

A REFRIGERATOR SPACE

B SINK

C DISHWASHER

D RANGE WITH MICROWAVE ABOVE.

E LINE OF CABINETS ABOVE

F 36" HIGH COUNTER

G 42" HIGH COUNTER

H 22"X36" ATTIC ACCESS PANEL.

A/C CONDENSING UNIT PAD (VERIFY SIZE AND LOCATION)

J ELECTRICAL PANEL SURFACE MOUNTED

K TANKLESS WATER HEATER HANDRAIL/ GUARDRAIL 36" MIN, 38" MAX REFER TO

DETAIL NO. 2 SHEET A-6.3.2 M 34" MIN. TO 38" MAX. HIGH WALL MOUNTED WOOD HANDRAIL

MI 42" HIGH MIN. WOOD GUARDRAIL

N COFFER CEILING +9'-0" TO +10'-0"

O ELECT, METER P MEDICINE CABINET

LINE DENOTES DRAFTSTOP AT FLOOR

TO I,OOO SQ.FT. MAX. AS PER F.B.C.

TYPE X GYPSUM BOARD ATTACHED

R4009.7.3.I.I DRAFTSTOP SHALL BE

INSTALLED PARALLEL TO FLOOR FRAMING MEMBERS. AND SHALL BE %"

TO TOP ANDBOTTOM CORDS OF

TRUSSES

/CEILING ASSEMBLIES TO LIMIT AREAS

Q SHELVING BY BUILDER

R CAT. II SAFETY GLASS

S KNEE WALL AT 42" A.F.F.

T PROVIDE "DANGER" SIGN (SEE FLOOR PLAN NOTES)

U GARAGE VENTILATION AT GARAGE DOORS, SEE DOOR SCHEDULE)

V INTERLOCKING CONCRETE PAVERS ON 1-1/2" SAND BASE OVER WELL COMPACTED FILL

W DRIVEWAY (SEE SITE PLAN FOR CONTINUATION)

X WALKWAY (PAVERS BY BUILDER)

42" HIGH, ALUMINUM RAILINGS TO REJECT 4" OBJECTS, WITH MAX. CLEARANCE BETWEEN BOTTOM RAIL AND ADJACENT FLOOR SURFACE OF 2" SUBMIT SHOP DWGS, FOR APPROVAL.

Z LINE OF OVERHEAD DOOR

AA R-II BATT. INSUL. IN WALLS BETWEEN AIR CONDITIONED & NON-CONDITIONED SPACES. R-19 INSUL. IN FLOOR TRUSSES ABOVE GARAGE CEILING.

BB SHOWER / TUB STALL SHALL HAVE A SMOOTH, IMPERVIOUS FINISH UP TO 72" PER F.B.C. R307.2

CC COORDINATE DIMENSION WITH TUB MANUFACTURER.

DD IF REQUIRED FLOOD VENTS: GARAGE SIZE = SQ. FT. PROVIDED (2)-8"X16" FLOOD VENTS= 256 SQ. IN. FLOOD VENTS SHALL NOT BE LOCATED MORE

THAN 7" A.F.F. EE REINFORCED CMU WALL, REFER TO STRUCTURAL DWGS

FF DRYER EXHAUST THROUGH ROOF

GG BATHROOM DOOR SHALL BE 29" CLEAR AS PER FBC. R320.I.I HH DESIGNATED MEANS OF ESCAPE WHEN HURRICANE

PROTECTION DEVICES ARE IN PLACE.

II ARCHED TRANSOM TOP OF OPENING +8'-0"

JJ CHASE KK 1/2" RECESS AT FRONT DOOR WITH FULL WIDTH OF 10"

#### FLOOR PLAN NOTES: REFER TO STRUCTURAL DWGS. FOR STRUCTURAL DETAILS

. FOR WINDOW AND DOOR ELEVATIONS / SEE DETAILS THIS SHEET.

GARAGE NOTES:

A) \* PROVIDE PERMANENT SIGN ( WITH LETTERS NOT LESS THAN 1/2", READING: "DANGER DO NOT OPERATE ENGINES W/ DOOR CLOSED CARBON, MONOXIDE EMISSION IS

B) \* PROVIDE SCREENED OPENINGS THROUGH GARAGE DOOR W/ THE CLEAR EFFECTIVE AREA NOT LESS THAN 60 SQ. IN. PER MOTOR VEHICLE (LOCATED WITHIN 7 IN, OF THE HIGHEST PART OF THE FLOOR).

. EGRESS WINDOWS SHALL BE OPERABLE FROM THE INSIDE WITHOUT THE USE OF TOOLS. EGRESS WINDOWS SHALL HAVE A MINIMAL NET OPENING OF 24" HIGH, 20" WIDE, AND MIN. NET AREA OF 5.7 S.F. FOR 2ND FLOOR WINDOWS AND 5.0 S.F. FOR IST FLOOR WINDOWS. THE BOTTOM OF THE OPENING SHALL NOT BE MORE THAN 44" ABOVE THE FLOOR, LATCH AT 54" A.F.F. MAX. IN HVHZ AREAS WHERE THERE IS MORE THAN A 4'-0" DROP, THE SILL SHALL BE NO LESS THAN 42" A.F.F. OR PROVIDE AN APPROVED SAFEGUARD.

. EVERY CLOSET DOOR LATCH SHALL BE SUCH THAT CHILDREN CAN OPEN THE DOOR FROM INSIDE THE CLOSET AS PER NFPA IOI.

. EVERY BATHROOM DOOR SHALL BE DESIGNED TO ALLOW OPENING FROM THE OUTSIDE DURING AN EMERGENCY WHEN LOCKED AS PER NFPA 101.


A PERMANENT SIGN WHICH IDENTIFIES THE TERMITE TREATMENT PROVIDER AND NEED FOR REINSPECTION AND TREATMENT CONTRACT RENEWAL SHALL BE PROVIDED. THE SIGN SHALL BE POSTED NEAR THE WATER HEATER OR

ELECTRICAL PANEL. 8. ALL BATHROOM FLOORS AND BASES SHALL BE OF APPROVED IMPERVIOUS MATERIALS.

9. ALL BATHTUB AND SHOWER FLOORS AND WALLS ABOVE BATHTUBS WITH INSTALLED SHOWER HEADS AND IN SHOWER COMPARTMENTS SHALL BE FINISHED WITH A NONABSORBANT SURFACE TO A HEIGHT OF NOT LESS THAN 6 FEET.

). IN HVHZ AREAS PROVIDE HURRICANE SHUTTERS AS PER F.B.C. SECTION 2413 UNLESS THE EXTERIOR WALL COMPONENTS OF THE ENCLOSED BUILDING HAS SPECIFIC PRODUCT APPROVAL TO PRESERVE THE ENCLOSED BUILDING ENVELOPE AGAINST IMPACT LOADS AS SET FORTH IN CHAPTER 16.

HURRICANE SHUTTERS FOR WINDOWS ABOVE THE FIRST FLOOR SHALL BE CLOSABLE / INSTALLABLE FROM THE INSIDE OF BUILDING WITHOUT THE USE OF A LADDER AS PER F.B.C. 2413.6.1 2. ALL ENTRY DOORS SHALL BE DESIGNATED EGRESS DOOR AS PER FBC R3II

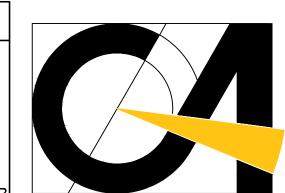

CORWILARCHITECTS 4210 LAGUNA ST. CORAL GABLES FL. 33146 LIC.NO. AA-C002151 T.305.448.7383

PROJECT:

CELEBRATION POINTE SOUTH **BROWARD COUNTY FLORIDA** 

OWNER:

**LENNAR HOMES** 

8

РΗ	ASI	3	

PERMIT SET

REVISIONS

THIS DRAWINGS IS THE PROPERTY OF CORWIL ARCHITECTS INC UNLESS OTHERWISE PROVIDED FOR BY CONTRACT THE CONTENTS OF THIS DRAWINGS ARE CONFIDENTIAL

AND SHALL NOT BE TRANSMITTED TO ANY OTHER PARTY EXCEPT AS AGREED TO BY THE ARCHITECT/ ENGINEERS.

DATE: 04-06-17

JOB NO. 2014-46

DRAWN BY AMC

PRINTED DATE SHEET NUMBER:

A-6.3.0

04-06-17

# PASCUAL ,PEREZ,KILIDDJIAN & ASSOC.

AT THE BEACON CENTER 1300 NW 84th AVENUE DORAL, FLORIDA 33126 TELEPHO(BUE5) 592-1363 FACSIMI(£05) 592-6865

http://www.ppkarch.com

COPYRIGHT© PASCUAL, PEREZ, KILIDDJIAN & ASSOCIATES, ARCHITECTS - PLANNERS The architectural design and detail drawings of this building and/or overall project are the legal property of, and all rights are reserved by the Architect. Their use for reproduction, construction or distribution is prohibited unless authorized in writing by the Architect.

# INDEX OF DRAWINGS:

ARCHITECTURAL

MECHANICAL

1. C-O COVER SHEET

2. A·1 FLOOR PLAN

3. A-2 ROOF FRAMING PLAN & ELEVATIONS

4. A-3

5. A-4

6. A-4 7. D-1

8. D-2 9. D-3

ELECTRICAL PLUMBING

CMBeng LLC

CMBeng
Consulting Design

14850 SW 26 St. #103 Miami, Florida 33185 O. 786.375.5348 • F: 305.921.9937 CMB@CMBeng.com L.C. No. 29433 OWNER

LENNAR HOMES, LLC 730 NW 107TH AVE. SUITE 3000 MIAMI, FL 33172 PHONE: 305-591-1951 CONTACT: PEDRO PORTELA PEDRO.PORTELA@LENNAR.COM PASCUAL PEREZ ... KILIDDJIAN & ASSOCIATES

ARCHITECTS - PLANNERS LICENSE # AA 26001357

EDGARDO PEREZ, AIA LICENSE No.: AR 0015394 MARIO P. PASCUAL, AIA LICENSE No.: AR 0008254 PETER KILIDDJIAN, RA LICENSE No.: AR 0093067

CELEBRATION POINTE SOUTH

LENNAR HOMES
BROWARD COUNTY, FLORIDA

POOL BUILDING CONST. TYPE V-B FLORIDA BLDG. CODE 2014 NFPA 101 - 2012 EDITION & FFPC FIFTH EDITION

DOOR SCHEDULE:									
			DOOR	TYPE		FRAME		ME	REMARKS
No.	W	Н	Т	MAT	TYPE	GLASS	MAT.	DET.	
1	3'-Ø"	8'-0"	1 3/4"	MTL	LOUVERED		MTL		MTL. THRESHOLD, WEATHER STRIP, 20"X20" MIN. LOUVERED PANEL AT BOTTOM
2	2'-10"	6'-8"	1 3/4"	MTL	LOUVERED		MTL		20'X20' MIN. LOUVERED PANEL AT BOTTOM

#### **GENERAL NOTES:**

- 1. PRIOR TO START OF CONSTRUCTION, THE CONTRACTOR AND ALL THE SUBCONTRACTORS SHALL VERIFY ALL GRADES, LINES, LEVELS, DIMENSIONS AND COORDINATE EXISTING CONDITIONS AT THE JOB SITE WITH THE PLANS AND SPECIFICATIONS. THEY SHALL REPORT ANY INCONSISTENCIES OR ERRORS IN THE ABOVE TO THE ARCHITECT/ ENGINEER BEFORE COMMENCING WORK FROM ESTABLISHED REFERENCE POINTS AND BE RESPONSIBLE FOR ALL LINES, ELEVATIONS AND MEASUREMENTS IN CONNECTION WITH THEIR WORK.
- 2. IF ANY ERRORS OR OMISSIONS APPEAR IN THE DRAWINGS, GENERAL NOTES OR OTHER DOCUMENTS, THE CONTRACTOR SHALL NOTIFY THE ARCHITECT/ENGINEER IN WRITING OF SUCH OMISSION OR ERROR PRIOR TO PROCEEDING WITH ANY WORK WHICH APPEARS IN QUESTION. IN THE EVENT OF THE CONTRACTOR'S FAILING TO GIVE SUCH AN ADVANCED NOTICE, HE SHALL BE RESPONSIBLE FOR THE RESULTS OF ANY SUCH ERRORS OR OMISSIONS AND THE COST OF RECTIFYING THE SAME.
- 3. ALL DIMENSIONS SHALL BE CONSIDER "NOMINAL" UNLESS OTHERWISE NOTED. DIMENSIONS ON LARGE SCALE DRAWINGS OR DTLS. WILL PREVAIL OVER SMALLER SCALED DRAWINGS.
- 4. DO NOT SCALE DWGS. USE FIGURED DIMENSIONS ONLY. VERIFY ALL DIMENSIONS \$ CONDITIONS, IN THE EVENT OF CONFLICT, NOTIFY THE ARCHITECT BEFORE PROCEEDING.
- 5. SHOWER/BATHTUB COMPARTMENTS SHALL HAVE FLOORS AND WALLS CONSTRUCTED OF SMOOTH, CORROSION RESISTANT AND NONABSORBENT WATER-RESISTANT MATERIALS (GREEN BOARD NOT ACCEPTABLE) TO HEIGHT OF NOT LESS THAN 12 INCHES ABOVE THE COMPARTMENT FLOOR AT THE DRAIN PER FBC 2010
- 6. IN AN OUTSIDE WINDOW OR DOOR OPERABLE FROM THE INSIDE, THE MODE OF OPERATION SHALL NOT REQUIRE THE USE OF A KEY, TOOL, SPECIAL KNOWLEDGE OR EFFORT. SUCH CLEAR OPENING SHALL BE NOT LESS THAN 20" IN WIDTH, AND 24" IN HEIGHT, 5.7 SQ. FT. IN AREA THE BOTTOM OF THE OPENING SHALL NOT BE MORE THAN 44" ABOVE THE FINISHED FLOOR AND NO PART OF THE OPERATING MECHANISM SHALL BE PLACED HIGHER THAN 54" ABOVE FINISHED FLOOR. AS PER FBC 2010
- 1. REFER TO FOUNDATION PLAN FOR CONCRETE FILLED BLOCK CELL LOCATION, SIZE & REINF.
- 8. ALL FIXED GLASS PANELS SHALL BE 36" SAFETY GLASS CAT. II
- TERMITE PROTECTION SHALL BE PROVIDED BY REGISTERED TERMITICIDES AS PER FBC. ALL BUILDINGS SHALL HAVE PRE-CONSTRUCTION TREATMENT PROTECTION AGAINST SUBTERRANEAN TERMITES AS FBC-2010 A CERTIFICATE OF COMPLIANCE SHALL BE ISSUED TO THE BUILDING DEPARTMENT BY THE LICENSED PEST CONTROL COMPANY THAT CONTAINS THE FOLLOWING STATEMENT: "THE BUILDING HAS RECEIVED A COMPLETE TREATMENT FOR THE PREVENTION OF SUBTERRANEAN TERMITES. TREATMENT IS IN ACCORDANCE WITH THE RULES AND LAWS ESTABLISHED BY THE FLORIDA DEPARTMENT OF AGRICULTURE AND CONSUMER SERVICES." PROVIDE PERMANENT TERMITE TREATMENT SIGN POSTED NEAR WATER HEATER OR ELECTRICAL PANEL AS PER FBC 2010.
- 10. FLAME SPREAD AND SMOKE DENSITY: WALL AND CEILING FINISHES SHALL HAVE A FLAME-SPREAD CLASSIFICATION OF NOT GREATER THAN 200 AS PER FBC2010
- WALL AND CEILING FINISHES SHALL HAVE A SMOKE-DEVELOPED INDEX OF NOT GREATER THAN 450. AS PER FBC2010 INSULATION MATERIALS, INCLUDING FACINGS, SUCH AS YAPOR RETARDERS OR YAPOR
- PERMEABLE MEMBRANES INSTALLED WITHIN FLOOR-CEILING ASSEMBLIES, ROOF-CEILING ASSEMBLIES, WALL ASSEMBLIES, CRAWL SPACES AND ATTICS SHASLL HAVE A FLAME SPREAD INDEX NOT TO EXCEED 25 WITH AN ACCOMPANYING SMOKE-DEVELOPED INDEX NOT TO EXCEED 450 AS PER FBC 2010
- II. ALL EGRESS DOORS SHALL BE READILY OPENABLE FROM THE SIDE FROM WHICH EGRESS IS TO BE MADE WITHOUT THE USE OF A KEY OR SPECIAL KNOWLEDGE OR EFFORT. AS PER FBC 2010
- 12. GLAZING INSTALLED IN HAZARDOUS LOCATIONS SHALL BE PROVIDED WITH A MANUFACTURE'S OR INSTALLER'S LABEL, DESIGNATING TYPE AND THICKNESS OF GLASS AND THE SAFETY GLAZING STANDARD WITH WHICH IT COMPLIES, WHICH IS VISIBLE IN THE FINAL INSTALLATION AS PER FBC OPERATIVE WINDOW AND DOOR ASSEMBLIES SHALL BE TESTED IN ACCORDANCE WITH THE REQUIREMENTS PER FBC 2010
- 13. IN BUILDINGS WITH COMBUSTIBLE CEILING OR ROOF CONSTRUCTION, AN ATTIC ACCESS OPENING SHALL BE PROVIDED WITH THE ROUGH-FRAMED OPENING NOT LESS THAN 22" BY 30" AS PER FBC 2010. A 30" MIN. UNOBSTRUCTED HEADROOM IN THE ATTIC SPACE SHALL BE PROVIDED.

MINIMUM NUMBER OF REQUIRED PLUMBING FIXTURES (FBC TABLE 454.1.6.1 & FBC-P.TABLE 403.6)								
SIZE OF POOL: 845 S.F. SIZE OF DECK: 1,863 S.F. < 3X(845 S.F.) [TABLE 454.1.6.1 & 403.6 ARE APPLICABLE]								
	URIN	NAL	WATER	CLOSET	LAVA	TORY	OTHER	
	MALE	FEMALE	MALE	FEMALE	MALE	FEMALE		
REQUIRED	1	N/A	1	1	1	1	1-MOP SINK	
PROVIDED	1	-	1	1	2	3	2-DRINKING FOUNTAINS	


## BATHROOM REQUIREMENT NOTES:

I. TOILET, BATHING AND SHOWER ROOM FLOOR FINISH MATERIALS SHALL HAVE A SMOOTH, HARD, NONABSORBENT SURFACE. THE INTERSECTIONS OF SUCH FLOORS WITH WALLS SHALL HAVE A SMOOTH, HARD, NONABSORBENT VERTICAL BASE

2. WALLS AND PARTITIONS WITHIN 2 FEET OF SERVICE SINK, URINALS AND WATER CLOSETS SHALL HAVE A SMOOTH, HARD, NONABSORBENT SURFACE, TO A HEIGHT OF NOT LESS THAN 4 FEET ABOVE THE FLOOR AND EXCEPT FOR STRUCTURAL ELEMENTS, THE MATERIALS USED IN SUCH WALLS SHALL BE OF A TYPE THAT IS NOT ADVERSELY AFFECTED BY MOISTURE

THAT EXTENDS UPWARD ONTO THE WALLS NOT LESS THAN 4 INCHES.

3. ACCESSORIES SUCH AS GRAB BARS, TOWEL BARS, PAPER DISPENSERS, HAND SOAP, PROVIDED ON OR WITHIN WALLS, SHALL BE INSTALLED AND SEAL TO PROTECT STRUCTURAL ELEMENTS FROM MOISTURE.

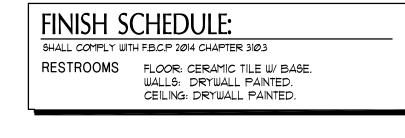

NOTE:
- ALL FLOOR AND GROUND SURFACE SHALL BE STABLE, FIRM AND SLIP RESISTANT AS PER FBC-A 302 CHANGES IN LEVEL SHALL COMPLY WITH FBC-A 303. VERTICAL CHANGE IN LEVEL OF 1/4" HIGH MAX.

#### FLOOR PLAN LEGEND:

A ELECTRICAL PANEL

B VANITY MIRROR

C HI-LO DRINKING WATER FOUNTAIN

D MOP SINK

E KNOX BOX HINGED 3200 SERIES

F FUTURES VENDING MACHINES

G 22" × 34" ATTIC ACCESS (MIN. 30" CLR HEADROOM)

H (2) 3'-0" X 7'-0" GATE WITH SELF CLOSING & LATCHING GATE AT 54" MAX. A.F.F. OPERATED BY COMBINATION LOCK. SHALL COMPLY W/ 404.2.1 EXCEPTION No2 FO F.B.C.A. GATE HARDWARE FOR EGRESS FROM INSIDE MUST BE 48" MAX. A.F.F. AS PER F.B.C. 2014

I ELECTRICAL METER

J 42" HEIGHT WIN WALL K COUNTER 34" MAX. HEIGHT AS PER 606.3 OF F.B.C.A.

L URINAL SHALL HAVE RIM AT 17" A.F.F. AS PER FIG. 605.2 OF F.B.C.A. M CLEAR FLOOR SPACE SHALL COMPLY WITH 305 \$ 605.3 OF F.B.C.A.

FOR URINALS AND 6022 FOR LAYATORIES


N INSTAN TANKLESS WATER HEATER REFER TO ELECTRICAL AND PLUMBING PLANS FOR INFORMATION AND DETAILS.

O MAILBOXES


#### AREA CALCULATIONS:

RESTROOM AREA	369 SQUARE FEET
STORAGE AREA	37 SQUARE FEET
ELECTRICAL ROOM AREA	38 SQUARE FEET
MAILBOXES AREA	166 SQUARE FEET
COVERED BREEZEWAY AREA	333 SQUARE FEET
COVERED PATIO AREA	308 SQUARE FEET
TOTAL	1, 251 SQUARE FEET

### WALL LEGEND:

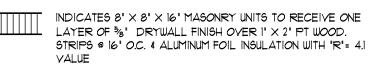



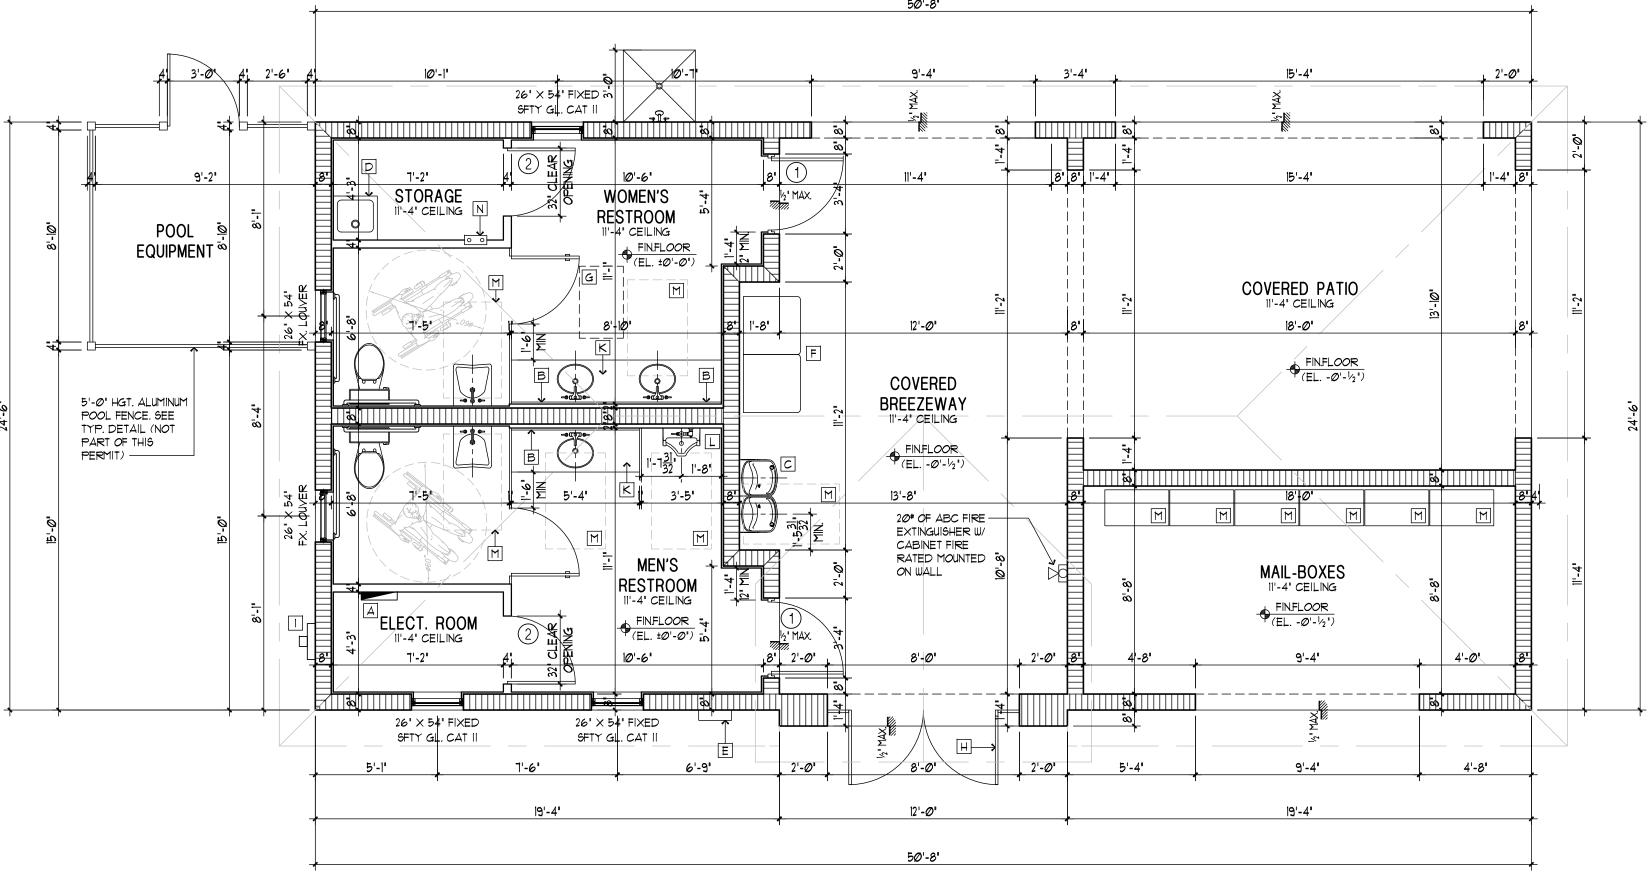

FLOOR PLAN

LICENSE # AA 26001357 EDGARDO PEREZ, AIA LICENSE No.: AR 0015394 MARIO P. PASCUAL, AIA LICENSE No.: AR 0008254 PETER KILIDDJIAN, RA LICENSE No. : AR 0093067

**ARCHITECTS - PLANNERS** 

AT THE BEACON CENTER 1300 NW 84th AVENUE DORAL, FLORIDA 33126 TELEPHONE: (305) 592-1363 FACSIMILE: (305) 592-6865 http://www.ppkarch.com The architectural design and detail drawings of this building and/or overall project are the legal property of, and all rights are reserved by the Architect. Their use for reproduction, construction or distribution is prohibited unless authorized in writing by the Architect.

**REVISIONS:** 

OWNER: LENNAR HOMES, LLC 730 NW 107TH AVE. SUITE 3000 MIAMI, FL 33172 PHONE: 305-591-1951 CONTACT: PEDRO PORTELA PEDRO.PORTELA@LENNAR.COM

**B ∠** LEND 

SEAL:

POOL BUILDING

FLOOR PLAN DATE: 04.06.17. SCALE: AS SHOWN DRAWN: CHECK BY:

17-17

SHEET NO.:

JOB NO.:

# ROOF FRAMING PLAN

SCALE: 1/4" = 1°-0"

#### **ROOF NOTES:**

1.- TRUSS MANUFACTURER SHALL SUBMIT DRAWINGS FOR ARCHITECTS REVIEW PRIOR TO FABRICATION

2.- TRUSS MANUFACTURER SHALL VERIFY ALL KNEE HEIGHTS 3.- REFER TO TRUSS MANUFACTURER ENGINEERING DRAWINGS FOR ALL ROOF TRUSSES REQUIRED TEMPORARY AND PERMANENT BRACING, GABLE END BRACING, DETAILS AND REQUIRED GRAVITY F.P.A.C.O.W. BEAM DEPTH OVER DOOR/WINDOW OPENINGS MAY VARY AS PER MFR. DOOR/WINDOW HGT. (FRENCH OR SLIDING DOORS AND WINDOWS UP TO 3" DEEPER)

5.- PROVIDE 1/2" CDX. PLYWD. FELT MTL. LATH AND STUCCO FINISH AT ALL COVERED TERRACE AND ENTRY CEILING / SOFFITS (TYP). 6 .- ROOF VENTS TO ATTIC SPACE MUST BE COVERED W/ SCREENING, WITH OPENINGS A MINIMUM OF 1/4" AND MAXIMUM OF 1/4" (TYP) 1.- RAINWATER DOWSPOUTS SHALL DISCHARGE A MIN. OF 12" AWAY

FROM THE WALL. FBC 2014 SECTION R318.5

### ROOF COVERING SPECIFICATION

CEMENT FLAT TILE ROOF ON 1-90\* MINERAL SURFACE HOT MOPPED TO 1-30# FELT TIN-TAGGED TO 19/32" PLYWOOD SHEATHING SPACING OF TIN-TAG FASTENERS ALONG THE LAP OF SHEETS, AND BOTH WAYS IN THE FIELD BETWEEN LAPS, SHALL BE 6" O.C. IN DIRECTION OF ROLL, 12" O.C. ACROSS WIDTH OF ROLL, AS PER F.B.C. 2014 THE 1-30\* FELT IS ANCHORED TO THE PLYWOOD SHEATHING WITH SEMCO GALVANIZED, DIAMOND POINTS, 1-1/4" X .120" DIAMETER. INSTALLATION SHALL BE PER PRODUCT CONTROL APPROVAL AND MANUFACTURERS SPECS. WOOD SHEATHING ANCHORAGE SHALL BE NAILED IN ACCORDANCE WITH F.B.C. 2014 19/32" CDX PLYWOOD SHEATHING W/ 8d RING SHANK NAILS @ 6" O.C. @ PANEL EDGES AND INTERMEDIATE SUPPORTS AND IØD COMMON NAILS

@ 6" O.C. THROUGHOUT AND 4" O.C. @ GABLE END TRUSSES AND

DIAPHRAGM BOUND. F.B.C. 2014 SECTION 2322.2.4 AND 5


HEIGHT DIMENSIONS: VENTILATION: REQUIRED VENTILATION: RIDGE HEIGHT = +17'-0" <u>1485 S.F.</u> = 9.90 S.F. MEAN HEIGHT = +14'-2" EAVE HEIGHT = +11'-4" SOFFIT VENTILATION PROVIDED: NOTES:  $\frac{4" \times 24"}{144} = \emptyset.66 \times 34 = 22.44 \text{ S.F.}$ ELEVATIONS ARE REFERRED TO FINISH FLOOR AS Ø'-Ø'

## ROOF VENTILATION CALC.

TOP OF BOND BM AT ENTRY TOWER BOND BM CONC. SLAB 26" X 54" FROSTED FIXED GL. FROSTED FIXED GL PREVENT REACH THROUGH SIZE TO BE DETERMINED

# FRONT ELEVATION

SCALE: 1/4" = 1°-0"

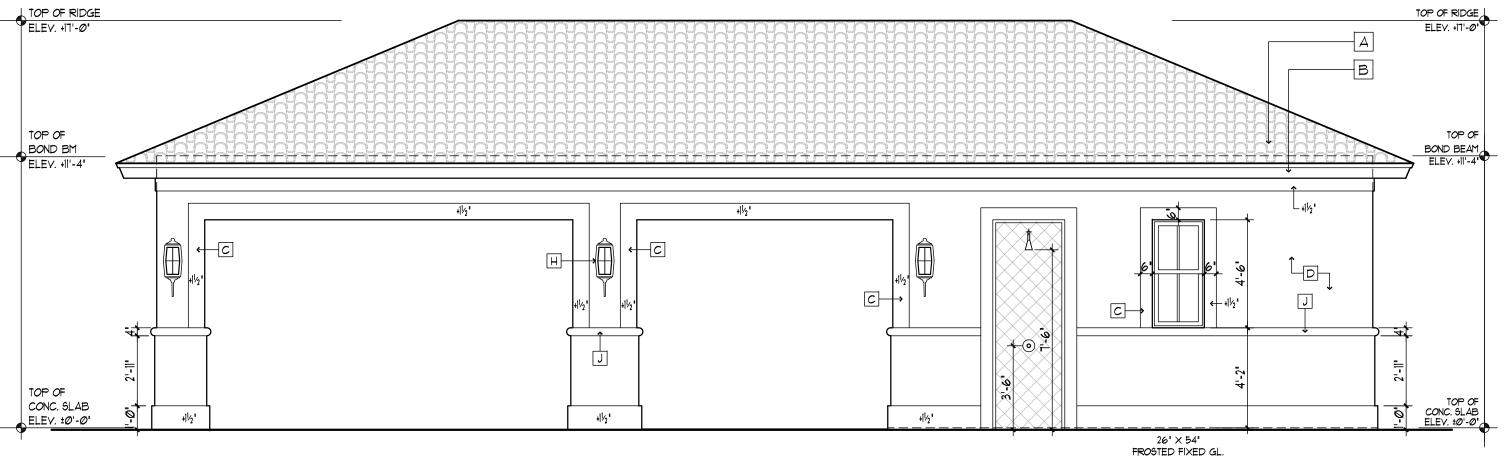

# REAR ELEVATION SCALE: 1/4" = 1°-0"

#### **LEGEND**

A CEMENT TILE ROOF

B 2X8 SMOOTH FINISH WOOD FASCIA C SMOOTH STUCCO APPLICATION

D STUCCO APPLICATION

E DECORATIVE FOAM BRACKET


F DECORATIVE MOTIF.

G KNOX BOX HINGED 3200 SERIES

H DECORATIVE EPS APPLIQUE


DECORATIVE STONE VENEER

J 4" WIDTH 3" THICK PREFAB. FOAM BAND CEMENTICIOUS MATERIAL TOP COAT FINISH

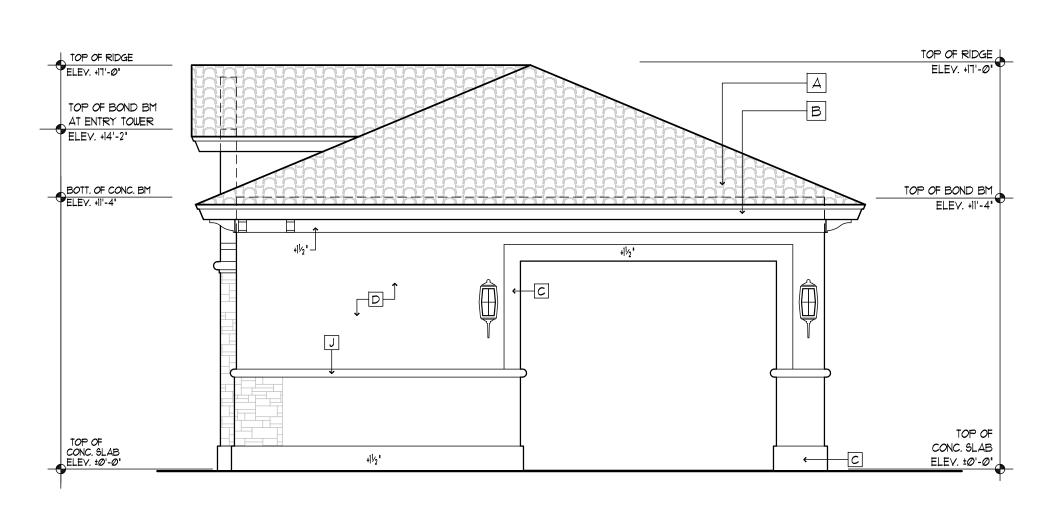

RIGHT ELEVATION

SCALE: 1/4" = 1°-0"

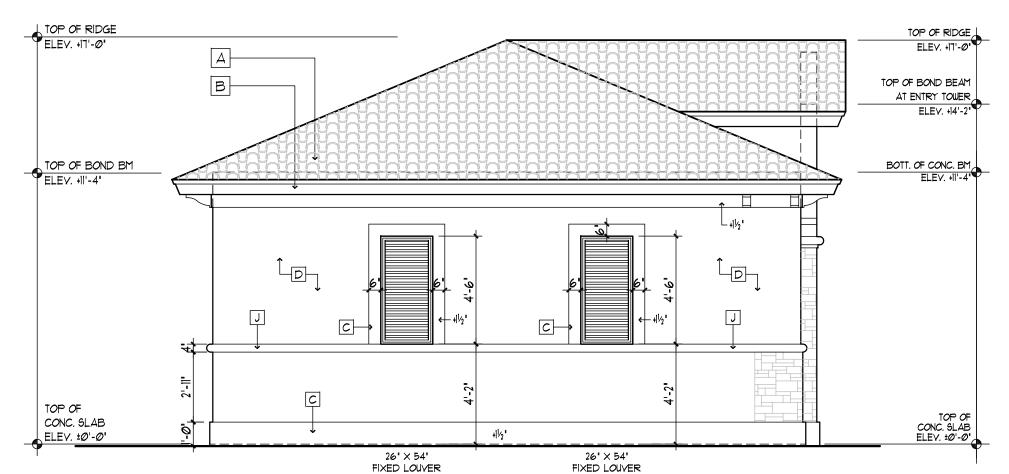

LEFT ELEVATION

SCALE: 1/4" = 1°-0"

ARCHITECTS - PLANNERS LICENSE # AA 26001357

EDGARDO PEREZ, AIA LICENSE No.: AR 0015394 MARIO P. PASCUAL, AIA LICENSE No. : AR 0008254 PETER KILIDDJIAN, RA LICENSE No.: AR 0093067

AT THE BEACON CENTER 1300 NW 84th AVENUE DORAL, FLORIDA 33126 TELEPHONE: (305) 592-1363 FACSIMILE: (305) 592-6865 http://www.ppkarch.com

COPYRIGHT© PASCUAL, PEREZ, KILIDDJIAN 4 ASSOCIATES, ARCHITECTS - PLANNERS The architectural design and detail drawings of this building and/or overall project are the legal property of, and all rights are reserved by the Architect. Their use for reproduction, construction or distribution is prohibited unless authorized in writing by the Architect. **REVISIONS:** 

LENNAR HOMES, LLC 730 NW 107TH AVE. SUITE 3000 MIAMI, FL 33172 PHONE: 305-591-1951 CONTACT: PEDRO PORTELA PEDRO.PORTELA@LENNAR.COM

LENN, WARD 

SEAL:

POOL BUILDING

ROOF PLAN AND ELEVATIONS DATE: 04.06.17. SCALE: AS SHOWN DRAWN: CHECK BY:

17-17

SHEET NO.:

JOB NO.: