Redeeming Lighthouse

7452 ROYAL PALM BLVD MARGATE FL 33063

TERMS OF USE & LICENSE AGREEMENT

Building Codes And Zoning Requirements

At the time of creation, these plans were designed to meet the requirements of a nationally recognized model building code in effect where these plans were produced. Because of the great differences in geography and climate throughout the United States each state, county and municipality has its own building codes, zone requirements, ordinances and building regulations. These plans may need to be modified and additional drawings and details may need to be added to comply with your local conditions, requirements, and a wide range of other matters. All of our plans can be adapted to the local building codes and requirements. It is the responsibility of the purchaser and/or builder of each plan to see that the structure is built in strict compliance with the governing municipal codes (city, county, state and federal). In addition to the building plans that you order, you will also need a site plan that shows where the house is going to be located on the lot. There are some areas of the country that have very strict engineering codes. If you are building in this type of area, it is possible that you will need to hire a local engineer to analyze the house and provide additional drawings and calculations that may be required by your building department. **Notice Duty Of Cooperation**

Our firm assumes no liability for any home constructed from these plans. Only qualified Designers, Architects, Contractors or Structural Engineers should attempt to modify any portion of these plans. It is the sole responsibility of the purchaser to obtain any and all structural analysis, engineering and specifications that are required where the structure is to be built. Written dimensions on these drawings should have precedence over scaled dimensions; the contractor shall verify and be responsible for all dimensions and conditions on the job.

Some cities and states are now requiring that a licensed architect or engineer review and "seal" these plans, or officially approve them prior to construction. In addition, you may need to obtain permits or inspections from your local governments before and in the course of construction. Prior to using these plans, we strongly advise that you consult a licensed architect or engineer, as well as consult with your local building official before applying for any permit or before starting any construction related to these plans. We authorize the use of these plans on the express condition that you strictly comply with all local building codes, zoning requirements and other applicable laws, regulations, ordinances and requirements.

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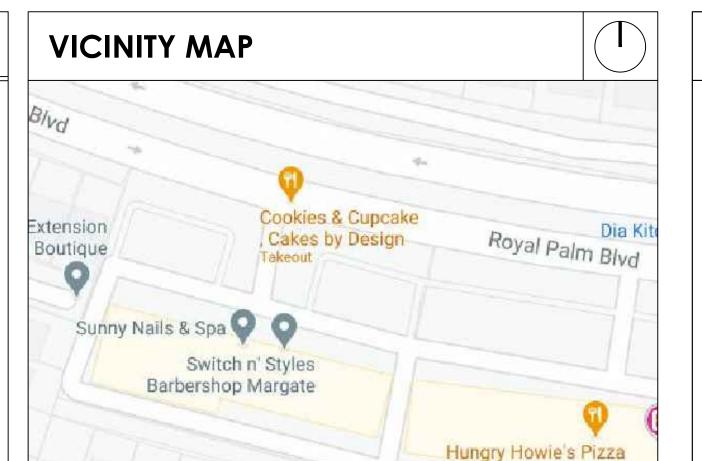
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Dispute Resolution

In the unlikely event that any controversy or claim arising out of or relating to this User Agreement or our services shall be settled by binding arbitration in accordance with the commercial arbitration rules of the American Arbitration Association. Any such controversy or claim shall be arbitrated on an individual basis and shall not be consolidated in any arbitration with any claim or controversy of any other party. The arbitration shall be conducted in Broward County, Florida, and judgment on the arbitration award may be entered into any court having jurisdiction thereof. Either you or we may seek any interim or preliminary relief from a court of competent jurisdiction in Broward County, Florida, necessary to protect the rights or property of you or us

pending the completion of arbitration. Miscellaneous

In the event that any provision of the User Agreement conflicts with the law under which the User Agreement is to be construed or if any provision is held invalid by a court with jurisdiction over the parties to the User Agreement, such provision will be restated to reflect as nearly as possible the original intentions of the parties in accordance with applicable law, and the remainder of this User Agreement will remain in full force and effect. If either party fails to insist upon or enforce strict performance by the other party of any provision of the User Agreement, or to exercise any right under the User Agreement, such a failure will not be construed as a waiver or relinquishment to any extent of such party's right to assert or rely upon any such provision or right in that or any other instance. That is, all provisions and rights will remain in full force and effect.



SCOPE OF WORK

- . CHANGE OF USE FROM GENERAL COMMERCIAL TO ASSEMBLY (A-3).
- 2. PROPOSED WALLS AS PER PLANS.
- 3. ELECTRICAL WORK AS PER PLANS.
- 4. SEE PLANS FOR MORE INFORMATION.

NO MECHANICAL WORK ALL EXISTING TO REMAIN.

PROPERTY INFORMATION

ALL WORK TO BE PERFORMED IN ACCORDANCE WITH THE F.B.C. 2017 EDITION WITH ALL AMENDMENTS, THE N.E.C. THE ZONING ORDINANCES IN THE CITY OF JURISDICTION AND ALL APPLICABLE CODES AND STANDARDS.

LEGAL DESCRIPTION

GATEWAY MILE 63-15 B LOTS 5 THRU 10 & VAC 20 ALLEY LYING BET LOTS 5 & 6 & LOTS 7 THRU 10 BLK M TOGETHER WITH LOTS 5 THRU 10 & VAC 20 ALLEY LYING BET LOTS 5 & 6 & LOTS 7 THRU 10 BLK N MUNICIPALITY

MARGATE

Parcel Control Number:

4841 26 01 2190

SUBDIVISION

LAND USE CODE STORES, 1-STORY

ZONING CODE

LOCATION ADDRESS

GENERAL COMMERCIAL

7452 ROYAL PALM BLVD

CLASSIFICATION OF WORK

ALTERATION LEVEL 2

SATELLITE AERIAL

OCCUPANCY LOADS

OCCUPANCY

A - Assembly

B - Bussiness

BY SEATING =

TOTAL

OCCUPANCY LOAD CALCULATIONS

GREAT ROOM TOTAL NET AREA: ASSEMBLY

STORAGE TOTAL GROSS AREA: **MERCANTILE**

BY AREA 1,327 S.F. @7 SF/APP =

AREA 287 S.F. @300 SF/APP =

TABLE 1004.1.1 - MAX FLOOR AREA ALLOWANCES PER OCCUPANT

AREA PER OCCUPANT

(SQ.FT. 100 GR)


(CONCENTRATED, CHAIRS ONLY - NOT FIXED SQ.FT. 7 NET)

189

51

50



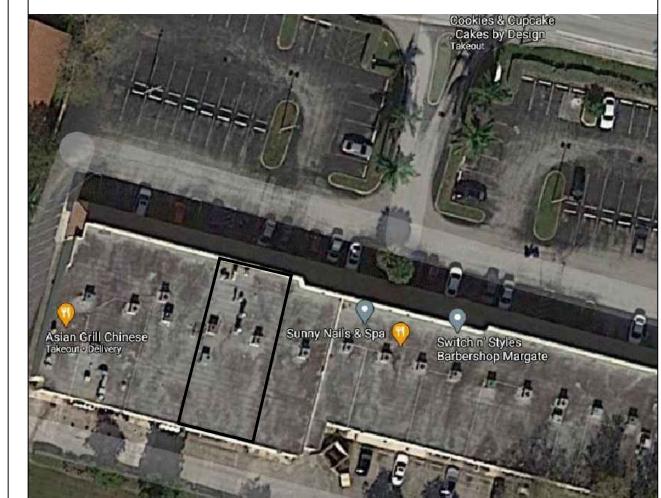

CODE RESEARCH

NEW OCCUPANCY

A3 - Assembly

TYPE OF CONSTRUCTION

TYPE IIIB - NOT PROTECTED (UNSPRINKLERED) EGRESS WIDTH BUILDING 1

1 EXITS REQUIRED, 2 EXITS PROVIDED PER 1005.3.2 213 OCCUPANTS x 0.2" = 42.6" REQUIRED

48" PROVIDED

PLUMBING FIXTURE CALCULATIONS:

REQUIRED BY FLORIDA BUILDING CODE BASED ON A-3 ASSEMBLY OCCUPANCY UNISEX

WATER CLOSET: 1 PER 150 FOR MALES AND 1 PER 75 FOR FEMALES 2 REQUIRED/ 2 PROVIDED

EXISTING ASSEMBLY AREA IS **NOT** BEING CHANGED IN SQUARE

FIELD ZONE

3' EDGE ZONE

3' x 3' CORNERS

POS +42.9 P.S.F.

NEG -57.3 P.S.F.

WORST CASE ALL OPENINGS

LAVATORIES: 1 PER 200 2 REQUIRED/ 2 PROVIDED

EXIST.TOTAL AREA

WINDOWS &

DOORS

ROOF

FOOTAGE OF SPACE.

1 DRINKING FOUNTAIN PER TABLE 403.2 FBC - P

AREA CALCULATIONS

DESIGN WIND PRESSURES

PROJECT TEAM

OWNER

BILU ORGANIZATION LLC 2720 W ATLANTIC BLVD POMPANO BEACH FL 33069

ARCHITECT

SANDRA PUERTA, AR 95385

6476 Kirsten Way Lake Worth, FL 33467 Voice | 561.712.8898 Fax | 561.828.2645

Email | sandra@thearchitectgroup.com

BUILDING DEPARTMENT

MARGATE CITY BUILDING DEPARTMENT

901 NW 66TH AVE B MARGATE, FL 33063 VOICE: 954.970.3004

ZONING DEPARTMENT MARGATE CITY ZONING

901 NW 66TH AVE B MARGATE, FL 33063 VOICE: 954.970.3004

SHEET INDEX

1,327 S.F.

-42.8 PSF

-71.9 PSF

-108.2 PSF

CVR A-0	COVER SHEET GENERAL NOTES + SPECIFICATIONS
A-1 A-2 A-3	AS BUILT FLOOR PLAN EGRESS PLAN + NOTES DETAILS FOR CONSTRUCTION
E-1 E-2	ELECTRICAL PLAN + NOTES REFLECTING CEILING LIGHTS PLAN+NOTES
M-1	AS BUILT MECHANICAL PLAN + NOTES

CONTRACTOR TO VERIFY ANY CONDITION AND NOTIFY ALL RESPONSIBLE PARTIES IF THERE ARE ANY DISCREPANCIES. THE ARCHITECT ASSUMES NO RESPONSIBILITY.

ALL WORK TO BE PERFORMED IN ACCORDANCE WITH THE F.B.C. 2017 EDITION WITH ALL AMENDMENTS, THE N.E.C., THE ZONING ORDINANCES IN THE CITY OF JURISDICTION AND ALL APPLICABLE CODES AND STANDARDS. SANDRA PUERTA CHITEC

AND , INC GRO ONSTRUC

Oct. 15, 20.

BLDG. DEPT. PLAN

REVISIONS:

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Cover and Information

MANAGED BY: **FZ** DRAWN BY: AD/FZ REVIEWED BY: SP

SHEET: CVR

THE CONTRACTOR SHALL GUARANTEE IN WRITING. IN A FORM ACCEPTABLE TO THE OWNER, ALL LABOR and materials installed by him for a period of not less than one year after the date of FINAL ACCEPTANCE, SHOULD DEFECTS OCCUR, ALL WORK SHALL BE REPLACED OR PROPERLY REPAIRED AT NO ADDITIONAL COST TO THE OWNER. SUBSTANTIAL COMPLETION SHALL BE ATTAINED WHEN ALL PHASES OF THE WORK ARE COMPLETE AND THE SPACE CAN BE USED FOR WHAT IS INTENDED, EXCLUDING PUNCH LIST ITEMS.

BUILDING IDENTIFICATION

APPROVED NUMBERS OR ADDRESSES SHALL BE PLACED ON ALL NEW AND EXISTING BUILDINGS IN SUCH POSITION AS TO BE PLAINLY VISIBLE AND LEGIBLE FROM THE STREET OR ROAD FRONTING THE PROPERTY. SAID NUMBERS SHALL CONTRAST WITH THEIR BACKGROUND

COLUMNS

ALL WOOD AND/OR STEEL COLUMNS SHALL BE 1 HOUR FIRE RATED TOP OF ISOLATED EXTERIOR AND PERIMETER COLUMN FOOTING PADS SHALL MATCH THE BOTTOM OF MONOLITHIC WALL FOOTING ELEVATIONS (MINIMUM 1'-4" BELOW TOP OF SLAB ELEVATION, OR AS DETAILED ON THE PLANS.

DOORS & WINDOWS

ALL BEDROOMS REQUIRE AN OUTSIDE WINDOW OR DOOR OPERABLE FROM THE INSIDE WITHOUT THE USE OF TOOLS AND PROVIDING A CLEAR OPENING OF NOT LESS THAN 20 INCHES WIDTH, 24 INCHES IN HEIGHT AND 5.7 SQ.FT. IN AREA. THE BOTTOM OF THE OPENING SHALL NOT BE MORE THAN 44" OFF THE FLOOR AND NO PART OF THE OPERATING MECHANISM SHALL BE PLACED HIGHER THAN 54" ABOVE FINISHED FLOOR. SINGLE HUNG WINDOW OPERATING MECHANISMS SHALL BE AT OR NEAR THE SILL WINDOWS MARKED 'EGRESS' MUST BE MANUFACTURED TO CONFORM TO THE BUILDING CODE WITH respect to minimum emergency egress requirements per n.f.p.a. 101 Chapter 22-2. A door MARKED IN PLAN CALLED 'EMERGENCY EGRESS' SHALL BE DESIGNATED AS AN EXTERIOR DOOR NOT TO BE SHUTTERED FOR EMERGENCY EXIT DURING HURRICANE EMERGENCY CONDITIONS. DOOR TO HAVE A MIN. CLEAR OPENING OF 29", AND TO HAVE PASSED REQUIRED IMPACT AND MISSLE TESTS.

WINDOW SAFEGUARD NOTE

WHERE THERE IS A DROP OF MORE THAN 4 FEET ON THE FAR SIDE OF SUCH WINDOWS AND THE SILL IS LESS THAN 36 INCH ABOVE THE NEAR SIDE WALKING SURFACE, SAFEGUARDS SHALL BE PROVIDED TO PREVENT THE FALL OF PERSONS WHEN SUCH WINDOWS ARE OPEN.

ALL LOCKS ON EXTERIOR DOORS SHALL RESIST A FORCE OF 300 # APPLIED IN ANY MOVABLE DIRECTION. ALL EXTERIOR LOCKS SHALL BE SINGLE CYLINDER WITH 1" THROW FOR 1 3/4" SOLID CORE DOOR. ALL SINGLE EXTERIOR SWING DOORS SHALL HAVE A KEY OPERATED LOCK, OPERABLE FROM EXTERIOR WITH A MINIMUM 6000 POSSIBLE KEY CHANGES. KEY ON KNOB LOCKS SHALL HAVE AN AUXILIARY DEAD BOLT WITH HARDENED BOLT OR WITH INSERT. EXTERIOR SWING DOORS SHALL BE SOLID CORE NOT LESS THAN 1 3/4" THICK. FRONT MAIN ENTRANCE DOORS SHALL BE PROVIDED WITH VISION SCOPE OR VISION PANEL. HINGES ON OUT SWINGING EXTERIOR DOORS SHALL HAVE NON-EXPOSED SCREWS AND NON-REMOVABLE PINS. SINGLE SWING EXTERIOR DOORS CONNECTING LIVING AREAS WITH GARAGE AREAS SHALL BE SOLID CORE 1 3/4" THICK AND SHALL BE SECURED WITH A LATCH AND SINGLE BOLT WITH ONE INCH MIN. THROW OR A COMBINATION OF DEAD BOLT AND DEAD LATCH SETS AND AN AUTOMATIC DOOR CLOSER. ALL GLASS IN EXTERIOR DOORS SHALL COMPLY WITH ANSI 279.1 ALL WINDOWS (OPERABLE) SHALL WITHSTAND A FORCE OF 150# IN ANY OPERABLE DIRECTION. SLIDING GLASS DOORS AND WINDOWS SHALL BE INSTALLED AND CONSTRUCTED SO THAT NO PANEL CAN BE LIFTED FROM TRACKS POSITION AND SHALL COMPLY WITH THE A.A.MA.A STANDARDS FOR FORCED ENTRY RESISTANCE A.A.M.A. 1303-3. SLIDING GLASS DOORS SHALL HAVE DEAD BOLT OR PIN SYSTEM NOT REMOVABLE FROM THE OUTSIDE AT THE JAMB AND SILL. INTERIOR DOORS TO HAVE CYLINDRICAL TYPE LOCK SETS WITH PRIVACY LOCK BY INSIDE PUSH BUTTON WHICH AUTOMATICALLY OPENS BY TURN OR CLOSING ACCORDING TO FED. SPEC. #160 AND 1511. OVERHEAD DOORS SHALL BE PROVIDED WITH MULTIPLE POINT LOCKS OR BE LOCKED AT MORE THAN ONE POINT WITH HARDENED BOLTS WITH INSERTS ENGAGING AT LEAST TWO OPPOSITE POINTS A MIN. OF 5/8".

POST PERMANENT SIGN WITH 1/2" LETTERS ON THE INSIDE FACE OF ANY ONE DOOR TO OUTSIDE: "DO NOT OPERATE ENGINES WITH DOORS CLOSED, CARBON MONOXIDE

NON-BEARING INTERIOR PARTITIONS

ALL INTERIOR NON BEARING PARTITIONS SHALL BE 3 5/8" METAL STUDS 26 GA AT 24" C/C MAXIMUM SPACING WITH 1/2" MINIMUM GYPSUM DRYWALL EACH SIDE.

BATHROOMS

BATHROOM FLOORS AND BASE SHALL BE IMPERVIOUS MATERIALS TILE FINISH, SELECTED BY OWNER

MIRRORS / GLAZING

MIRRORS SHALL BE ANCHORED TO STUDS WHEN IN EXCESS OF 9 S.F. TEMP GLAZING SHALL BE PROVIDED IN TUB & SHOWER WINDOWS & MIRRORS WHERE LESS THAN 60" A.F.F. ALL GLASS WITHIN 24" OF ANY DOOR, FIXED GLASS, SLIDING GLASS DOORS OR LOCATED WITHIN 60" OF FLOOR AND ALL GLAZING AT TUB AND SHOWER ENCLOSURES, WHIRLPOOLS, SPAS, SAUNAS AND STEAM ROOMS SHALL BE TEMPERED SAFETY GLASS.

FIREPLACE NOTES:

A. FIREBOX, SHALL BE IN ACCORDANCE WITH ALL LOCAL CODES, RULES & REGULATIONS HAVING

B. CLEAR FIREPLACE OPENING SHALL BE 40x29x16" DEEP. C. PROVIDE 12"x12" FLUE LINING

D. PROVIDE FIREBRICK INNER HEARTH & LINING

E. MASONRY CHIMNEY (SEE ELEVATIONS) TOP OF FLUE TO BE 24" ABOVE. THE HIGHEST POINT 10'-0"

F. PROVIDE 24" DEEP TILED OUTER HEARTH, 12" ABOVE FINISHED FLOOR & MIN. 16" WIDER THAN FIREPLACE OPENING

G. PROVIDE CAST IRON DAMPER. H. FIREPLACE AND MATERIALS TO BE U.L. RATED AND APPROVED.

I. ALL WOOD BEAMS, JOISTS, AND STUDS SHALL BE TRIMMED AWAY FROM FIREPLACES. HEADERS SUPPORTING TRIMMER ARCHES AT FIREPLACES SHALL BE NOT LESS THAN TWENTY INCHES FROM THE FACE OF THE CHIMNEY BREAST. TRIMMERS SHALL BE NOT LESS THE SIX INCHES FROM THE INSIDE FACE

J. WOODWORK SHALL NOT BE PLACED WITHIN SIX INCHES OF A FIREPLACE OPENING. WOODWORK ABV AND PROJECTING MORE THAN ONE AND ONE-HALF INCH FROM A FIREPLACE OPENING SHALL NOT BE PLACED LESS THAN TWELVE INCHES FROM THE TOP OF A FIREPLACE OPENING. K. PROVIDE A U.L. RATED AND APPROVED CHIMNEY CAP W/ INTEGRAL BUILT-IN SPARK ARRESTER AND RAIN CAP AND BASE FLASHING.

STRUCTURAL NOTES

CONCRETE THIS BUILDING DESIGNED PER: 2705.2(a) - ACI-530-2/ ASCE 5-92/ TMS 402-92 2705.2(b) -

ACI-530.1-92/ ASCE 6-92/ TMS 602-92 /ASCE-7 THE FOUNDATION SHOWN HAS BEEN DESIGNED BY RATIONAL ANALYSIS BY THE ENGINEER OF RECORD SOIL BEARING CAPACITY: 2500 PSF, IF INFERIOR SOIL IS ENCOUNTERED OR IF 2500 PSF CANNOT BE OBTAINED BY PROPER FILLING AND COMPACTION, CONTACT ARCHITECT. VERIFICATION OF THE TEST FOR MODIFIED PROCTOR ASTM D 1557 SHALL BE FILED WITH THE GOVERNING BUILDING DEPARTMENT. BACKFILL SHALL CONSIST OF NON-EXPANSIVE, FREE DRAINING, PREDOMINANTLY GRANULAR MATERIAL, FREE OF DEBRIS AND ORGANIC MATERIAL. SLABS 2500 PSI FOUNDATIONS 2500 PSI COLUMNS & BEAMS 3000 PSI CONCRETE SHALL HAVE A MAXIMUM SLUMP OF 5"

MINIMUM CONCRETE COVER FOR POURED IN PLACE CONCRETE SHALL BE AS FOLLOWS: SLAB ON GRADE

FOUNDATIONS / FOOTINGS BOTTOM 3'

SIDES 2" SUSPENDED SLABS: 1'

COLUMNS & BEAMS 1 1/2" TO THE TIES

MAXIMUM AGGREGATE SIZE SHALL BE 3/4". ALL AGGREGATE SHALL CONFORM TO ASTM C-33. HOLLOW CONCRETE MASONRY UNITS SHALL CONFORM TO ASTM C-90-667 SPECIFICATIONS. MORTAR USED TO BOND C.M.U. SHALL CONFORM TO ASTM C-476, TYPE "m" WITH A 28 DAY STRENGTH OF 2500 PSI. LAY ALL MASONRY WITH FULL FACE HEAD JOINTS AND WITH FACE SHELL MORTAR BEDDING. VERTICAL CELLS FOR MASONRY TO BE GROUTED SHALL HAVE VERTICAL ALIGNMENT SUFFICIENT TO MAINTAIN A CLEAR, UNOBSTRUCTED CONTINUOUS CELL. ALL REINFORCING STEEL SHALL BE GRADE 60, MEETING ASTM SPECS A-615. REINFORCING STEEL SHALL BE FREE FROM OIL, LOOSE SCALE, AND RUST. ALL DOWELS, SLEEVES, CONDUITS, INSERTS, BLOCKOUTS, ANCHOR BOLTS AND DRAINS SHALL BE IN PLACE BEFORE CONCRETING. FOR OPENINGS AND SPECIAL FEATURES OMITTED ON THESE PLANS, SEE ARCHITECTURAL AND/OR MECHANICAL DRAWINGS.

MINIMUM CONCRETE PROTECTION FOR REINFORCING BARS LAP REINFORCING STEEL 30 BAR DIAMETERS MINIMUM, WHEN SPLICED AND SHALL BE SEPARATED BY ONE BAR DIAMETER OR WIRED TOGETHER. SLAB SHALL BE A MINIMUM 4" THICK AND SHALL BE REINFORCED WITH 6" X 6" X 1.4/1.4 WELDED WIRE MESH, CENTERED IN CONCRETE DOUBLED 30" AT THE PERIMETER, SCRAPE SLAB AREA CLEAR OF ALL ORGANIC MATERIAL AND FILL WITH CLEAN SAND TO THE ELEVATION OF THE BOTTOM OF THE SLAB. SURFACE MATERIAL CAN BE USED AS SITE FILL.

THE ENTIRE AREA PLUS AN ADDITIONAL THREE FOOT AT PERIMETER, SHALL BE THOROUGHLY COMPACTED BY AT LEAST TEN OVERLAPPING PASSES IN PERPENDICULAR DIRECTIONS OF A VIBRATORY COMPACTOR TO ACHIEVE A MINIMUM OF 95% OF MAXIMUM DENSITY AS DETERMINED IN ACCORDANCE WITH AASHTO-180C OR ASTM-D1557. IF FOOTINGS ARE EXCAVATED AFTER THE BUILDING AREA COMPACTION, THEN ALL FOOTING BEARING LEVELS SHALL ALSO BE COMPACTED TO A MINIMUM OF 95% OF MAXIMUM DENSITY USING A HAND OPERATED VIBRATORY COMPACTOR. EXISTING STRUCTURE SHALL BE CONTINUOUSLY MONITORED DURING SOIL COMPACTION. ANY ADDITIONAL FILL PLACED ON THE BUILDING PAD AREA SHALL BE COMPACTED TO A MINIMUM DENSITY OF 95% OF THE T-180 MODIFIED PROCTOR, IN LIFTS NOT TO EXCEED 10" EACH. THE AREA OF THE BOTTOM OF THE FOOTINGS SHALL BE COMPACTED, PRIOR TO PLACEMENT OF STEEL, WITH A VIBRATORY COMPACTOR TO INSURE UNIFORM DENSITY BENEATH THE FOOTING. DENSITY TESTS SHALL BE TAKEN IN THE FOOTING AREAS.

SOIL SHALL BE TREATED FOR TERMITES FOR A MIN. DISTANCE OF FOUR (4) FEET BEYOND THE PERIMETER OF ALL FOOTINGS AND/OR SLAB EDGES. ALL PLATES, ANGLES AND MISCELLANEOUS METAL ITEMS TO BE EMBEDDED IN CONCRETE SHALL BE

SECURELY AND ACCURATELY FASTENED TO THE CONCRETE FORM WORK BY A MINIMUM OF TWO (2) **FASTENERS PRIOR TO CONCRETE PLACEMENT** BUNDLE ALL STRUCTURAL BEAM TOP BARS IN PAIRS OVER SUPPORT WITH TOP BARS FROM ADJACENT BEAM. ALL TIE BEAM REINFORCING SHALL EXTEND INTO SPAN OF ANY ADJACENT STRUCTURAL BEAM. ALL ADDED LONGITUDINAL STEEL REINFORCING SHALL EXTEND 6" MINIMUM INTO SUPPORT U.O.N.

STRUCTURAL-STEEL

DESIGN, FABRICATION AND ERECTION OF STRUCTURAL STEEL SHALL CONFORM TO THE LATEST AISC SPECIFICATIONS. ALL STEEL SHALL CONFORM TO ASTM 136, SHOP CONNECTIONS SHALL BE WELDED. FIELD CONNECTIONS SHALL BE 325 HIGH STRENGTH BOLTS AT COLUMNS, TRUSS CONNECTIONS AND ALL OTHER CONNECTIONS. HIGH STRENGTH BOLTS SHALL BE INSTALLED USING CALIBRATED TORQUE WRENCHES. TURN OF NUT METHOD WILL NOT BE ACCEPTED. BEAM TO BEAM CONNECTIONS SHALL BE BOLTED WITH STANDARD WASHERS UNDER NUTS. ALL BOLTS SHALL BE 3/4" DIAMETER U.O.N. PROVIDE 9/16" DIA. HOLES, 4'-0" O.C. MAX. FOR ALL WOOD BLOCKING ATTACHED TO STEEL. CUTS, HOLES, COPES, ETC... REQUIRED IN STEEL MEMBERS BY OTHER TRADES SHALL BE SHOWN ON STEEL SHOP DRAWINGS AND MADE IN THE SHOP. BURNING OF HOLES OR CUTS IN STEEL MEMBERS WILL NOT BE PERMITTED UNLESS SPECIFICALLY APPROVED BY THE STRUCTURAL ENGINEER. ALL LEVELING AND BEARING RATES, ANCHOR BOLTS (EXCEPT FOR WOOD), AND LOOSE LINTELS SHALL BE FURNISHED BY STEEL CONTRACTOR. ALL BEAMS SHALL BE FABRICATED WITH NATURAL CAMBER UP. STEEL CONTRACTOR SHALL CHECK ANCHOR BOLT LOCATION PRIOR TO ERECTION AND NOTIFY GENERAL CONTRACTOR OF ANY DISCREPENCIES SO THAT RELOCATION CAN BE MADE WITHOUT IMPEDING THE PROGRESS OF THE WORK. STRUCTURAL WELD SIZE SHALL BE 1/4" MIN. STRUCTURAL STEEL SHALL RECIEVE SHOP COATING OF ZINC CHROMATE. PROVIDE 1 COAT (TWO MILS THICK) WHERE EXPOSED. PROVIDE 2 COATS (4 MILS THICK) WHERE IMBEDDED IN MASONRY.

CONCRETE

FOLLOW THE STANDARDS OF ACI-316, ACI-301 AND ACI-347.

28 DAYS AS STATED BELOW, WITH A PLASTIC AND WORKABLE MIX. A CERTIFICATE OF MANUFACTURER'S SHALL BE BRACED WITH 16 GAUGE GALVANIZED METAL TIES ON A V FORM FROM BOTTOM TO TOP MIX AND STRENGTH IS TO BE PROVIDED. NO WATER IS TO BE ADDED AFTER THE TRUCK LEAVES THE PLANT, WITHOUT APPROVAL OF THE ENGINEER OR PLANT ENGINEER. PLANT CONTROL SHALL BE REQUIRED. MAXIMUM MIX TIME AT POINT OF DEPOSIT IS 90 MINUTES. MINIMUM COMPRESSIVE STRENGTH PLANS AND ENGINEERING SHOP DRAWINGS TO ARCHITECT FOR REVIEW AS TO COMPLIANCE WITH AT 28 DAYS SHALL BE AS FOLLOWS, UNLESS OTHERWISE NOTED (UON).

SLAB ON COMPACTED FILL = 3000 PSI STRUCTURAL SLABS = 4000 PSI

FOUNDATIONS = 3000 PSI COLUMNS AND BEAMS = 4000 PSI (U.O.N.)

BEAMS = 4000 PSI (U.O.N.)CONCRETE SHALL HAVE A MAXIMUM SLUMP OF 6"

MAXIMUM AGGREGATE SIZE SHALL BE ¾". ALL AGGREGATE SHALL CONFORM TO ASTM-33. MAXIMUM WATER CONTENT SHALL BE 33 GALLONS PER CUBIC YARD OF CONCRETE. MINIMUM CONCRETE PROTECTION FOR REINFORCING BARS: FOOTINGS = 3" BEAMS = 1 ½" SUSPENDED SLABS = 1"

SLAB SHALL BE A MIN IMUM OF 4" THICK AND SHALL BE REINFORCED WITH 6"x6" x1.4/1.4 W.W.M. CENTERED IN CONCRETE AND DOUBLED AT PERIMETER. REINFORCEMENT SHALL COMPLY WITH ASTM A615 AND ASTM A185 FOR WELDED WIRE FABRIC. ANY ADDITIONAL FILL PLACED ON THE BUILDING PAD SHALL BE COMPACTED TO A MINIMUM DENSITY

OF 95% OF THE T-180 MODIFIED PROCTOR TEST. THE AREA OF THE BOTTOM OF THE FOOTINGS SHALL BE COMPACTED PRIOR TO THE PLACEMENT OF STELL WITH A VIBRATORY COMPACTOR TO INSURE UNIFORM DENSITY BENEATH THE FOOTING. DENSITY TESTS SHALL BE TAKEN IN FOOTING AREAS. SLAB SHALL BE PLACED OVER ONE LAYER OF 6 MIL. VISQUEEN VAPOR BARRIER. ALL TIE BEAM REINFORCING SHALL EXTEND INTO SPAN OF ANY ADJACENT STRUCTURAL BEAM.

REINFORCEMENT CLEARANCE CLEARANCE OF REINFORCING STEEL FROM FACE OF CONCRETE TO THE OUTERMOST BAR SHALL BE AS FOLLOWS, WHEREVER PRACTICAL, UNLESS OTHERWISE NOTED ON STRUCTURAL DRAWINGS. FORMED CONCRETE IN CONTACT WITH GROUND BEAMS AND COLUMNS 1 1/2"

SLABS FOOTINGS 2" FROM TOP, 3"BOTTOM/SIDES TIE COLUMNS

POLYETHYLENE SHEET

POLYETHYLENE SHEET SHALL BE PLACED CONTINUOUSLY UNDER CONCRETE SLABS ON GROUND AND SHALL BE A MINIMUM OF 6 MIL. THICK. ALL JOINTS SHALL BE LAPPED MINIMUM 12" AND CONTINUOUSLY METAL SHAPES AS REQUIRED BY DESIGN OR AS INDICATED ON THE PLANS. ALL METAL PARTS ARE TO BE TAPED WITH A MINIMUM OF 2" WIDE VINYL TAPE. POLYETHYLENE SHEET SHALL EXTEND AT LEAST ONE INCH ONTO STEM WALL. WHERE PIPES, CONDUITS, STAKES, REINFORCING BARS OR OTHER OBJECT PASS SHOP DRAWINGS SHALL COMPLY WITH THE CURRENT BUILDING CODES, REGARDING MODIFICATION THGROUGH THE MEMBRANE, THE MEMBRANE SHALL BE FITTED WITHIN 2" AND SEALED WITH TAPE. SOIL SHALL BE TREATED FOR TERMITES FOR A DISTANCE OF FOUR FEET BEYOND THE PERIMETER OF ALL FOOTINGS AND/OR SLAB EDGES.

CALCULATIONS FOR VENTILATION:

BASED ON A .015 STATIC PRESSURE, 60 SQUARE INCHES FOR EACH CAR IN A DWELLING WILL PROVIDE THE NECESSARY 100 Cfm PER CAR W/ A 7.5 Mph WIND. VELOCITY @ 7.5 mph = 7.5 x 5280 / 60 = 660 FPM. FREE CFM = 60/144 x 660 - 275 Cfm FREE FLOW. **CONCRETE SLABS ON GRADE:**

all interior and exterior slabs and walkways as shown on the structural or ARCHITECTURAL PLANS, SHALL BE FOUR INCHES THICK MINIMUM REINFORCED WITH 6 X 6 - W1.4 X W1.4 WELDED WIRE FABRIC (UNLESS OTHERWISE NOTED).

ALL SLABS ON GRADE TO BE CONSTRUCTED IN ACCORDANCE WITH LATEST A.C.I - "GUIDE FOR CONCRETE FLOOR AND SLAB CONSTRUCTION" (A.C.I. - 302.1R).

JOINTS SHALL BE PROVIDED IN ALL INTERIOR SLABS ON GRADE AT COLUMN CENTER-LINES DIVIDING THE SLAB INTO SQUARE PANELS NOT TO EXCEED 20 X 20 FT. IN SIZE. CAST SLAB IN LONG ALTERNATE STRIPS. PROVIDE A CONTRACTION JOINT BETWEEN EACH STRIP. SEE PLAN FOR SAW-CUT, CONTRACTION AND ISOLATION JOINT DETAILS.

PROVIDE SAW-CUT JOINTS AT ALL SIDEWALKS AT A MAXIMUM SPACING OF FIVE FEET ON CENTERS AND ISOLATION JOINTS AT 20 FEET O.C. (U.O.N.). FILL MATERIAL SHALL BE PLACED IN LIFTS NOT EXCEEDING 12" AND COMPACTED TO 95 % MODIFIED PROCTOR (ASTM D-1557) WITHIN A DISTANCE OF 3 FEET BEYOND ALL FOOTING EDGES. TAKE AT LEAST ONE DENSITY TEST FOR EACH 1,600 SQ.FT. OF AREA AND 12" BELOW SURFACE. SEND RESULTS OF THE TEST TO OWNER, ARCHITECT AND ENGINEER. CONCRETE AND REINFORCING:

ALL REINFORCING TO BE NEW BILLET STEEL CONFORMING TO THE LATEST A.S.T.M. A-615 GRADE 60, FABRICATED IN ACCORDANCE WITH C.R.S.I. MANUAL OF STANDARD PRACTICE AND PLACED IN ACCORDANCE WITH A.C.I. 315 AND C.R.S.I. MANUAL OF STANDARD PRACTICE. COLUMN REINFORCEMENT: DOWELS TO BE SAME SIZE AND NUMBER AS VERTICAL REBARS ABOVE. LAP 36 bar diameter or minimum of 18 inches, u.o.n. provide rigid templets for dowel LOCATION. PROVIDE STANDARD HOOKS AT TOP OF ALL VERTICAL REINFORCEMENT AT

NONCONTINUOUS COLUMNS (U.O.N.). ALL DOWELS FOR COLUMNS SHALL BE SECURED IN POSITION PRIOR TO CONCRETING. PUSHING THE DOWELS INTO POSITION IN WET CONCRETE IS NOT PERMITTED.

BEAM REINFORCEMENT: LAPPED 36 BAR DIAMETER OR MINIMUM 18 INCHES (SEE BEAM DIAGRAM ON PLAN). BOTTOM BARS SPLICED ONLY AT SUPPORTS, TOP BARS SPLICED ONLY AT MID-SPAN. ALL TOP BARS HOOKED AT NONCONTINUOUS EDGES (U.O.N.). ALL HOOKS TO BE STANDARD 90 DEGREE HOOKS AS REQUIRED (U.O.N.). ADDED REINFORCEMENT: PROVIDE ADDITIONAL CORNER BARS BENT 36 INCHES MINIMUM EACH WAY AT "L" AND "T" CORNERS IN OUTER FACES OF ALL BEAMS TO MATCH ALL HORIZONTAL BAR (TOP.

BOTTOM AND INTERMEDIATE REBARS). 10. SEE STRUCTURAL PLANS FOR MIN. SIZE CONCRETE TIE BEAM

REQUIREMENTS.

ALL BLOCK WALLS SHALL BE TWO-CELL HOLLOW CONCRETE MASONRY REGULAR SIZE BLOCK MANUFACTURED IN CONFORMANCE WITH ASTM C-90 'STANDARD SPECIFICATIONS FOR HOLLOW LOAD ALL MATERIALS SHALL BE NEW AND BEAR U.L. LABELS, WHERE APPLICABLE. ALL AIR BEARING CONCRETE MASONRY UNITS', GRADE N, f'm = 1500 PSI. BLOCK SHALL BE PLACED USING RUNNING BOND UNLESS OTHERWISE NOTED. LAY-UP MASONRY WALLS TO BOTTOM OF TIE BEAMS BEFORE PLACING CONCRETE FOR IN-WALL COLUMNS. GROUT USED TO FILL MASONRY CELLS IS TO COMPLY WITH ASTM C-476 AND SHALL PROVIDE A MINIMUM COMPRESSIVE STRENGTH OF 3,000 PSI A 28 DAYS. THE GROUT MIX SHALL HAVE A MAXIMUM OF 3/8" COURSE AGGREGATE, AND SHALL BE PLACED WITH A SLUMP OF 8" TO 10". USE ONLY MECHANICAL VIBRATION TO CONSOLIDATE GROUT. TYPE 'S' MORTAR SHALL BE USED EXCLUSIVELY ON THIS PROJECT. MORTAR SHALL BE PROPORTIONED AND MIXED AS OUTLINED IN ASTM C-270.HORIZONTAL AND VERTICAL MORTAR JOINTS SHALL BE 3/8" THICK UNLESS OTHERWISE NOTED. REMOVE MORTAR PROTRUSIONS THAT EXTEND INTO CELLS TO BE FILLED AND ALLOW A MINIMUM OF 72 HOURS FOR MORTAR TO CURE PRIOR TO GROUTING CELLS. CLEAN OUT OPENINGS SHALL BE PROVIDED AT THE BOTTOM OF THE GROUTED CELLS AT EACH LIFT. CLEAN OUTS SHALL BE SEALED AFTER CLEANING AND INSPECTION AND BEFORE GROUTING. GROUT LIFT SHALL NOT EXCEED 4'

ALL REINFORCING STEEL SHALL BE GRADE 60, MEETING ASTM SPECIFICATION A-615. REINFORCING STEEL SHALL BE FREE FROM OIL, LOOSE SCALE AND RUST. MASONRY CONSTRUCTION AND MATERIALS SHALL CONFORM WITH ALL REQUIREMENTS OF THE "SPECIFICATIONS FOR MASONRY STRUCTURES" (ACI-530.1-99/ASCE 6-99/ACSE/TMS 602-99), AS

PUBLISHED BY THE MASONRY STANDARDS JOINT COMMITTEE. MASAONRY CONSTRUCTION SHALL BE PERFORMED UNDER THE DIRECT SUPERVISION OF A "CERTIFIED STRUCTURAL MASONRY CONTRACTOR". THE SUPERVISOR OF THE MASONRY PORTION OF THIS PROJECT SHALL BE A "CERTIFIED STRUCTURAL MASONRY CONTRACTOR" OR A "CERTIFIED STRUCTURAL MASON". THE SENIOR MASONRY SUPERVISOR WILL BE RESPONSIBLE TO ASSURE THAT THE WORK IS ACCOMPLISHED IN ACCORDANCE WITH THE CONTRACT DOCUMENTS

WHENEVER ANCHOR BOLTS ARE TO BE SET IN MASONRY, FILL TWO ADJACENT WITH CONCRETE GROUT. ALL GROUT SHALL BE FLUID, SLUMP SHALL BE 9" +- 1"

ANY CMU WALL OPENINGS WHICH ARE NOT OTHERWISE FRAMED SHALL HAVE 8"x8" (NOMINAL) CONCRETE LINTELS & SILLS REINFORCED WITH 2 #5 BOTTOM, MINIMUM OF 8" BEARING BOTH ENDS,

HORIZONTAL REINFORCEMENT EVERY OTHER COURSE 9 GAUGE GALVANIZED LADDER TYPE DUR-O-WALL (OR EQUAL)

WOOD TRUSS NOTES

LUMBER DESIGN LOADS ROOF LIVE LOAD = 30 PSF SUPERIMPOSED DEAD LOAD = 25 PSF FLOOR, LIVING AREAS (DL + LL) = 60 PSF, (BALCONY = 125 PSF) ALL LUMBER SHALL BE DOUGLAS FIR WITH A MINIMUM FIBER STRESS OF 1200 PSI, OR SOUTHERN PINE #2 STRUCTURAL GRADE, U.O.N. HATCHED WALLS INDICATE BEARING FRAME PARTITIONS AND SHALL HAVE CONCRETE IS TO BE A MIX DESIGNED IN ACCORDANCE WITH ASTM C-94-72 TO ACHIEVE A STRENGTH IN 2 X STUDS AT 16" O/C WITH DOUBLE TOP PLATE. ALL EXTERIOR AND INTERIOR STUD WALLS AS NOTED PLATE. ATTACH BRACES TO TOP AND BOTTOM PLATES WITH 2 - 16 PENNY NAILS. FOR INTERMEDIATE NAILING USE 10 PENNY NAILS. TRUSS MANUFACTURER SHALL SUBMIT FOUR (4) SETS OF TRUSS LAYOUT DESIGN CONCEPT. THE GENERAL CONTRACTOR SHALL BE RESPONSIBLE FOR VERIFYING ALL FIELD DIMENSIONS. ALL WOOD TRUSSES SHALL BE ANCHORED AT BOTH ENDS WITH APPROVED GALVANIZED METAL TRUSS STRAPS. TYPICAL EACH TRUSS. WHEN BEARING ON CONCRETE BEAM, EACH TRUSS MUST HAVE METAL TRUSS SEATS CAST INTO CONCRETE. ALL WOOD TRUSSES TO BE ANCHORED TO BEARING FRAME PARTITION WITH APPROVED GALVANIZED METAL TRUSS STRAPS, TYPICAL EACH TRUSS. ALL WOOD TRUSSES BEARING ON CONCRETE TIE BEAMS, TO HAVE GALVANIZED METAL TRUSS SEATS CAST INTO CONCRETE AT EACH TRUSS TYPICAL. TRUSS MANUFACTURER SHALL COORDINATE TRUSS FABRICATION WITH AIR CONDITIONING DUCT LAYOUT. ALL WOOD IN CONTACT WITH MASONRY, CONCRETE OR STEEL SHALL BE PRESSURE TREATED. HEADERS FOR FRAMED OPENINGS GREATER THAN 6'0" MUST BE ENGINEERED BY TRUSS MANUFACTURER. ALL HEADERS FOR FRAMED OPENINGS LESS THAN 6'0" HAVE BEEN DESIGNED BY RATIONAL ANALYSIS BY THE ENGINEER OF RECORD THE BRACING

SHOWN IN PLAN ACTS AS A RIGID CEILING PROVIDE REQUIRED DRAFTSTOPS IN TRUSS SPACE.

PRE-FABRICATED WOOD TRUSSES

STRUCTURAL ENGINEER OR ARCHITECT.

TRUSS MANUFACTURER IS RESPONSIBLE FOR THE DESIGN AND FABRICATION OF TRUSSES, GIRDERS, AND THEIR CONNECTIONS TO EACH OTHER. DESIGN FOR BRACING OF INDIVIDUAL TRUSS OR GIRDER MEMBERS TO RESIST LATERAL BUCKLING UNDER GRAVITY OR WIND LOADS IS THE RESPONSIBILITY OF THE TRUSS MANUFACTURER.

(DELEGATED ENGINEERING SHOP DRAWINGS REQUIRED) THE BUILDING CODE REQUIRES THE ENGINEER-OF-RECORD TO INCLUDE WITH ALL RECORD PLANS COMPLETE TRUSS FRAMING PLANS, INCLUDING ALL CONNECTIONS AND LOADING DATA, TO THE BUILDING DEPARTMENT FOR PERMIT. THE TRUSS DESIGN DELEGATED ENGINEER MUST FOLLOW THE LAYOUT OF THE TRUSSES AND GIRDER-TRUSSES, AS SHOWN ON THE STRUCTURAL FRAMING PLANS. DESIGNED AND FABRICATED IN ACCORDANCE WITH "NATIONAL DESIGN SPECIFICATIONS FOR STRESS GRADE LUMBER AND ITS FASTENERS" BY NFPA (LATEST EDITION)

TRUSSES SHALL BE DESIGNED, SIGNED AND SEALED BY A FLORIDA REGISTERED PROFESSIONAL ENGINEER, WHO MAY BE ASSIGNED AS A DELEGATED ENGINEER FOR THE CONTRACTOR. THE DELEGATED ENGINEER SHALL DESIGN AND INDICATE ON THE SHOP DRAWINGS ALL TRUSS COMPONENTS, TEMPORARY BRACING, BRIDGING, HARDWARE, METAL HANGERS, ANCHORS AND

OF THE FRAMING (FROM THE ONE SHOWN ON THE STRUCTURAL PLANS), INDICATING ALL PERMANENT BRACING (AS SHOWN ON THE STRUCTURAL PLANS) AND INDIVIDUAL MEMBER BRACING. THE STRUCTURAL PLANS INDICATE ALL THE REQUIRED LATERAL PERMANENT BRIDGING, AS RECOMMENDED BY THE "TRUSS PLATE INSTITUTE". TRUSS DESIGNER ENGINEER SHALL PROVIDE INFORMATION AND SHOW ON PLAN, ALL LATERAL BRACING OF ANY TRUSS INDIVIDUAL MEMBERS, AS REQUIRED BY TRUSS DESIGN.

PLATE INSTITUTE" (SHOWN ON THE ROOF PLAN). ANY TRUSS EXCEEDING THE SPECIFIED TOLERANCE MUST BE REALIGNED OR REPLACED. INSTALLATION OF TRUSSES LONGER THAN 35 FT. OR HIGHER THAN 6 FT. SHALL BE MADE UNDER THE DIRECT SUPERVISION OF A LICENSED BUILDING OR GENERAL CONTRACTOR OR A LICENSED

TRUSSES SHALL BE INSTALLED WITH OUT OF PLUMB AND OUT OF PLANE TOLERANCES, AS PER THE 'TRUSS

PLYWOOD ROOF DIAPHRAGM:

ROOF DIAPHRAGM SHALL COMPLY WITH THE DESIGN RECOMMENDATIONS OF "A.P.A. DESIGN/CONSTRUCTION GUIDE - DIAPHRAGMS".

PLYWOOD ROOF DECKING SHALL BE 19/32" MINIMUM THICKNESS, "CDX" TYPE AND SHALL BE CONTINUOUS OVER TWO OR MORE SPANS, WITH FACE GRAIN PERPENDICULAR TO THE SUPPORTS. CONNECT PLYWOOD DIAPHRAGM TO STRUCTURE WITH 10d GALV. NAILS, SPACED AT 6" O.C. MAX. AT

SUPPORTED EDGES AND AT 6" O.C. ALONG THE INTERMEDIATE SUPPORTS GABLE ENDS NAIL SPACING SHALL BE 4" ON CENTERS MAXIMUM. STRUCTURAL WOOD: TO CONFORM TO RULES OF THE MANUFACTURER'S ASSOCIATION UNDER WHOSE RULES THE LUMBER IS PRODUCED. (SEE SUPPLIER'S SPECIFICATIONS).

TO BE AIR DRIED, WELL SEASONED AND GRADE MARKED AT MILL. TO BE NO. 2 SOUTHERN PINE, UTILITY GRADE DOUGLAS FIR OR WEST COAST HEMLOCK. ALL STRUCTURAL WOOD TO BE SURFACED FOUR (4) SIDES (S-4-S) WITH A MINIMUM FIBER STRESS IN BENDING OF 1,200 P.S.I. AND A MAXIMUM MOISTURE CONTENT OF 19 PERCENT. ALL LUMBER AND PLYWOOD IN CONTACT WITH CONCRETE, STUCCO, MASONRY OR OTHER CEMENTITIOUS MATERIALS SHALL BE TREATED TO COMPLY WITH AWPA STANDARD LP-2.

STORE ALL LUMBER ABOVE GRADE OR FLOOR. STACK TO ALLOW PROPER AIR CIRCULATION AND PROTECT FROM WETTING WITH SUITABLE COVER.

H.V.A.C. CONTRACTOR SHALL SUBMIT FULLY ENGINEERED H.V.A.C. SHOP DRAWINGS TO THIS ARCHITECT'S OFFICE AND TO THE BUILDING DEPARTMENT FOR APPROVAL PRIOR TO CONSTRUCTION. ALL WORK SHALL BE PERFORMED BY A LICENSED CONTRACTOR, IN A FIRST CLASS WORKMANSHIP MANNER. THE COMPLETED SYSTEM SHALL BE FULLY OPERABLE AND ACCEPTANCE BY THE ENGINEER SHALL BE A CONDITION OF THE SUB-CONTRACT. CONTRACTOR SHALL VISIT THE JOB SITE AND THOROUGHLY FAMILIARIZE HIMSELF WITH ALL EXISTING CONDITIONS. ALL WORK SHALL BE COORDINATED WITH OTHER TRADES TO AVOID INTERFERENCE WITH THE PROGRESS OF CONSTRUCTION. ALL REQUIRED INSURANCE SHALL BE PROVIDED BY THE CONTRACTOR FOR PROTECTION AGAINST PUBLIC LIABILITY AND PROPERTY DAMAGE FOR THE DURATION OF THE WORK. THE CONTRACTOR SHALL FURNISH ALL LABOR, MATERIALS AND EQUIPMENT SHOWN OR INDICATED FOR A COMPLETE H.V.A.C.

A.N.S.I. B9.1 MECHANICAL REFRIGERATION N.F.P.A. PAMPHLETS 90A, 90B AND 91 S.M.A.C.N.A.

SYSTEM IN STRICT ACCORDANCE WITH ALL CODES, AND THE AGENCIES HAVING JURISDICTION OVER

THE PROJECT, AND ALSO THE LATEST EDITION WITH REVISIONS OF THE FOLLOWING PUBLICATIONS:

A.S.H.R.A.E. LOCAL, STATE AND NATIONAL CODE, rULES, REGULATIONS AND ORDINANCES

CONDITIONING DUCTS SHALL BE 1" THICK, 3 1/2" P.C.F. R-6 FIBERGLASS WITH VAPOR BARRIER JACKET, UNLESS OTHERWISE NOTED. FABRICATE AND INSTALL ALL DUCTS IN STRICT ACCORDANCE WITH THE MANUFACTURER'S PUBLISHED INSTRUCTIONS. DUCT SIZES ARE NET INTERNAL. ALL FRESH AIR EXHAUST AIR DUCTS SHALL HAVE AN ADJUSTABLE DAMPER AT GRILLS AND OR FANS. DUCTS FOR EXHAUST AIR OR FRESH AIR SHALL BE GALVANIZED SHEET METAL WRAPPED WITH MINIMUM 1" R-6 FIBERGLASS BATT OR BLANKET INSULATION. MOUNT ALL THERMOSTATS AT +4'-0" ABOVE FLOOR. ALL INTERIOR AND EXTERIOR MOUNTED H.V.A.C. EQUIPMENT SHALL BE SECURELY FASTENED IN PLACE WHERE SHOWN ON THE DRAWINGS AS REQUIRED BY THE LOCAL BUILDING CODES. THE H.V.A.C. CONTRACTOR SHALL PROVIDE SHOP DRAWINGS OF ALL OF THE ABOVE FOR APPROVAL. CONTRACTOR SHALL INSTALL ALL EQUIPMENT AND ACCESSORIES IN SUCH A MANNER THAT THEY MAY BE READILY ACCESSIBLE FOR SERVICING AND OR REPLACEMENT, H.V.A.C. CONTRACTOR SHALL BE RESPONSIBLE FOR BALANCING THE H.V.A.C. SYSTEM AND FOR PRINTING INSTRUCTIONS FOR THE OWNER'S OPERATION OF THE SYSTEM. ELECTRIC STRIP HEATERS SHALL BE UNIT-MOUNTED, COMPLETE WITH FUSES, HI-TEMP CUTOUTS (AUTOMATIC AND MANUAL), RELAYS AND ETC, WITH SIZES ARE REQUIRED. PROVIDE FIRE DAMPERS IN ALL DUCTS PASSING THRU FIRE RATED ROOF, CEILINGS AND WALLS, UNLESS OTHERWISE NOTED AND OR SHOWN ON THE PLANS AND/OR AS REQUIRED BY THE AUTHORITY HAVING JURISDICTION.\ ALL HEATING, VENTILATING AND AIR CONDITIONING SYSTEMS AND ETC. SHALL CONFORM TO THE STATE OF FLORIDA MODEL ENERGY EFFICIENCY CODE FOR BUILDING CONSTRUCTION, LATEST EDITION WITH REVISIONS. A/C AIR HANDLING UNITS SHALL HAVE CONDENSATION SAFE

ELECTRICAL NOTES

ANCHORAGE

LONG SPACED AT 4"C/C MAX.

THE DRAWINGS ARE DIAGRAMMATIC AND INDICATE THE GENERAL ARRANGEMENT OF THE ELECTRICAL WORK. ANY DISCREPANCIES ON THE DOCUMENTS SHALL BE CALLED TO ARCHITECT ATTENTION PRIOR TO COMMENCEMENT OF WORK. DO NOT SCALE ELECTRICAL DRAWINGS. ALL WORK SHALL BE DONE IN ACCORDANCE WITH THE LATEST EDITION OF THE NATIONAL ELECTRICAL CODE AND ALL CODES, REGULATIONS AND RESTRICTIONS HAVING JURISDICTIONS. DISCONNECT SWITCHES SHALL BE H.P. RATED, HEAVY-DUTY, QUICK-MADE, QUICK-BREAK ENCLOSURES AS REQUIRED BY EXPOSURE. OUTLET BOXES SHALL BE PRESSED STEEL IN DRY LOCATIONS, CAST ALLOY WITH THREADED HUBS IN WET AND DAMP LOCATIONS AND SPECIAL ENCLOSURES FOR OTHER CLASSIFIED LOCATIONS. ELECTRICAL SYSTEM SHALL BE GROUNDED. PROVIDE PROPER SIZE AND TYPE OF PROTECTION DEVICES TO MATCH EQUIPMENT BEING SERVED. LOAD DATA IS BASED ON INFORMATION GIVEN TO ARCHITECT/ENGINEER AT TIME OF DESIGN. VERIFY ALL EQUIPMENT AND PANEL SIZES PRIOR TO ORDERING. ALL MATERIALS SHALL BE NEW AND BEAR U.L. AND UNION LABELS, WHERE APPLICABLE. ALL WORK SHALL BE DONE BY A LICENSED ELECTRICAL CONTRACTOR IN A FIRST CLASS WORKMANLIKE MANNER. THE COMPLETED SYSTEM SHALL BE FULLY OPERATIVE AND ACCEPTABLE TO THE ENGINEER/ARCHITECT. ALL WORK SHALL BE COORDINATED WITH OTHER TRADES TO AVOID INTERFERENCE WITH PROGRESS OF CONSTRUCTION CONTRACTOR SHALL PROVIDE REQUIRED INSURANCE FOR THE PROTECTION AGAINST PUBLIC LIABILITY AND PROPERTY DAMAGE FOR THE DURATION OF THE WORK, CIRCUITS SHOWN ON PLANS ARE TO DETERMINE LOAD DATA AND PANEL SIZES. THE CONTRACTOR SHALL PROVIDE CIRCUITS AND REQUIRED ROUTING OF CONDUITS TO SUIT JOB CONDITIONS AND BALANCE LOADS. FURNISH AND INSTALL FIXTURES AS CALLED FOR ON PLANS OR AS SELECTED BY OWNER. THE ELECTRICAL CONTRACTOR SHALL COORDINATE THE EXACT LOCATION OF ALL H.V.A.C. EQUIPMENT AND THEIR GIVEN LOAD WITH THE MECHANICAL CONTRACTOR BEFORE ROUGHING-IN FOR PROPER POWER AND WIRING CONTROL LAYOUT AND INSTALLATION. ANY DISCREPANCIES BETWEEN THE GIVEN AND ACTUAL H.V.A.C. LOADS SHALL BE CORRECTED BEFORE ROUGHING IN. GROUND-FAULT CIRCUIT PROTECTION; ALL 120V SINGLE PHASE, 15 AND 20 AMP OUTLETS INSTALLED OUTDOORS, BATHROOMS AND GARAGE SHALL HAVE GROUND-FAULT CIRCUIT INTERRUPTER CIRCUIT BREAKER OR RECEPTACLES ALL BREAKERS SHALL HAVE 10,000 A.I.C. MINIMUM, U.O.N. INSTALL FACILITIES FOR TEMPORARY POWER FOR CONSTRUCTION AS REQUIRED. ELECTRICAL CONTRACTOR SHALL NOTIFY ENGINEER/ARCHITECT IN WRITING OF ANY CONFLICT AND/OR DISCREPANCIES FOUND WITH WORK AS SHOWN, SPECIFIED OR IMPLIED ON THESE PLANS, PRIOR TO PROCEEDING WITH WORK IN QUESTION. CONTRACTOR SHALL VERIFY EXACT LOCATIONS OF FIXTURES AND OUTLETS AT JOB SITE BEFORE ROUGHING. ALSO MAY SELECT DIFFERENT MANUFACTURER OR FIXTURES WITH EQUAL SPECIFICATIONS. SMOKE DETECTORS SHALL BE HARD WIRED (110 VOLT TYPE) TO NON-SWITCHABLE KITCHEN OR BATHROOM LIGHTING CIRCUIT AND SHALL NOT BE CONNECTED ONTO THE LOAD SIDE OF A GROUND FAULT CIRCUIT INTERRUPTER. SMOKE DETECTORS SHALL BE LOCATED ON OR NEAR THE CEILING IN THE IMMEDIATE VICINITY OUTSIDE OF EACH SLEEPING AREA AND ON EACH ADDITIONAL FLOOR LEVEL (STORY) AND BASEMENTS INCLUSIVE. BEDROOM ADDITIONS TO EXISTING DWELLINGS WILL BE SUBJECT TO THE SAME REQUIREMENTS. SMOKE DETECTORS SHALL BE 110 VOLT TYPE, PROVIDED WITH VISIBLE "POWER ON INDICATOR" AND A TEST BUTTON WITH BATTERY BACKUP SYSTEM. MULTIPLE DETECTORS MUST BE INTERCONNECTED. CONTRACTOR SHALL VERIFY WITH LOCAL ELECTRICAL UTILITY COMPANY THE LOCATION OF SERVICE AND SHALL LOCATE METER AND PANEL AS REQUIRED. VERIFY ALL CONDUCTORS AND BREAKERS W/ EQUIPMENT MANUFACTURER'S SPECIFICATIONS. COORDINATE RACEWAY INSTALLATION WITH OTHER TRADES PRIOR TO CONSTRUCTION. ALL ELECTRICAL SWITCHES SHALL BE 48" A.F.F. UNLESS OTHERWISE NOTED. ALL RECEPTACLES SHALL BE 12" A.F.F. UNLESS OTHERWISE THE ELECTRICAL CONTRACTOR SHALL SECURE ALL PERMITS AND INSPECTIONS REQUIRED BY STATE AND

LOCAL LAWS AND ORDINANCES. ALL PANELS SHALL HAVE CIRCUIT DIRECTORY CLEARLY LABELED AND MOUNTED INSIDE THE DOOR.

PROVIDE GROUNDING SYSTEM FOR ALL TELEPHONE OUTLETS AND EQUIPMENT PER REQUIREMENTS OF THE TELEPHONE COMPANY COORDINATE THE INSTALLATION OF ALL TELEPHONE OUTLETS, RACEWAYS, ENCLOSURES AND BACKBOARDS WITH THE TELEPHONE COMPANY.

TELEPHONE CONDUITS SHALL NOT BE INSTALLED IN THE SAME TRENCH WITH POWER AND LIGHTING CONDUITS. COORDINATE ALL ELECTRICAL SITE WORK WITH THE GENERAL CONTRACTOR.ALL GARAGE, EXTERIOR BATHROOM AND KITCHEN RECEPTACLES MUST BE GROUND FAULT CIRCUIT INTERRUPTOR PROTECTED. ALL BEDROOM SHALL HAVE ARC FAULT INTERRUPTER RECEPTACLES

PROVIDE A SEPARATE CIRCUIT FOR A PERSONAL COMPUTER. LOCATION TO BE COORDINATED WITH

METAL AND WIRE LATH: "PNEU-FAST" 16 GA. STAPLE SPEC. #101-1, TYPE 1 OR BETTER (HOT DIPPED) SATIN

FIN. GALVANIZED COATING, HAVING A TENSILE STRENGTH OF 130M PSI. STAPLES SHALL BE MIN. 1 1/2"

FURNISH ALL LABOR, MATERIALS AND EQUIPMENT REQUIRED FOR THE COMPLETION OF THE SOIL, WASTE, VENT, DOMESTIC WATER HEATERS, PLUMBING FIXTURES AND ALL OTHER SYSTEMS AS INDICATED ON THE DRAWINGS ALL WORK AND MATERIALS SHALL BE IN STRICT ACCORDANCE WITH ALL LOCAL CODES, RULES AND

ORDINANCES HAVING JURISDICTION. DRAWINGS ARE DIAGRAMMATIC. DO NOT SCALE FOR THE EXACT LOCATION OF FIXTURES, PIPING. EQUIPMENT, ETC. PLUMBING CONTRACTOR SHALL VERIFY ALL SPACE CONDITIONS AND DIMENSIONS AT JOB SITE PRIOR TO FABRICATION AND INSTALLATION OF MATERIALS AND FQUIPMENT. EXTEND SERVICE TO WATER METER. PROVIDE WATER METER AND SHUTOFF VALVE IN VALVE BOX OUTSIDE BUILDING. CONSULT ARCHITECT FOR LOCATION. LOCATIONS WHERE PIPES PENETRATE WALLS, FLOORS, AND CEILINGS SHALL BE WATERTIGHT. SANITARY PIPES SHALL BE OF HUBLESS CAST IRON OR PVC (SCHEDULE 40) AS APPROVED BY BUILDING OFFICIAL CONTRACTOR TO VERIFY AT SITE LOCATION, ALL EXISTING CONDITIONS, ELEVATIONS AND SIZE OF

ALL WORK SHALL BE PERFORMED BY A LICENSED PLUMBING CONTRACTOR, IN A FIRST-CLASS WORKMANLIKE MANNER AND MAKE THE COMPLETED SYSTEM FULLY OPERATIVE. ALL WORK SHALL BE COORDINATED WITH OTHER TRADES TO AVOID INTERFERENCE WITH THE PROCESS OF CONSTRUCTION. ALL REQUIRED INSURANCE SHALL BE PROVIDED FOR PROTECTION AGAINST PUBLIC LIABILITY AND

EXISTING MAINS, WATER AND SEWER FOR CONNECTION OF NEW SERVICES BEFORE INSTALLATION OF

PROPERTY DAMAGE FOR THE DURATION OF THE WORK. ALL MATERIALS SHALL BE NEW AND SHALL BEAR UNDERWRITERS' AND UNION LABELS WHERE REQUIRED. ALL EXCAVATION AND BACKFILL AS REQUIRED FOR THIS PHASE OF CONSTRUCTION SHALL BE PART OF THIS CONTRACT. UNDERGROUND METAL PIPING SHALL BE PROTECTED WITH A COAT OF BITUMINOUS COMPOUND BEFORE COVERING. "BITUMASTIC" OR EQUAL. ALL UNDERGROUND SOIL AND WASTE PIPING SHALL BE SCHEDULE 40 P.V.C. OR SERVICE WEIGHT CAST IRON WITH MEDIUM WEIGHTS CAST IRON FITTINGS. ALL JOINTS BELOW SLAB TO BE MADE WITH OAKUM AND PURE VIRGIN LEAD. SOIL, WASTE AND VENT PIPING ABOVE SLAB TO BE SAME AS SPECIFIED FOR BELOW SLAB EXCEPT THAT THE CONTRACTOR MAY AT HIS OPTION USE NO-HUM PIPE AND FITTINGS IF ACCEPTABLE BY LOCAL

ISOLATE COPPER PIPE FROM HANGER OR SUPPORT WITH ISOLATOR PAD, SUPER STRUT MODEL C/15/16 (OR EQUIVALENT) OR HAIR FELT LINING. HANGERS FOR COPPER PIPING SHALL BE COPPER OR COPPER

ALL PIPING SHALL BE SUPPORTED IN APPROVED MANNER FROM BUILDING STRUCTURE. HANGERS FOR COPPER PIPING SHALL BE COPPER OR COPPER PLATED ALL RATED FLOOR AND WALL PENETRATIONS (NO PVC) SHALL HAVE FIRE, SMOKE, AND WATER STOPS BY FILLING VOIDS BETWEEN PIPE AND WALL/FLOOR SLEEVES WITH FIRE RATED FOAM, CHASE TECHNOLOGY CORP. CIC PR 855 OR 3M CP-25 CAULKING OR 303 PUTTY TO ACHIEVE THE SAME FIRE RATING AS WALLS

LOCATIONS WHERE PIPES PENETRATE WALLS, FLOORS AND CEILINGS SHALL BE WATERTIGHT CONDENSATE DRAIN PIPES SHALL BE A MINIMUM OF 3/4" PVC (SCHEDULE 40) WITH TRAPS, INSULATED WITH 1/2" ARMAFLEX, AND TERMINATED 6" ABOVE GRADE OUTSIDE OF THE BUILDING. FURNISH AND INSTALL PRESSURE RELIEF VALVE LINE AND TERMINATE AT A LOCATION TO PROVIDE READY, VISUAL INDICATION FLOW, COPPER WATER LINES RUNNING UNDER SLAB SHALL BE PROTECTED BY A MINIMUM OF 12 INCHES OF EARTH COVER, 1 INCH AMAFLEX (HOT WATER ONLY) AND SLEEVED 12 INCH BELOW SLAB TO 12 INCHES ABOVE SLAB

VERIFY ALL DIMENSIONS WITH STRUCTURE PRIOR TO ANY FABRICATION OR INSTALLATION. ALL FIXTURES SHALL BE PROTECTED AGAINST WATER HAMMER WITH APPROVED AIR CHAMBERS OR SHOCK ABSORBERS. PROVIDE CONTROL VALVES TO ALL MAINS ENTERING THE BUILDING, RISERS, BRANCHES, GROUP OF FIXTURES, AND TO EACH PIECE OF EQUIPMENT.

PROVIDE FULLY ACCESSIBLE CLEANOUTS ON SANITARY AND ANY WASTE PIPING AT BOTTOM OF STACKS. CLEANOUTS LOCATION AND SIZES ON HORIZONTAL LINES SHALL BE ACCORDING TO CODE. VENT LINES TO EXTEND 6" MINIMUM ABOVE ROOF AND FLASH WITH LEAD. PROVIDE AIR CHAMBERS AND SHUT OFF VALVES FOR ALL WATER SUPPLY PIPING AT FIXTURES. PROVIDE VACUUM BREAKER AND SHUT OFF VALVE ON ALL HOSE BIBBS ALL HOSE BIBS SHALL BE FURNISHED WITH BACKFLOW PREVENTERS AND MOUNTED 26" ABOVE GRADE. SANITARY PLUMBING PIPING TO HAVE MIN, 1/8" PER FT. PITCH AT ALL HORIZ. RUNS PROVIDE CLEANOUTS

AT THE BASE OF WASTE STACKS PROVIDE 1/4" WATER SERVICE TO REFRIGERATOR. ALL FIXTURES SHALL COMPLY WITH MAXIMUM FLOW RATE OF CONSUMPTION, INSTALL ANTI-SCALD

VALVES AS REQUIRED. LAVATORY 2.5 GPM SHOWER HEAD 2.5 GPM @ 80 PSI

WATER CLOSET 1.6 GAL. PER FLUSH SINK FAUCET 2.5 GPM @ 60 PSI TEST ALL WATER PIPING UNDER A 150 PSI HYDROSTATIC TEST FOR A MINIMUM PERIOD OF TWO HOURS.

LANDSCAPING NOTES NO MORE THAN 50% OF REQUIRED TREES CAN BE SAME SPECIES.

ALL TREES SHALL BE PROPERLY GUYED AND STAKED AT TIME OF PLANTING. SOD TO BE ST. AUGUSTINE "FLORITAM" FREE OF ALL PESTS OR DISEASE. IT SHALL BE LAID EVEN WITHOUT

GROUND COVER AND SHRUBS TO BE LAID OUT IN A UNIFORM AND CONSISTENT PATTERN. ALL PLANT MATERIAL SHALL HAVE AN APPLICATION OF SLOW- RELEASE FERTILIZER (AGRI- FORM OR SIMILAR) AT TIME OF INSTALLATION CONTRACTOR IS RESPONSIBLE FOR LOCATING ALL UNDERGROUND UTILITIES TO AVOID DAMAGE.

CONTRACTOR SHALL BE RESPONSIBLE FOR ALL PLANTS AND MATERIALS NECESSARY TO ACHIEVE A FULL AND COMPLETED APPEARANCE IN ALL PLANTING BEDS. THE MINIMUM TOPSOIL DEPTH SHALL BE 6 INCHES FOR GROUND COVER AREAS, 4 INCHES FOR SEEDED GRASS AREAS, AND 2 INCHES FOR SODDED AREAS.

ALL LANDSCAPING MATERIALS TO BE FLORIDA NO. 1 GRADE OR BETTER. ALL EXTERIOR LIGHT SOURCES MUST BE RECESSED WITHIN THE STRUCTURE OR FIXTURE IN WHICH IS

INCHES ABOVE THE ITEM TO BE SCREENED. GRASS OR SOD SHALL BE PROVIDE IN ALL OPEN AREAS. INCLUDING SWALE AREA AS SHOWN ON IT SHALL BE THE RESPONSIBILITY OF THE CONTRACTOR TO ASSURE PROPER WATERING AND SAFEGUARD AGAINST DAMAGE OF ANY KIND DURING THE INSTALLATION UNTIL FINAL APPROVAL OF WORK. ALL TREE SPECIES SHALL BE A MINIMUM OVERALL HEIGHT OF 10 FEET WITH A MINIMUM CANOPY

ALL MECHANICAL EQUIPMENT TO BE SCREENED ON THREE (3) SIDES AS SHOWN WITH SHRUBS SIX (6)

CLEAR WOOD IMMEDIATELY AFTER PLANTING. HEDGES SHALL BE MINIMUM 2 FEET IN HEIGHT (FULL TO BASE) PLANTED 2 FEET ON CENTER. ALL TREES AND SHRUBS SHALL BE PLANTED WITH A MINIMUM OF 6 INCHES OF TOPSOIL AROUND AND

SPREAD OF 4 FEET AND MINIMUM TRUNK DIAMETER AT BREAST HEIGHT OF 2" AND A MINIMUM OF 4 FEET

A MINIMUM OF 2 INCHES CYPRESS MULCH (OR APPROVED EQUAL) OR GROUND COVER SHALL BE INSTALLED AT BASE OF EACH TREE AND THROUGHOUT HEDGE AND SHRUB PLANTING.

SPRINKLERS (IF SPECIFIED)

ALL LANDSCAPE AREAS SHALL BE IRRIGATED BY A FULLY AUTOMATIC SPRINKLER SYSTEM ADJUSTED TO PROVIDE 100 % COVERAGE OF ALL LANDSCAPE AREAS. ALL HEADS SHALL BE OVERLAP AS PER MANUFACTURERS SPECIFICATIONS AND PERFORMANCE ADJUSTED TO 50 STANDARDS. EACH SYSTEM SHALL BE INSTALLED WITH A RAIN SENSOR.

OWNER SHALL APPROVE ALL MATERIAL AND FINISH SAMPLES ALONG WITH ALL EQUIPMENT SPECIFICATIONS PRIOR TO ORDERING AND INSTALLATION. PROVIDE THRERSHOLD AND WEATHERSTRIPPING AT ALL EXTERIOR DOORS.

MORTAR TO HAVE COMPRESSIVE STRENGTH: TYPE S - 1800 psi AT 20 DAYS EXPANSION STRIPS TO BE PLACED PER MFGR. SPECS.


GARAGE NOTES

PARTITIONS BETWEEN GARAGE AND LIVING AREAS WITH R-11 INSULATION. NO. 25 GAUGE "GYPSUM WALLBOARD APPLIED CHANNEL-SHAPED STUDS @ 16" O/C WITH ONE FULL LENGTH LAYER OF VERTICALLY, ATTACHED WITH 1" LONG NO. 6 DRYWALL SCREWS TO EACH SIDE. SCREWS ARE 8" O/C AROUND PERIMETER AND AT 12" O/C ON THE INTERMEDIATE STUD.

SANDRA PUERTARCHITEC

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BLDG. DEPT.


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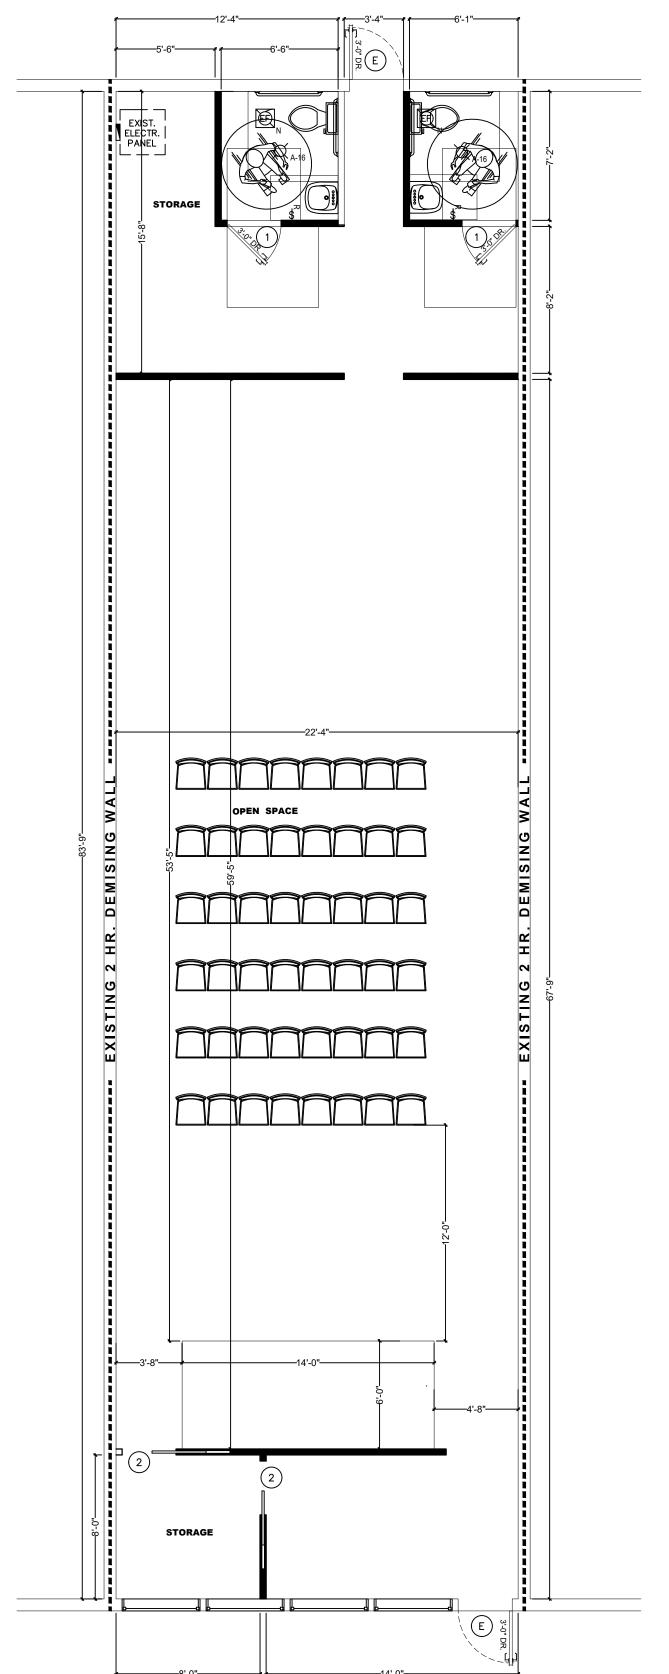
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Notes and Specifications MANAGED BY: **FZ**

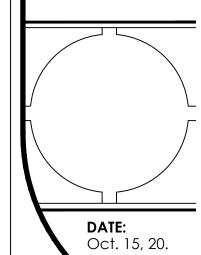DRAWN BY: **AD/FZ** REVIEWED BY: **SP**





GENERAL CONSTRUCTION NOTES

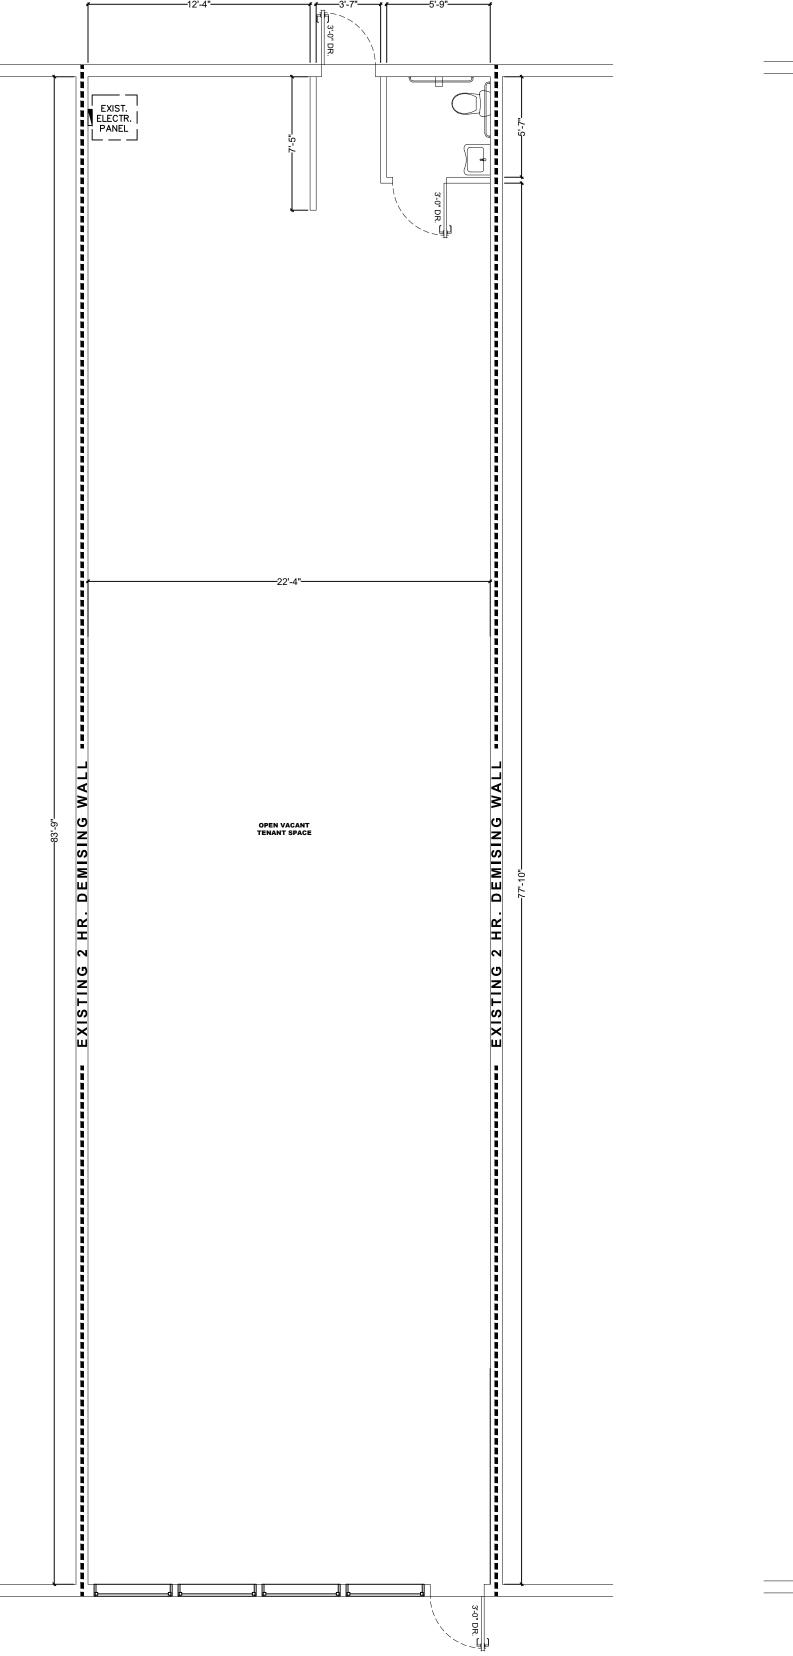1. ALL WORK BY ALL TRADES TO BE COMPLETED IN ACCORDANCE WITH ALL APPLICABLE, LOCAL, & GOVERNMENTAL CODES, ORDINANCES, STANDARDS

2. ALL TRADES TO COORDINATE THEIR WORK WITH ALL OTHER TRADES TO

AVOID INTERFERENCE WITH THE PROGRESS OF CONSTRUCTION. 3. CONTRACTOR TO VERIFY ALL DIMENSIONS ON THE JOB PRIOR TO COMMENCING CONSTRUCTION AND NOTIFY ARCHITECT OF ALL DISCREPANCIES. DIMENSIONS ALWAYS TAKE PRECEDENCE OVER SCALED

4. ALL DIMENSIONS ARE NOMINAL TO THE FACE OF STUDS, CONC. BLK. OR EDGE OF MONOLITHIC SLAB FOOTING UNLESS NOTED OTHERWISE. DOOR AND WINDOW SIZE OPENINGS TO BE VERIFIED WITH THE MANUFACTURER.

5. IT IS NOT THE INTENT OF THESE PLANS TO SHOW EVERY MINOR DETAIL OF CONSTRUCTION, THE CONTRACTOR IS EXPECTED TO FURNISH & INSTALL ALL ITEMS FOR COMPLETE FULLY OPERATIVE SYSTEMS IN FIRST CLASS

6. INSULATE EXTERIOR MASONARY WALL WITH MIN. R-4.1 INSUL., EXTERIOR WD. 7. COMPACT ALL FILL TO A MIN. OF 95% DENSITY AND POISON SOIL FOR TERMITES; MIN. SOIL BRG.: 2500 P.S.F.

8. MIN. CONC. STRENGTH: 3000 P.S.I. @ 28 DAYS. MIN. CONCRETE COVERAGE FOR REINF. BARS. SLAB: 3/4"; BEAMS & COLS: 1 1/2"; TIE COLS: 3/4"; FORMED CONC. BELOW GRADE: 2" & UNFORMED CONC.: 3". 9. REINFORCING STEEL TO BE GRADE 60.

10. DETAILS OF CONCRETE REINF. SHALL BE IN ACCORDANCE WITH "THE MANUAL OF STD. PRACTICE FOR REINFORCED CONCRETE CONSTRUTION".

11. TIE COLUMNS TO HAVE DOWELS INTO CONCRETE FTG. WITH THE SAME SIZE AND NUMBER OF DOWELS AS VERTICAL REINF. BARS.; REINF. STL. TO BE LAPPED 30 BAR DIAM. MIN. @ SPLICES.

CONCRETE BLK. TIE COLUMNS.

13. ALL WOOD IN CONTACT WITH CONC., MASONRY OR STL. SHALL BE PRESS. TRTD. WD. STRUCTURAL LUMBER TO BE A STRESS GRADE OF MIN. $F=1200\ PSI$

14. MIN. ELECTRICAL WIRE SIZE SHALL BE #14 A.W.G. (EXCLUDING THE CONTROL WIRING). ALL CONDUCTORS SHALL BE "COPPER" WITH "THHN"

15. ALL RACEWAYS UNDERGROUND OR LARGER THAN 2" IN DIAM. SHALL BE

16. PROVIDE "GFI" RECEPTACLES IN BATHROOMS, AT KITCHEN COUNTERS, IN 17. SANITARY PLBG. PIPING TO HAVE MIN. 1/8" PER FT. PITCH AT ALL HORIZ.

18. ALL UNDERGRD. WATER PIPING SHALL BE COPPER TYPE "K; ALL OTHER WATER PIPING SHALL BE COPPER TYPE "L".

19. PROVIDE AIR CHAMBERS AND SHUT OFF VALVES FOR ALL WATER SUPPLY PIPING AT FIXTURES; PROVIDE VACUUM BREAKER AND SHUTOFF VALVE ON

20. A/C AIR HANDLING UNITS TO HAVE CONDENSATE SAFE WASTE WITH TRAP.

• W/	ALL PLAI	N LEGEND .
WALL	TYPE	WALL DESCRIPTION
	EXISTING EXTERIOR WALL	EXISTING - NO CHANGE
	EXISTING INTERIOR WALL	EXISTING - NO CHANGE
	IN FILL EXTERIOR WALL	IN FILL OPENING
	NEW INTERIOR WALL	NEW WALLS AS PER DETAIL
	NEW EXTERIOR CBS WALLS	NEW WALLS AS PER DETAIL
	NEW EXTERIOR FRAME WALLS	NEW WOOD FRAMED WALLS AS PER DETAIL

SCOPE OF WORK

- 1. CHANGE OF USE FROM GENERAL COMMERCIAL TO ASSEMBLY (A-3).
- 2. PROPOSED WALLS AS PER PLANS.
- 3. ELECTRICAL WORK AS PER PLANS.
- 4. SEE PLANS FOR MORE INFORMATION.

NO MECHANICAL WORK. ALL EXISTING TO REMAIN.

NO ADDITIONAL SQ.FT. INTERIOR WORK ONLY

PAINTING EXIST.CEILING TILES IF NECESSARY

REMOVE & REPLACE CEILING TILES IF NECESSARY

NOTE:
CONTRACTOR TO VERIFY IN FIELD IF PANIC
HARDWARE HAS BEEN PROVIDED ON ALL EGRESS
DOORS AS PER 2017 FBC SECTION 1008.1.10.

NOTE: ALL SINK AND DOOR HARDWARE TO BE LEVER TYPE.

ALL FINISHES TO BE SPECIFIED BY OWNER. ALL WALLS TO BE F.R.P. AND FLOOR TO BE TILE. OWNER TO SPECIFY COLOR AND MANUFACTURER. INSTALL ALL FINISHES ACCORDING TO FBC 2017. NOTE: NUMERICAL ADDRESS TO BE PROVIDED ON ALL EXTERIOR DOORS

NOTE:
BUILDING IS REQUIRED TO BE PROVIDED WITH ADDRESS NUMBERS OR LETTERS PLAINLY VISIBLE FROM THE STREET PER 2017 FBC SECTION 501.2.

CONTRACTOR TO VERIFY ANY CONDITION AND NOTIFY ALL RESPONSIBLE PARTIES IF THERE ARE ANY DISCREPANCIES. THE ARCHITECT ASSUMES NO RESPONSIBILITY.

ALL WORK TO BE PERFORMED IN ACCORDANCE WITH THE F.B.C 5TH EDITION (2017) EDITION, THE N.E.C., FLORIDA, FIRE PREVENTION CODE, 5TH EDITION WITH LATEST SUPPLEMENTS, THE ZONING ORDINANCES IN THE CITY OF JURISDICTION AND ALL APPLICABLE CODES AND STANDARDS.

	DOOR SCHEDULE																						
		SIZE		N	/ATE	ERIA	L		Q	ΓY	0	PER.	ATIC	N			FRA	AME					
	(R.0	D.)			SS		SS	_ASS										MΩ					
MARK	W	H	TH	MOOD	WD/GLAS	METAL	FBRGLAS	ALUM/GL	SINGLE	DOUBLE	HINGED	SLIDING	BI-FOLD	POCKET	OTHER	WOOD	METAL	ALUMINU	EXTG	IRON	THRESHOL	HW SET	NOTES
1	3'-0"	6'-8"	1 3/4"	•					•		•					•							
2	3'-0"	6'-8"	1 3/4"	•					•					•		•							
Е		EXISTING TO REMAIN																					

			V	117	1D	OV	I S	CH	IEI	DU	LE	
	SIZE (R.	0.)		МАТЕ	RIAL		OF	PERATI	ON			
							VE	ENTED				
MARK	W	н	TYPE	WOOD	ALUM.	WD/CLAD	CUSTOM	H. ROLL	S. HUNG	FIXED	NOTES	REMARKS
E	EXISTING TO REMAIN											

NOTE:

ALL WINDOWS AND DOORS TO BE NEW, UNLESS NOTED WITH "E" FOR EXISTING TO REMAIN

NOTE:

EXIST. MECHANICAL SYSTEM AND EXIST. LIGHTINGS TO REMAIN

SANDRA PUERTARCHITECT

GROUP, INC.
: #: AA26002780 • AR 95385

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Oct. 15, 20.

BLDG. DEPT. PLAN **REVISIONS:**

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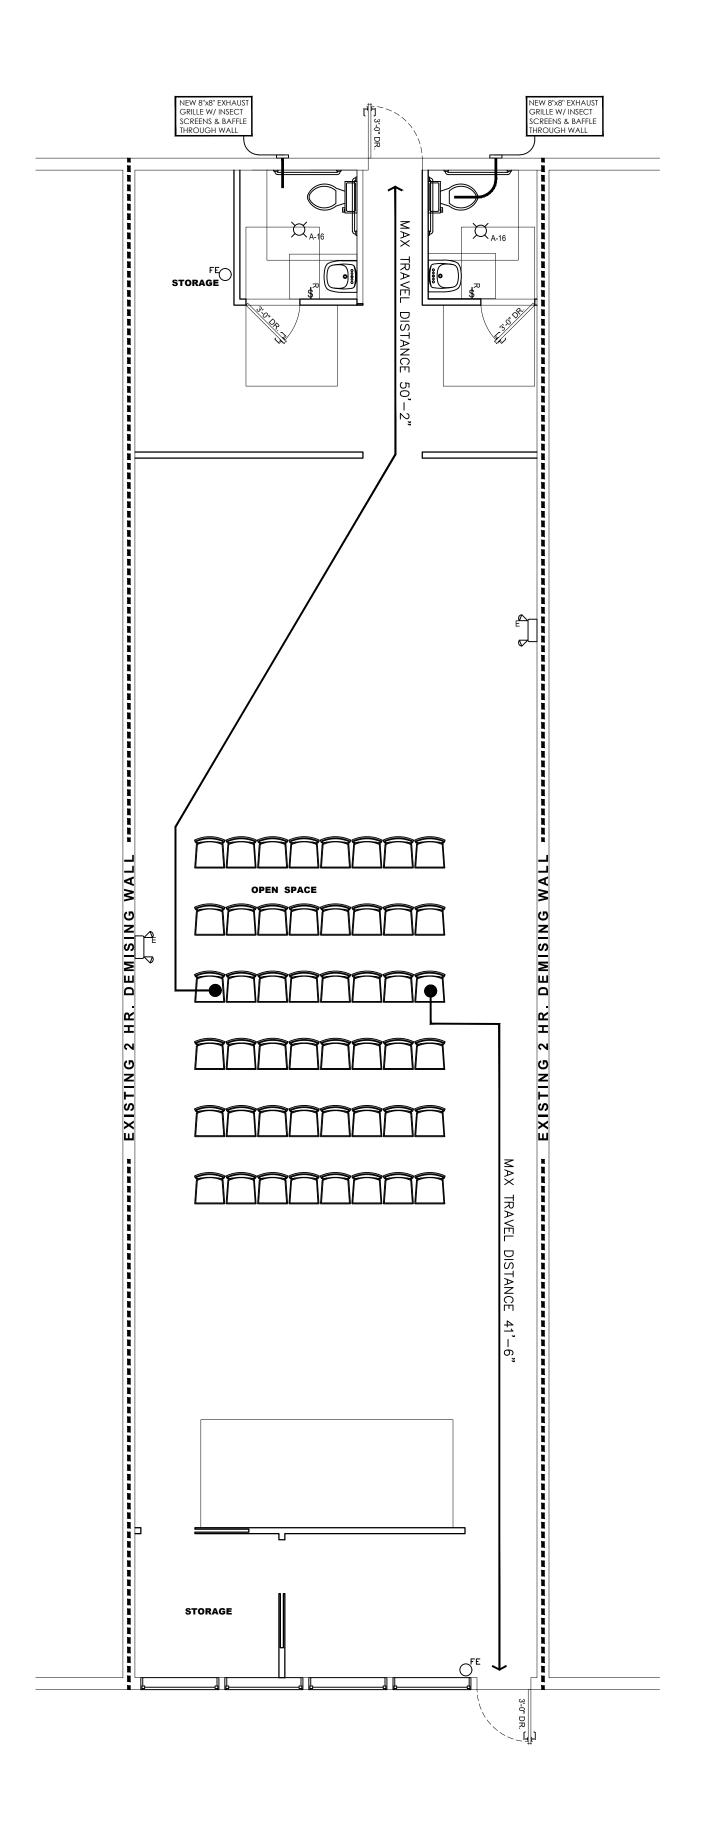
Proposed Floor Plan

MANAGED BY: **FZ** DRAWN BY: AD/FZ

REVIEWED BY: SP

EXISTING FLOOR PLAN
SCALE: 3/16" = 1'-0"

CONSTRUCTION PLAN SCALE: 3/16" = 1'-0"



EGRESS | LIFE SAFETY GENERAL NOTES

1. THE CONTRACTOR SHALL PROVIDE AND INSTALL (1) 10 LBS. ABC TYPE U.L. LISTED FIRE EXTINGUISHER PER 2500 S.F. LOCATION SHALL BE APPROVED BY FIRE MARSHALL PRIOR TO INSTALLATION.

2. EQUIPMENT AND CONNECTIONS TO THE BUILDING FIRE ALARM CONTROL PANEL SHALL BE PROVIDED. THE CONTRACTOR SHALL VERIFY THE BUILDING SYSTEM PRIOR TO BIDDING AND INCLUDE ALL REQUIRED ELEMENTS IN THE BID.

ASSEMBLY OCCUPANCIES

EGRESS REQUIREMENTS SHALL COMPLY WITH NFPA 101. CHAPTER 7 SECTION 7.2, MEANS OF EGRESS COMPONENTS AND SECTION 12.2, MEANS OF EGRESS REQUIREMENTS FOR ASSEMBLY OCCUPANCIES, ALL HARDWARE SHALL COMPLY WITH SECTION 7.2.1.5.LOCKS, LATCHES, AND ALARM DEVICES FOR LOCKING REQUIREMENTS

EXIT REQUIREMENTS

MORE THAN 50 PERSONS: TWO EXITS REQUIRED AND DOOR MUST SWING WITH PATH OF EGRESS.

EXIT ACCESS TRAVEL DISTANCE PER TABLE 1016.1 FOR ASSEMBLY OCCUPANCY: 250'-0" W/ APPROVED FIRE SPRINKLER SYSTEM.

1 EXITS REQUIRED, 2 EXITS PROVIDED PER TABLE 1005.1 FOR 151 OCCUPANTS.

ONLY ONE EXIT IS REQUIRED FOR OCCUPANTS UNDER 49

CONTRACTOR TO VERIFY EXISTING CONDITIONS OF SPACE TO MEET FIRE-RESISTANCE RATING REQUIREMENTS AS PER FBC TABLE 706.3.7.

CLASSIFICATION OF HAZARDS

ORDINARY HAZARD AS PER 2012 NFPA 101 38.1.5.

TYPE OF CONSTRUCTION: TYPE IIIB - NOT PROTECTED (UNSPRINKLERED).

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		2.	С


AME SPREAD GROUP: Class A Interior Finish. Flamespread 0-25, Smoke Developed 0-450. Any element thereof when do tested shell not continue to propagate fire.

Class B Interior Finish. Flamespread 26—75, Smoke Developed 0—450.


3. Class C Interior Finish. Flamespread 76-200, Smoke Developed 0-450.

MINIMUM INTERIOR FINISH CLASSIFICATION: UNSPRINKLERED SPRINKLERED Exit Exit¹ Access Spaces Exit¹ Access Spaces

	EGRESS	LIFE SAFETY LEGEND
SYMBOL		DESCRIPTION
	EGRESS PATH	DENOTES PATH OF EGRESS AND TRAVEL DISTANCE.
FE	FIRE EXTINGUISHER	FIRE EXTINGUISHER 2A10BC 10 LBS
"K" FE	FIRE EXTINGUISHER	FIRE EXTINGUISHER NEW "K" TYPE
#	KEY NOTE	SEE EGRESS LIFE SAFETY NOTES
	EMERGENCY LIGHTS / EXIT SIGN	SEE EGRESS LIFE SAFETY NOTES

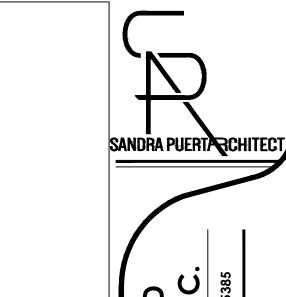


THE CONSTRUCTION AND ARCHITECTURE GROUP, INC

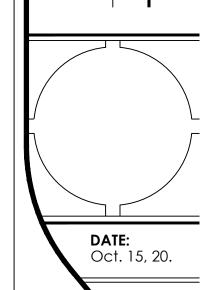


BLDG. DEPT. PLAN **REVISIONS:**


e of Use for: Lighth

MANAGED BY: FZ REVIEWED BY: SP

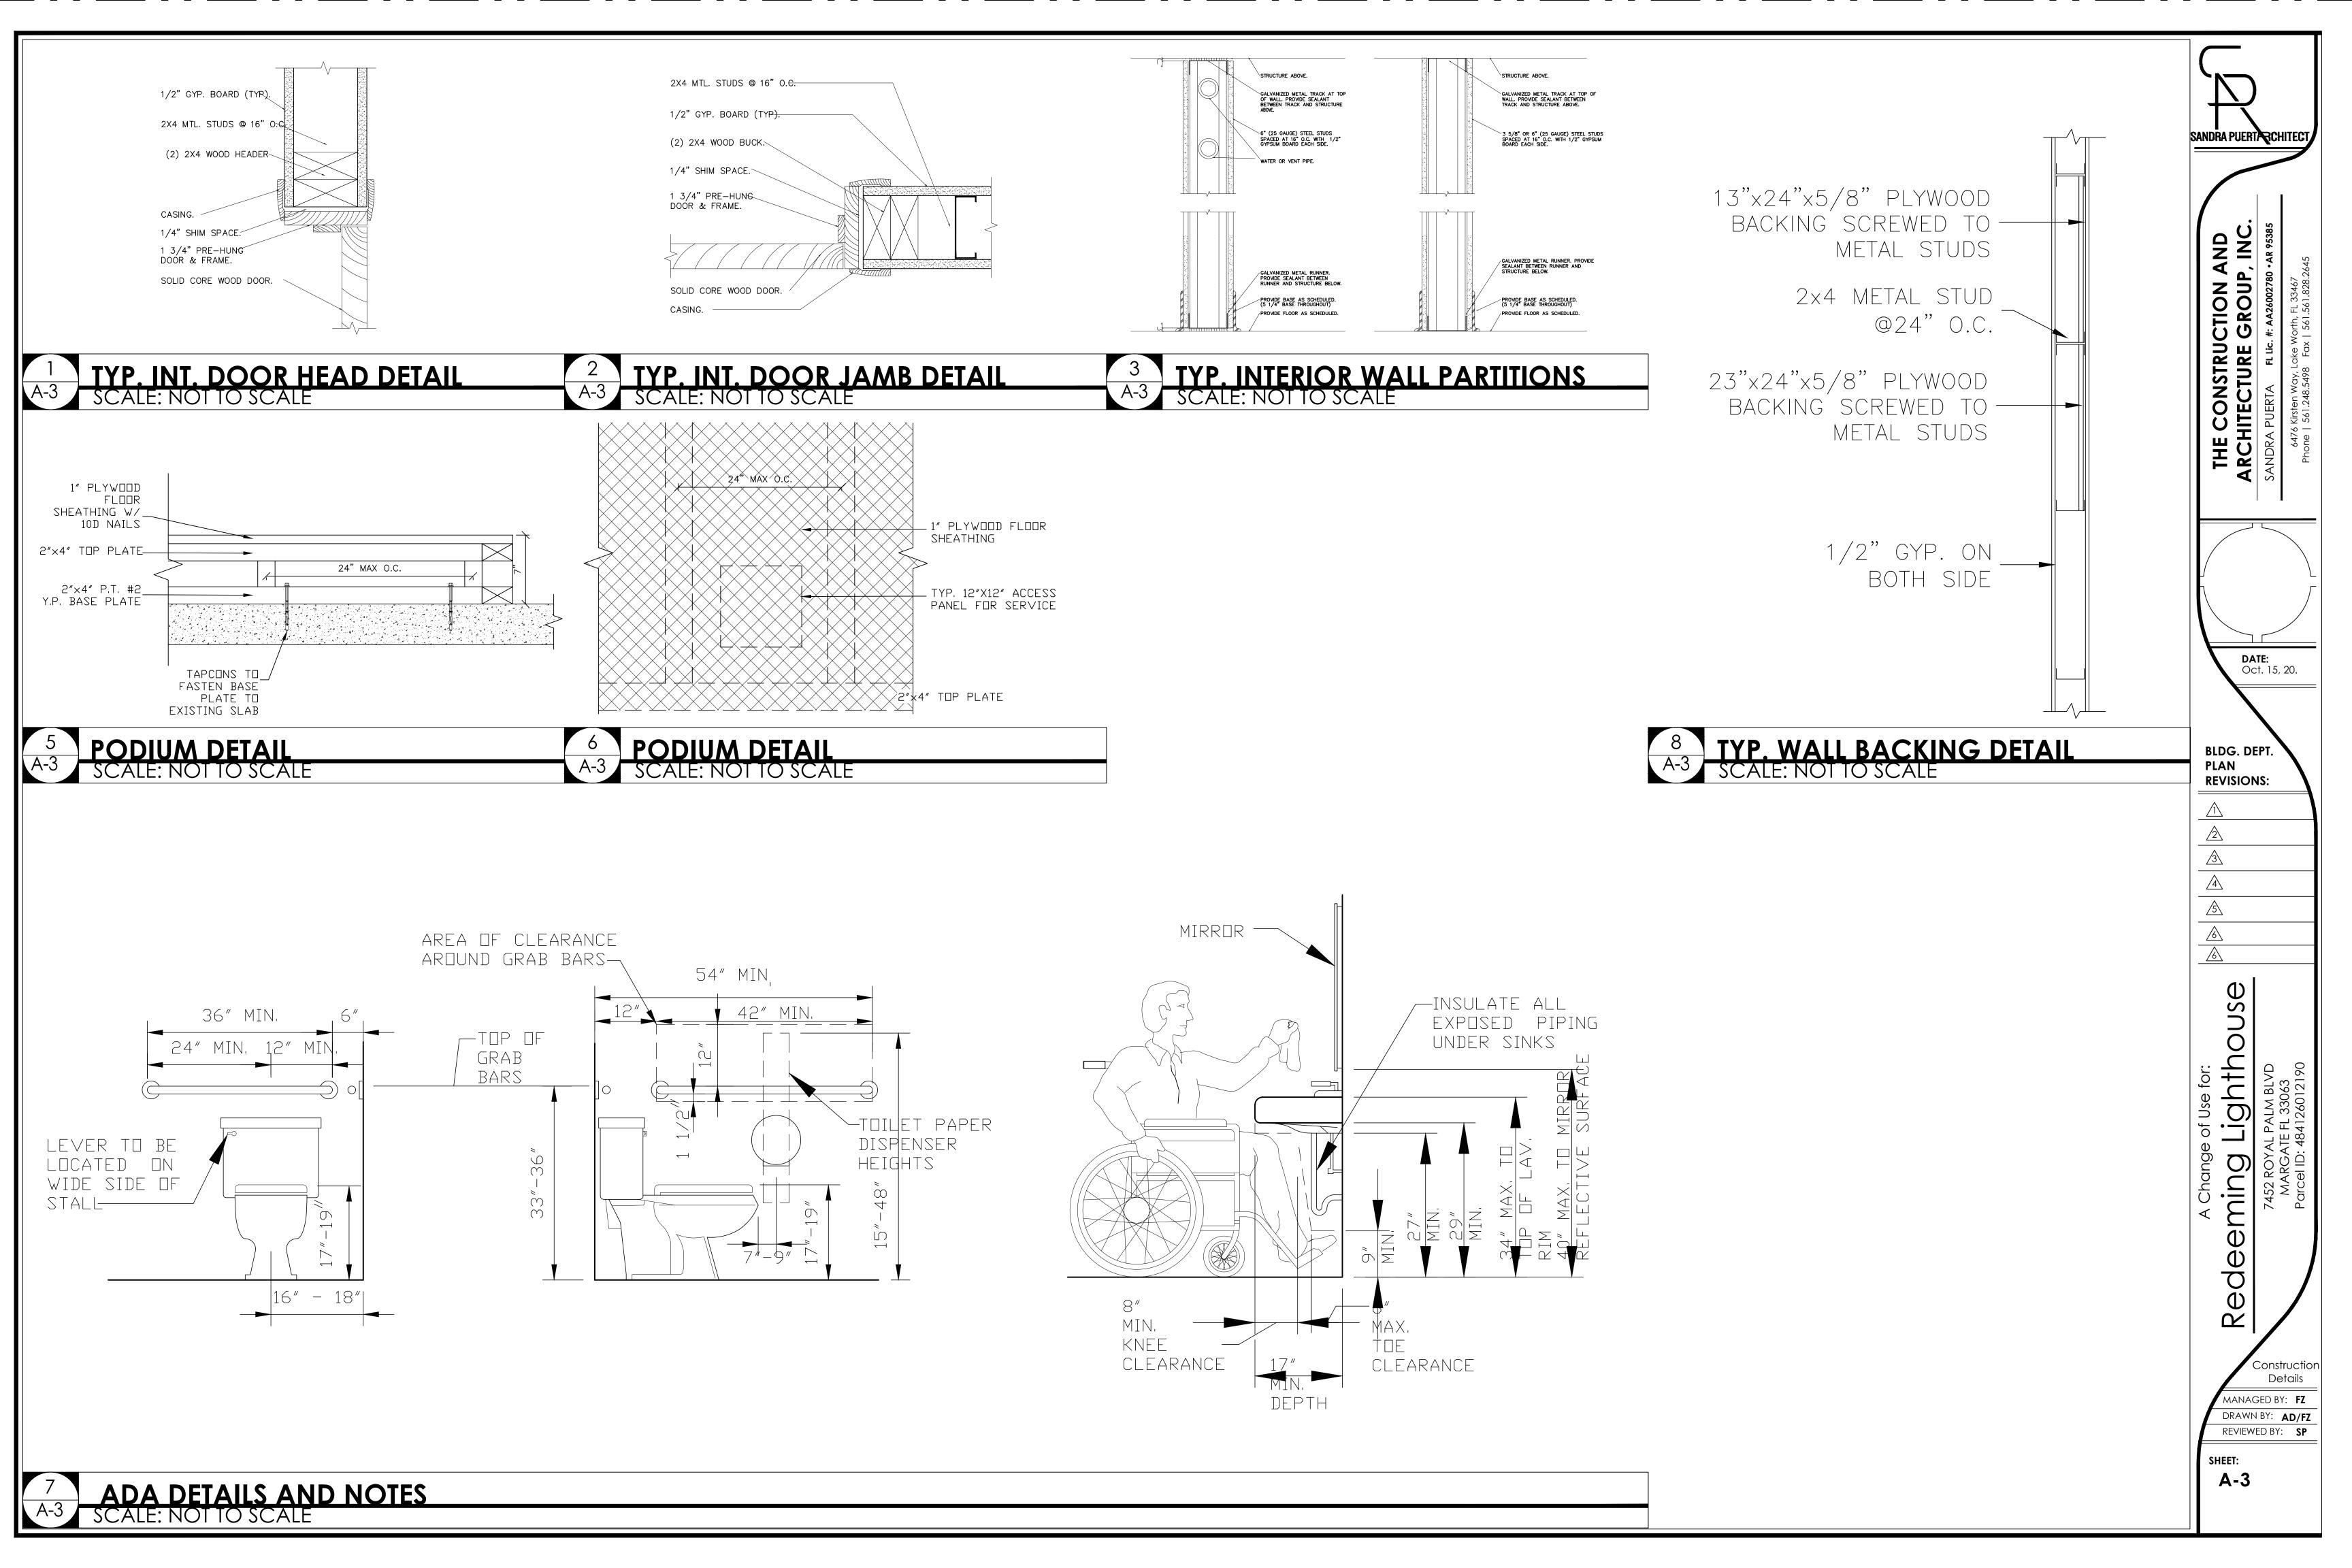

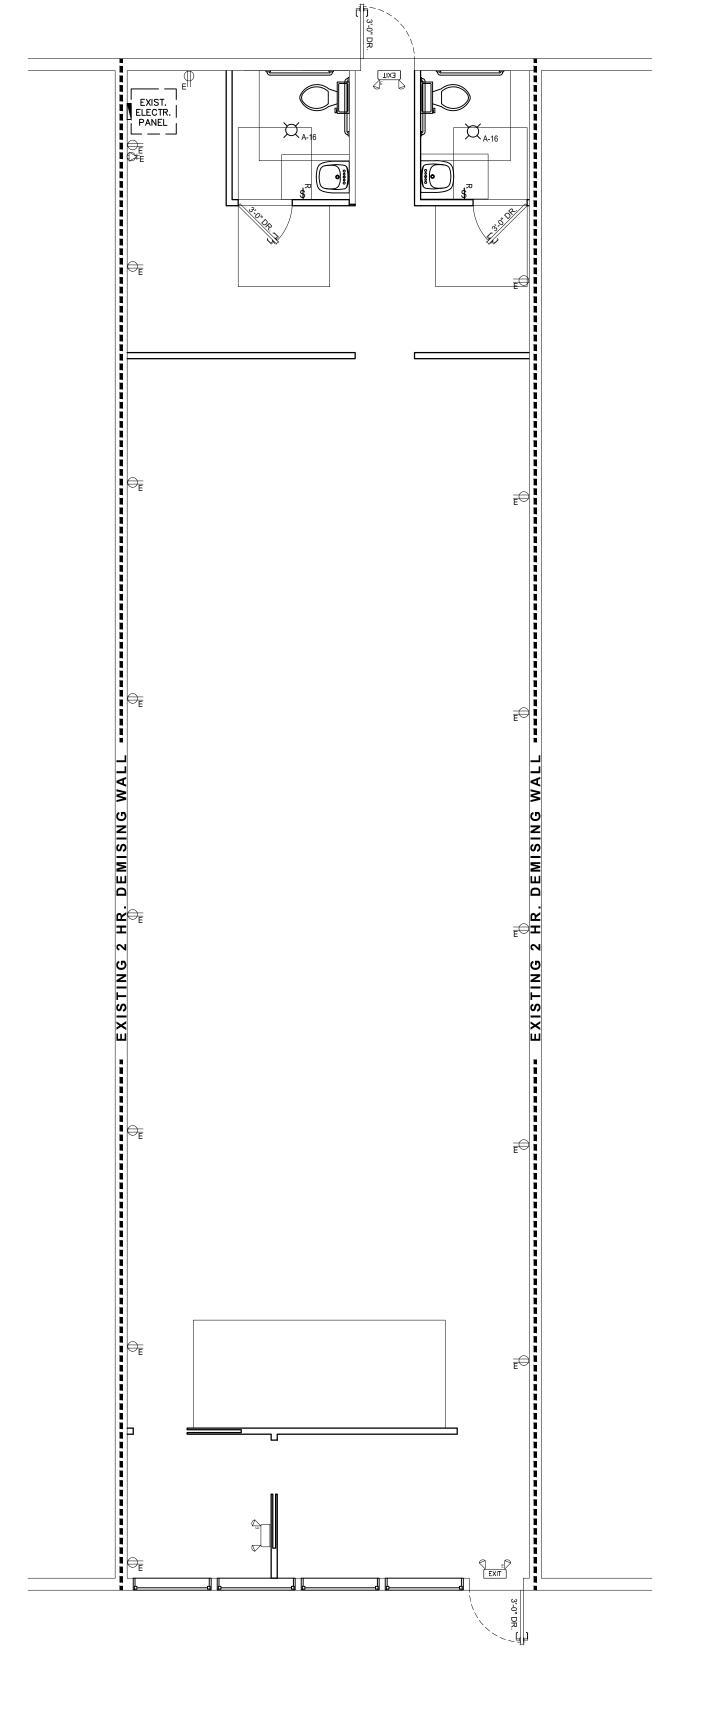

SCALE: 1/4" = 1'-0"

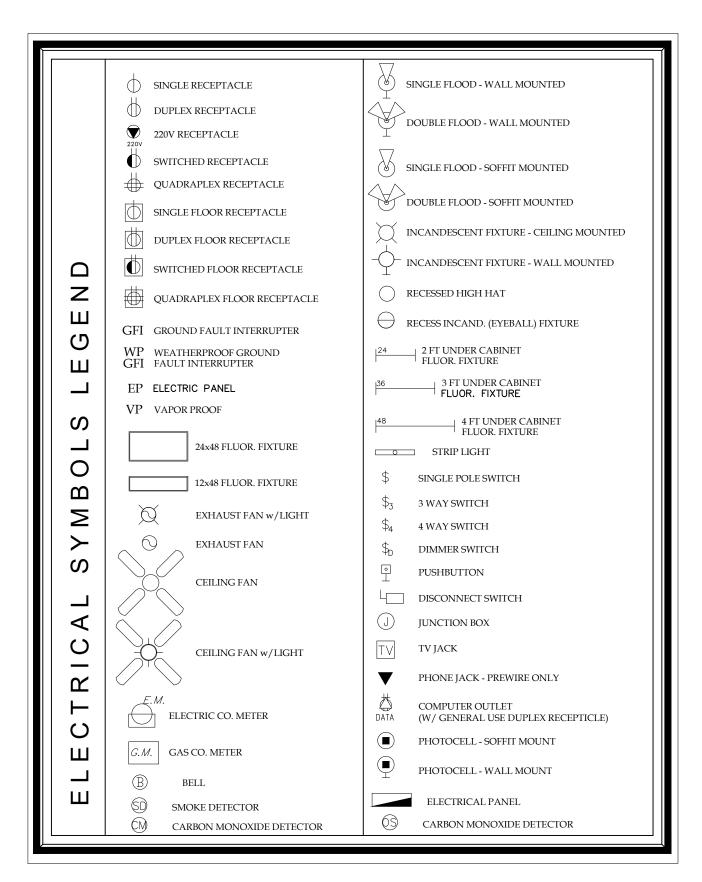

ELECTRICAL FIXTURES LEGEND						
FIXTURE NOTE	DESCRIPTION					
Е	EXISTING - NO CHANGE					
N	INSTALL NEW					
R	RELOCATE					

ELECTRICAL NOTES

. ALL ELECTRICAL WORK SHALL COMPLY WITH THE 2017 FLORIDA BUILDING CODE, THE NATIONAL ELECTRICAL CODE AND ALL LOCAL

2. THE ELECTRICAL SUBCONTRACTOR SHALL BE RESPONSIBLE FOR FULL STARTING WORK. VERIFY ALL EXISTING CONDITIONS AND NOTIFY COORDINATION OF THIS WORK WITH THAT OF THE GENERAL CONTRACTOR AND THE OTHER SUB-CONTRACTORS

3. PROVIDE A GUARANTEE AGAINST DEFECTIVE WORKMANSHIP, MATERIALS AND EQUIPMENT FOR A PERIOD OF ONE YEAR FROM THE DATE OF FINAL ACCEPTANCE BY OWNER.

4. ALL POWER AND CONTROL WIRING SHALL BE BY THE ELECTRICAL SUB-CONTRACTOR.

5. ELECTRICAL SUBCONTRACTOR SHALL BE RESPONSIBLE FOR ALL APPLICABLE FEES TAXES AND PERMITS. WIRING DEVICES SHALL BE U.L. LISTED COMMERCIAL GRADE.

6. ALL CONDUITS SHALL BE MC CABLE EXCEPT AS FOLLOWS: B: PVC MAY BE USED UNDERGROUND WHERE ALLOWED BY

7. THESE PLANS ARE BASED ON AVAILABLE INFORMATION, NOTIFY ARCHITECT/ OWNER OF ANY CONDITIONS WHICH AFFECT PROGRESS 15. ALL T.V. LOCATIONS TO HAVE (2) CAT6 AND (2)RG6 COAXIAL OF CONSTRUCTION.

8. VERIFY ELECTRICAL REQUIREMENTS OF EACH PIECE OF EQUIPMENT PRIOR TO ACTUAL CONNECTION THERE-TO.

9. ESTABLISH FIELD LIAISON WITH PROJECT MANAGER PRIOR TO ARCHITECT / OWNER OF ANY DISCREPANCIES.

10. ELECTRICAL SUBCONTRACTOR SHALL VERIFY LOCATIONS AND CONNECTIONS TO ALL ELECTRICAL EQUIPMENT FURNISHED BY OTHERS, PRIOR TO INSTALLING OUTLETS, CONDUIT STUBS, DROPS, ETC. VERIFY LOCATIONS OF ALL CONTROLS FURNISHED BY OTHERS. INSTALL CONTROLS AND MAKE CONNECTIONS THERETO.


11. ALL SLEEPING ROOM BRANCH CIRCUITS SHALL BE ARC FAULT RECEPTACLE. ALL BATH OUTLETS, KITCHEN AND WITHIN 2' OF ANY SOURCE OF WATER TO BE GFI.

12. TAMPER RESISTANT RECEPTACLE REQUIRED AS PER NEC 406.11 FOR ALL NEW OUTLETS

A: EMT MAY BE USED INDOORS, WHERE NOT SUBJECT TO ABUSE. 13. COMBINATION TYPE BREAKERS ARE REQUIRED FOR ALL SMOKE DETECTORS. PER NEC 210.12B 16.


> 14. ALL PHONE / INTERNET LOCATIONS TO HAVE (2) CAT6 CABLES. ALL T.V. LOCATIONS TO HAVE (2) CAT6 AND (2) RG6 COAXIAL CABLES.

CABLES.

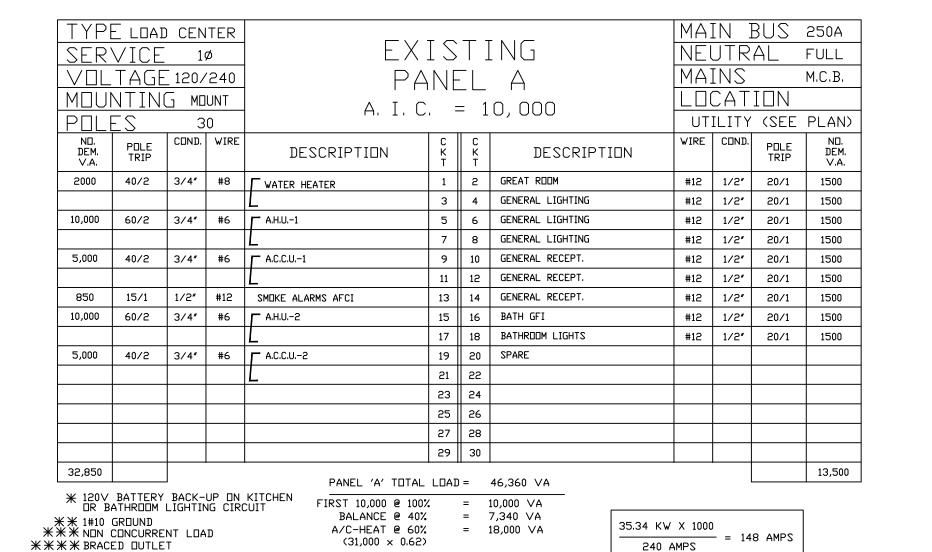

= 36,340 VA

TOTAL LOAD USE

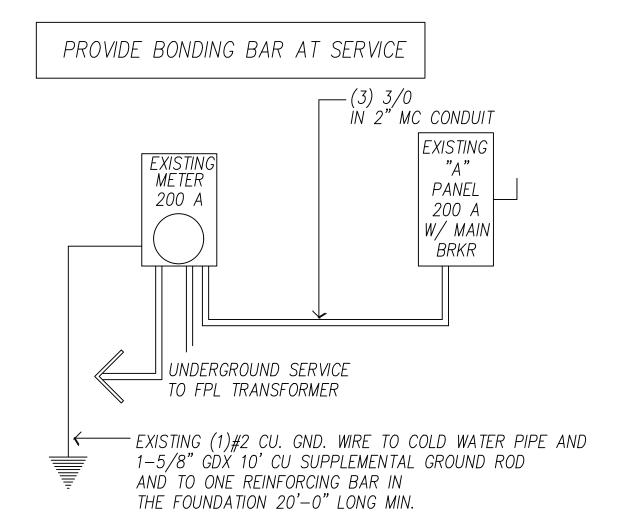

ELECTRICAL RISER DIAGRAM
SCALE: NOT TO SCALE

e of Use for: Lighth ming 7 SHEET:

SANDRA PUERTA CHITECT

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Oct. 15, 20.

BLDG. DEPT. PLAN **REVISIONS:**


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Electrical Plan MANAGED BY: FZ

DRAWN BY: AD/FZ REVIEWED BY: SP

E-1



REFLECTED CEILING/ LIGHTING PLAN SCALE: 1/4" = 1'-0"

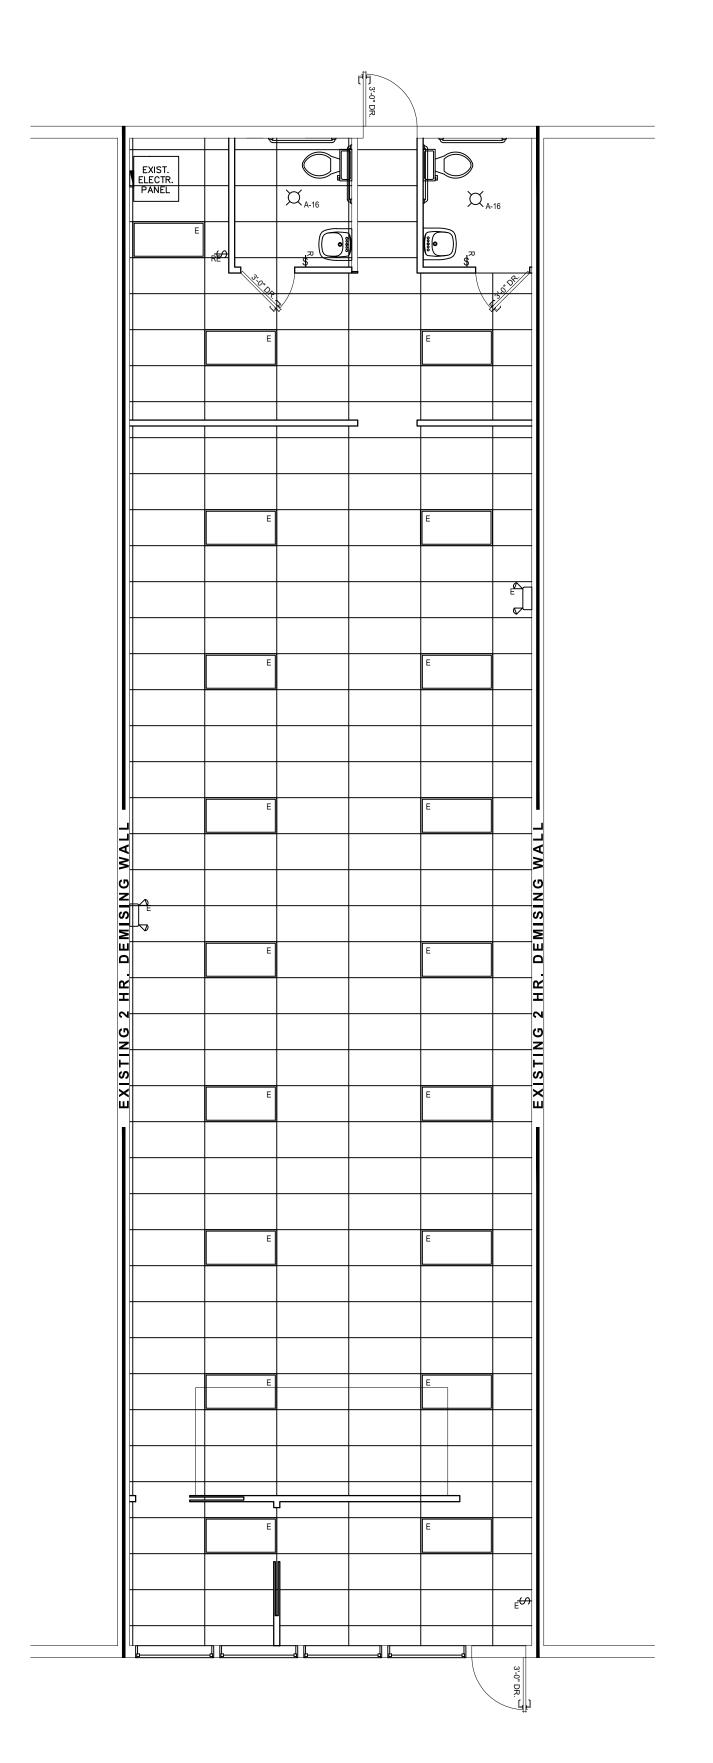

ELECTR	ELECTRICAL FIXTURES LEGEND						
FIXTURE NOTE	DESCRIPTION						
Е	EXISTING - N□ CHANGE						
N	INSTALL NEW						
R	RELOCATE						

		•
SYMBOL		DESCRIPTION
	EGRESS PATH	DENOTES PATH OF EGRESS AND TRAVEL DISTANC
FE	FIRE EXTINGUISHER	FIRE EXTINGUISHER 2A10BC 10 LBS
"K" FE	FIRE EXTINGUISHER	FIRE EXTINGUISHER NEW "K" TYPE
#	KEY NOTE	SEE EGRESS LIFE SAFETY NOTES
	FMEDGENIGY	

	EGRESS	LIFE SAFETY LEGEND
SYMBOL		DESCRIPTION
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#	KEY NOTE	SEE EGRESS LIFE SAFETY NOTES
	EMERGENCY LIGHTS / EXIT SIGN	SEE EGRESS LIFE SAFETY NOTES

ELECTRICAL NOTES

1. ALL ELECTRICAL WORK SHALL COMPLY WITH THE 2017 FLORIDA BUILDING CODE, THE NATIONAL ELECTRICAL CODE AND ALL LOCAL PRIOR TO ACTUAL CONNECTION THERE-TO. CODES.

2. THE ELECTRICAL SUBCONTRACTOR SHALL BE RESPONSIBLE FOR FULL STARTING WORK, VERIFY ALL EXISTING CONDITIONS AND NOTIFY COORDINATION OF THIS WORK WITH THAT OF THE GENERAL CONTRACTOR AND THE OTHER SUB-CONTRACTORS.

3. PROVIDE A GUARANTEE AGAINST DEFECTIVE WORKMANSHIP, MATERIALS AND EQUIPMENT FOR A PERIOD OF ONE YEAR FROM THE DATE OF FINAL ACCEPTANCE BY OWNER.

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7. THESE PLANS ARE BASED ON AVAILABLE INFORMATION. NOTIFY ARCHITECT/ OWNER OF ANY CONDITIONS WHICH AFFECT PROGRESS 15. ALL T.V. LOCATIONS TO HAVE (2) CAT6 AND (2) RG6 COAXIAL OF CONSTRUCTION.

8. VERIFY ELECTRICAL REQUIREMENTS OF EACH PIECE OF EQUIPMENT

ARCHITECT / OWNER OF ANY DISCREPANCIES.

9. ESTABLISH FIELD LIAISON WITH PROJECT MANAGER PRIOR TO

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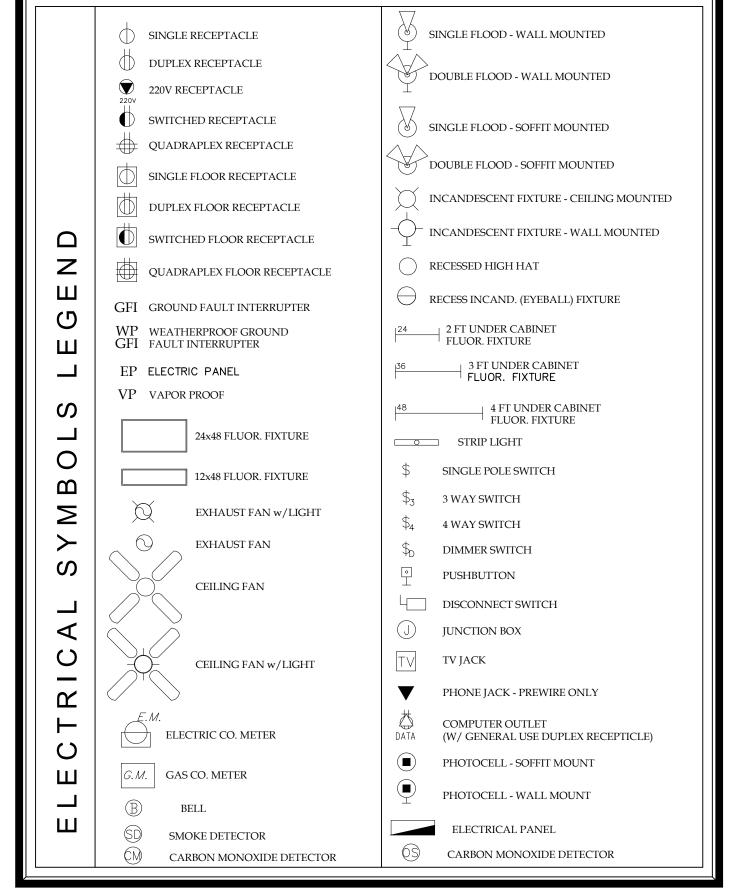
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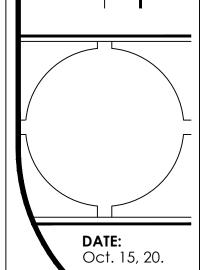
CABLES.





SANDRA PUERTA RCHITECT

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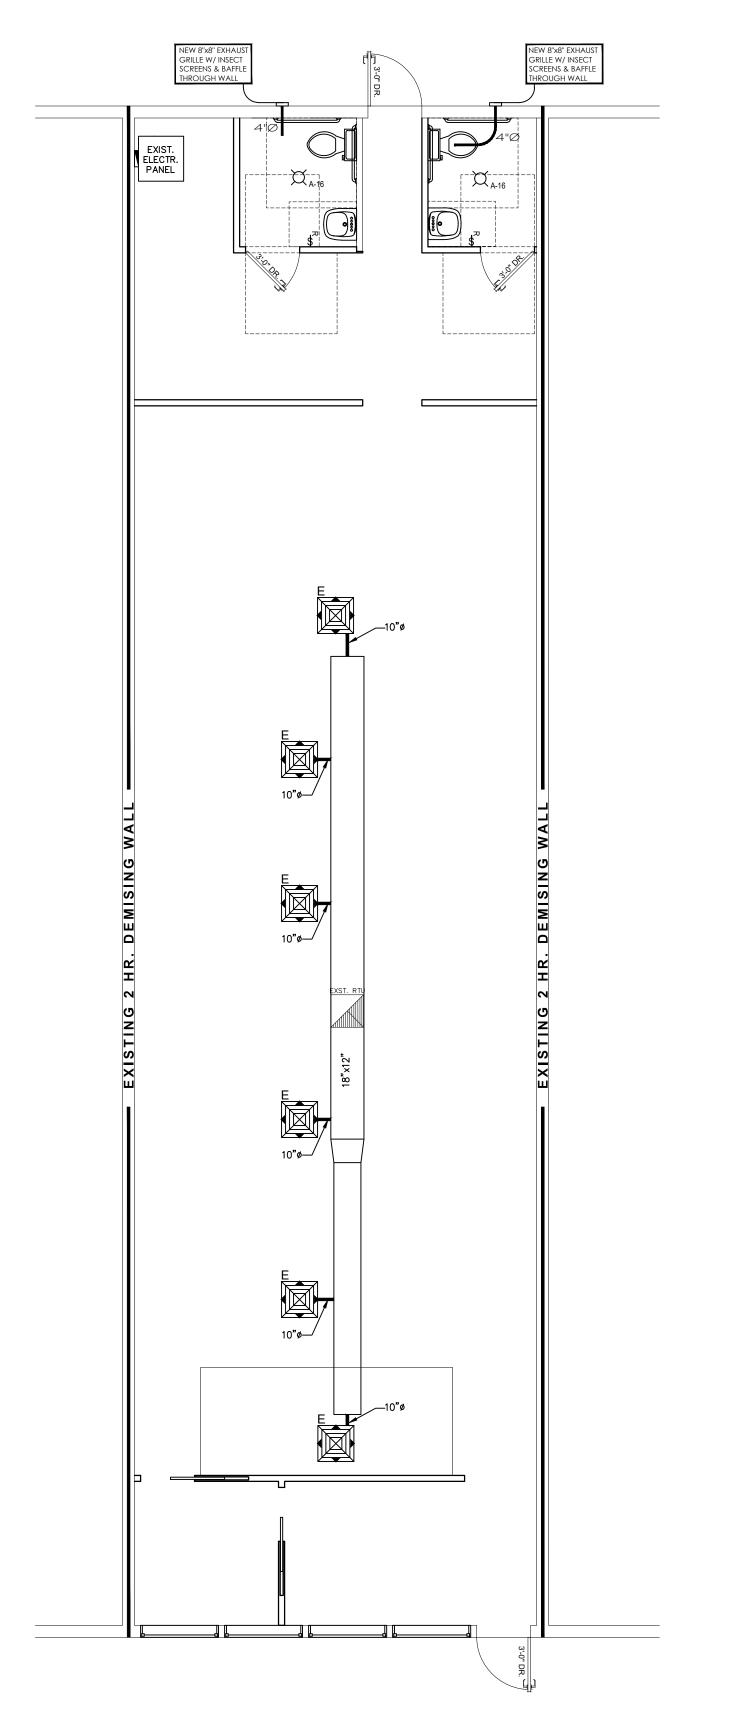
BLDG. DEPT. PLAN **REVISIONS:**

Reflected Ceiling Plan

MANAGED BY: **FZ** DRAWN BY: AD/FZ REVIEWED BY: SP

SHEET: **E-2**

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MECHANICAL PLAN SCALE: 3/16" = 1'-0"

MECHANICAL PLAN LEGEND

ALL SUPPLY GRILL
SIZE 24X24 LAYIN

RETURN AIR DUCT
CEILING SUPPLY AIR

FLEX DUCT (R-6)

4" Ø FLEX DUCT
RIGID DUCT (R-6)


AS INDICATED ON PLANS EXHAUST FAN


AIR CONDITIONING NOTES

- 1. HVAC SUBCONTRACTOR SHALL PROVIDE ALL LABOR, MATERIALS, TOOLS AND EQUIPMENT TO INSTALL A COMPLETE AND OPERATING A/C SYSTEM.
- 2. HVAC SUBCONTRACTOR TO PROVIDE ALL REQUIRED HVAC PERMITS.
- 3. HVAC SUBCONTRACTOR SHALL PROVIDE EQUIPMENT AS SCHEDULED ON PLANS.
- INSTALLATION SHALL BE IN ACCORDANCE WITH 2014 FLORIDA BUILDING CODE MECHANICAL
- 5. DUCTBOARD DUCTWORK SHALL BE FABRICATED FROM 1.5" JOHNS-MANVILLE J-M MICROAIRE SD/MF FIBERGLASS DUCTBOARD AND INSTALLED PER MANUFACTURER'S AND SMACNA RECOMMENDATIONS. FLEXIBLE DUCT SHALL BE THERMAFLEX M-KE OR EQUAL. DUCT SHALL BE U.L. LISTED.
- . ALL AIR DEVICES SHALL BE OF ALUMINUM CONSTRUCTION. TITUS , METALAIRE OR AS APPROVED BY ARCHITECT.
- 7. ALL VENTILATION DUCTWORK SHALL BE GALVANIZED SHEET METAL.
- . HVAC SUBCONTRACTOR SHALL TEST AND BALANCE THE AIR QUANTITIES TO THOSE INDICATED ON PLANS. PROVIDE
- A T&B REPORT IN ACCORDANCE WITH AIR BALANCE COUNCIL STANDARDS.

 9. HVAC SUBCONTRACTOR SHALL PROVIDE ALL CONTRACTORS, RELAYS AND THERMOSTATS. ELECTRICAL CONTRACTOR SHALL PROVIDE ALL SWITCHES. THERMOSTATS SHALL BE APPROVED BY EQUIPMENT MANUFACTURER WITH HEAT/COOL/OFF & FAN AUTO/ON SETTING.
- 10. CONTROL TO BE PROVIDED BY THE ELECTRICAL CONTRACTOR.
- 11. THE HVAC SUBCONTRACTOR SHALL PROVIDE A WRITTEN GUARANTEE THAT SHALL WARRANT ALL WORKMANSHIP FOR A PERIOD OF ONE YEAR FROM DATE OF FINAL ACCEPTANCE. ANY WORK PERFORMED DURING THE FIRST YEAR SHALL BE PERFORMED AT NO COST TO OWNER. COMPRESSORS SHALL HAVE 5 YEAR WARRANTY (LABOR & MATERIALS).
- 12. ALL WORK SHALL BE COORDINATED WITH OTHER TRADES TO AVOID DELAYS WHICH MAY DELAY PROGRESS OF CONSTRUCTION.
- 13. FILTERS SHALL BE DISPOSABLE TYPE WITH INITIAL SHARE WEIGHT ARRESTANCE OF 10%. AND A CLEAN PRESSURE DROP OF .15. PROVIDE 2 SETS.
- 14. HVAC SUBCONTRACTOR SHALL PROVIDE ALL NECESSARY OFFSETS BENDS AND TRANSITIONS REQUIRED TO PROVIDE A COMPLETE AND OPERATING A/C SYSTEM AT NO ADDITIONAL COST TO OWNER.
- 15. PIPE ROOFTOP PACKAGE UNIT CONDENSATE DRAIN TO ROOFDRAIN OR GUTTER. VERIFY IN FIELD.
- 16. 2'x2' LAY-IN DIFFUSERS SHALL BE "TITUS" TMS-AA OR EQUAL (UNLESS NOTED)
- 17. RETURN GRILLES SHALL BE "TITUS" 4-FLOG FILTER BACK. UNLESS NOTED OTHERWISE.
- 18. SIDEWALL GRILLES SHALL BE "TITUS" 271 SERIES. UNLESS NOTED OTHERWISE.
- 19. ALL ZONES WITH A COMBINED SYSTEM AIR FLOW OF 2000 CFM OF ABOVE, SHALL HAVE SMOKE DETECTOR IN SUPPLY AIR DUCT. DUCT DETECTORS SHALL BE INTERLOCKED AND BE CONNECTED TO AN AUDIBLE VISUAL TEST PAD.

 WHERE ADDITIONAL UNITS ARE ADDED TO A ZONE TO EXCEED THE 2000 CFM, DETECTORS SHALL BE ADDED TO EXISTING UNITS.

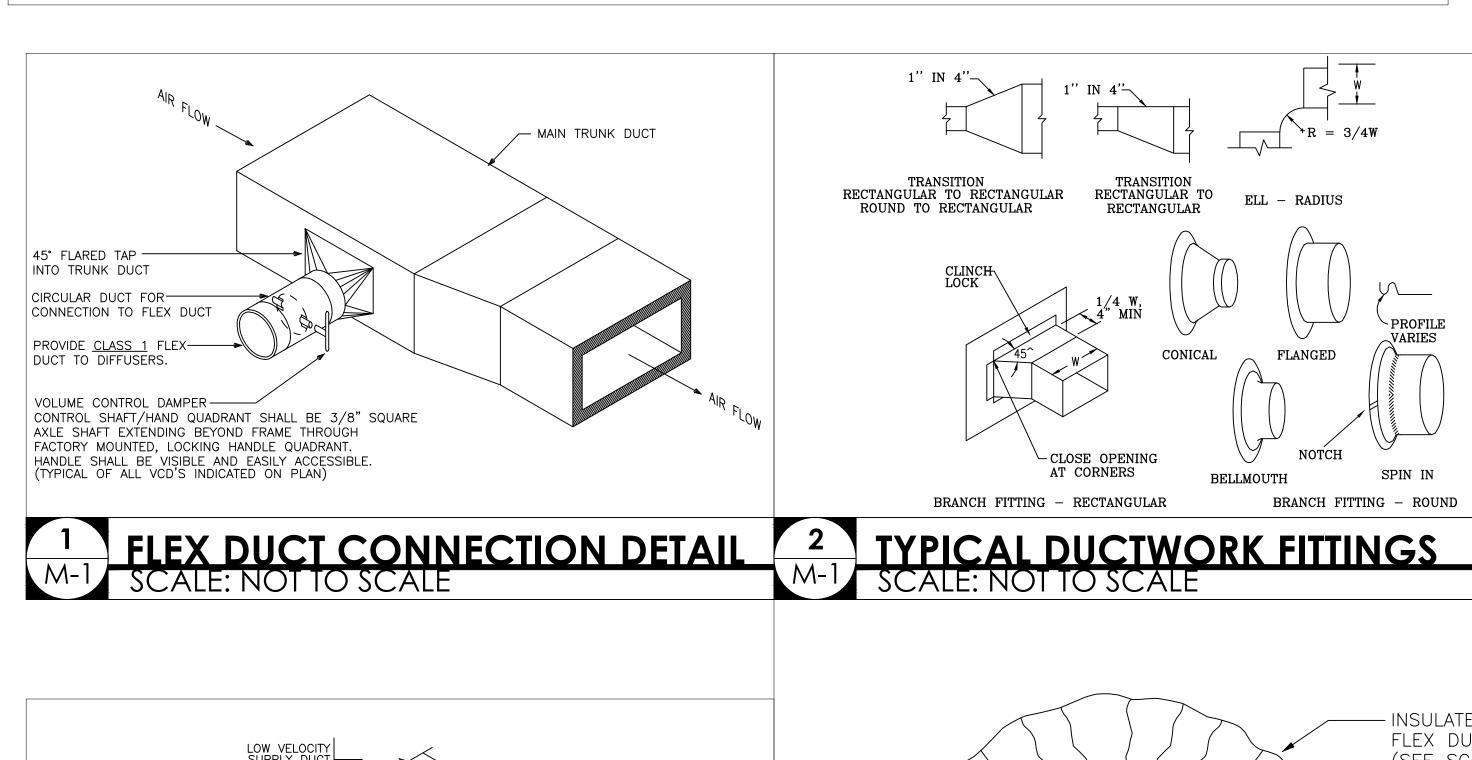

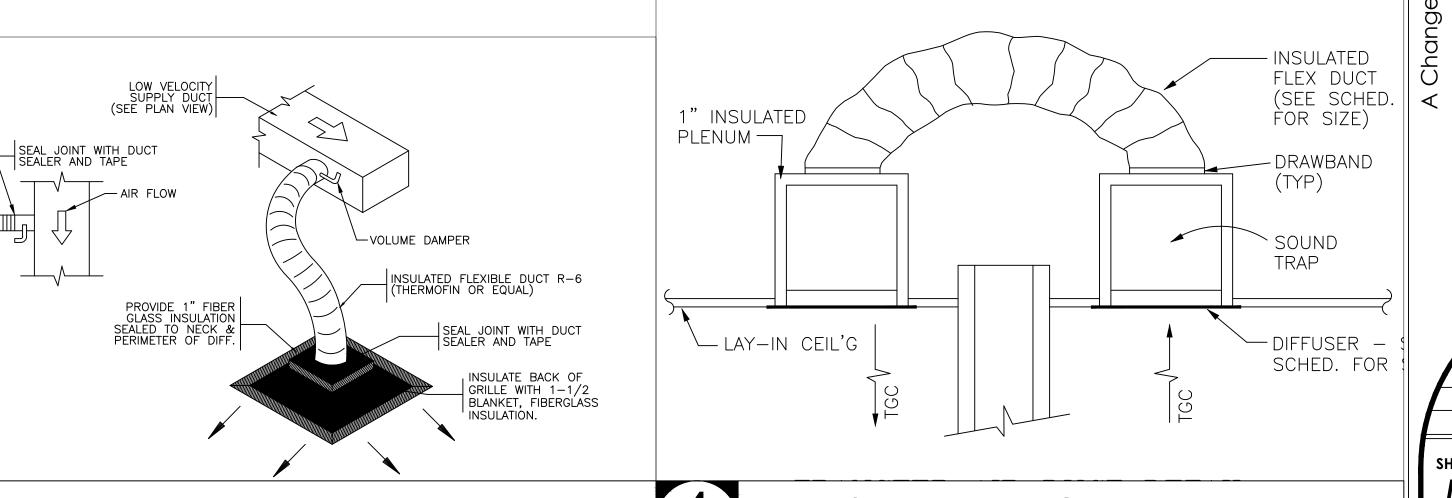

FLEX DUCT CONNECTION DETAIL
SCALE: NOT TO SCALE

4
TRANSFER AIR DUCT DETAIL
M-1
SCALE: NOT TO SCALE

SANDRA PUERTA RICHITECT

ROUP, INC.
A26002780 • AR 95385
FL 33467

CHITECTURE GROUI

ORA PUERTA FL Lic. #: AA2600278

6476 Kirsten Way, Lake Worth, FL 33467

DATE: Oct. 15, 20.

BLDG. DEPT.
PLAN
REVISIONS:

Use for:

3hthouse


ning Lighth 7452 ROYAL PALM BLVD MARGATE FL 33063


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> Mechanical Plans and Notes ANAGED BY: FZ

MANAGED BY: FZ
DRAWN BY: AD/FZ
REVIEWED BY: SP


SHEET: **M-1**



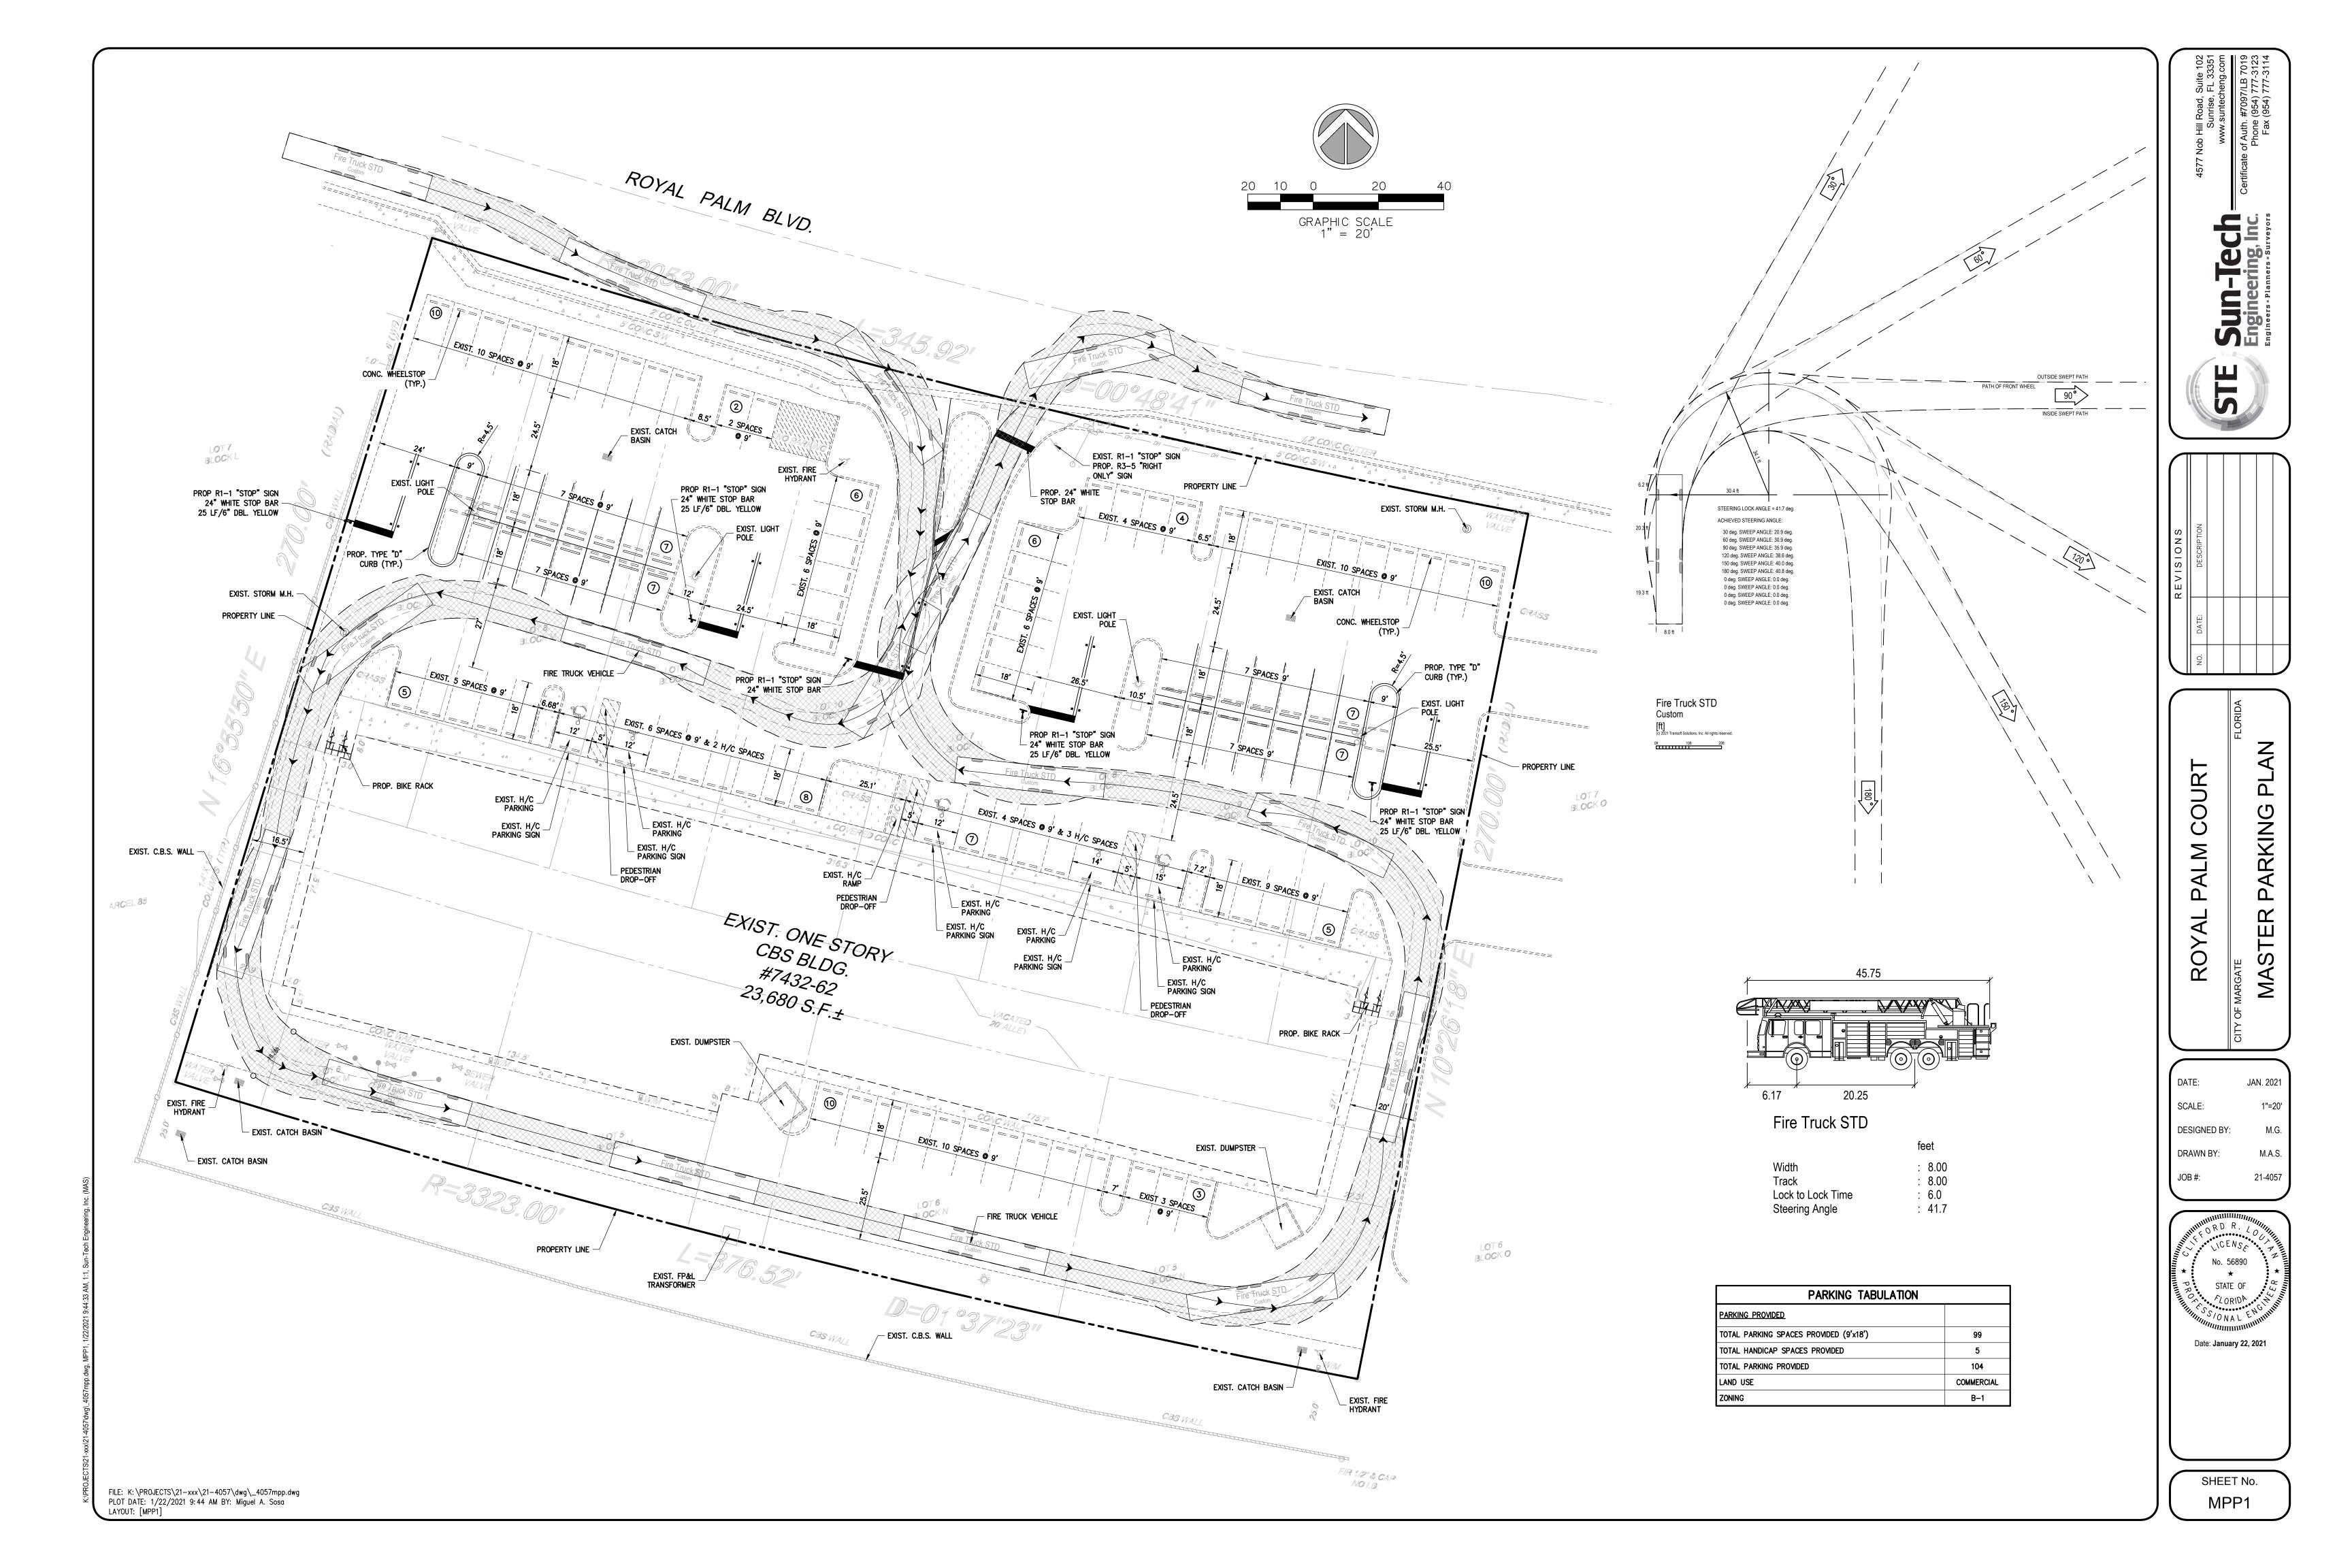

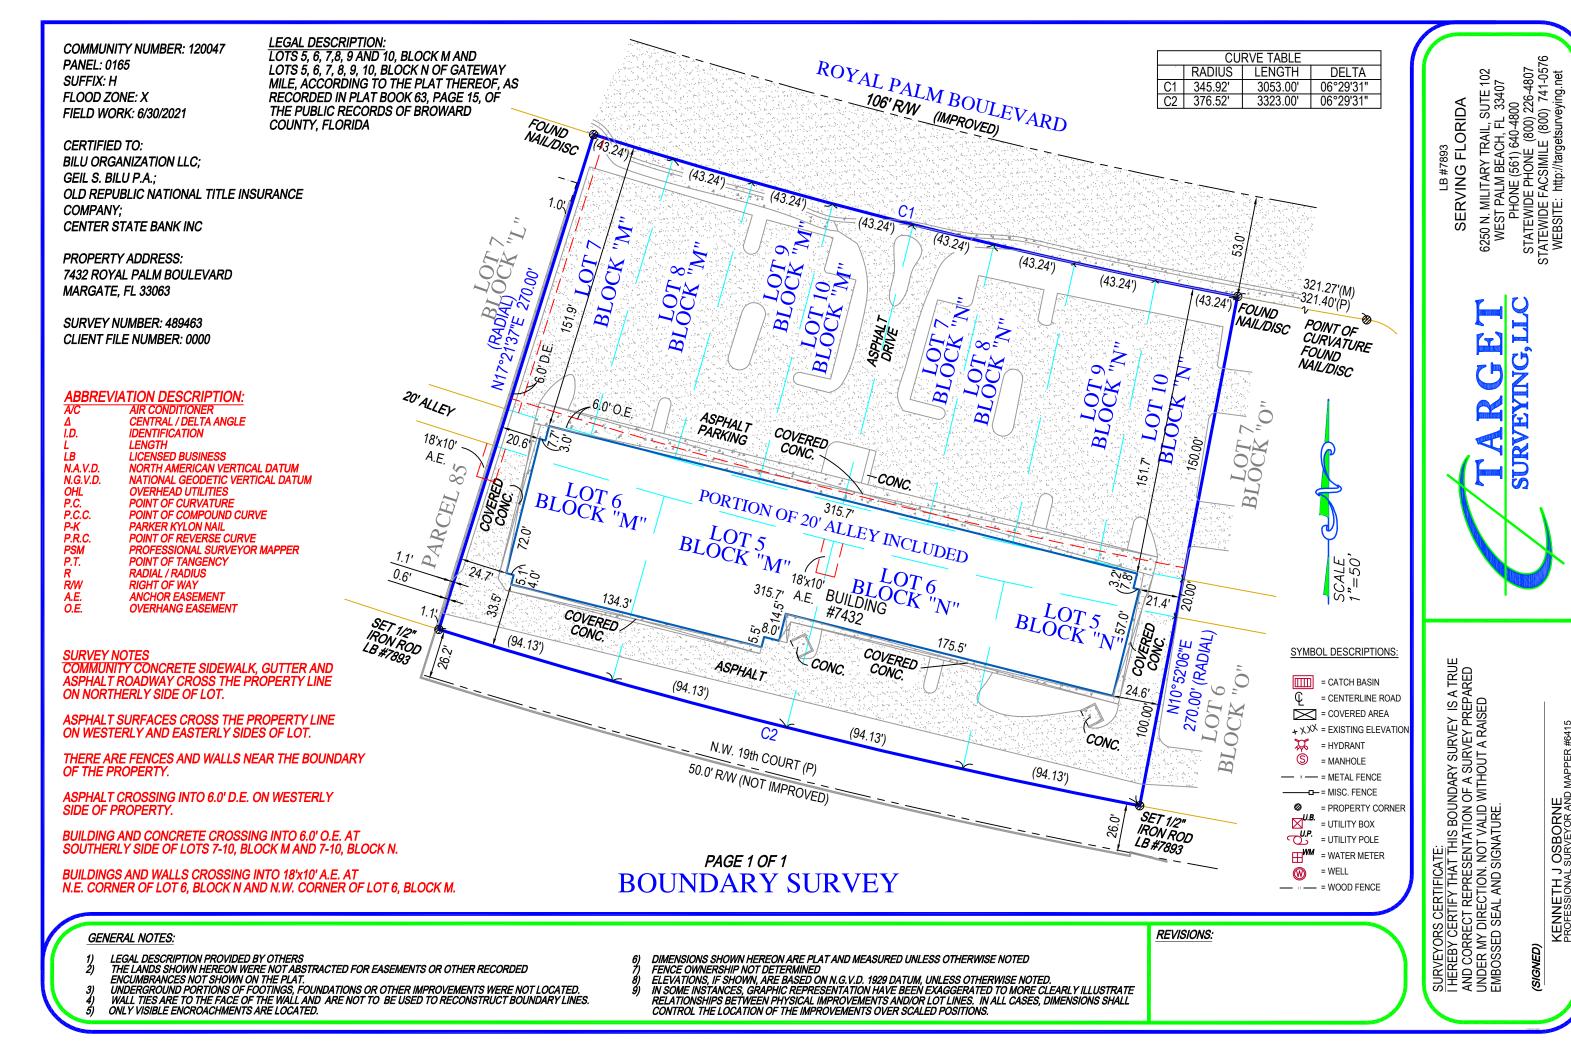KENNETH J OSBORNE PROFESSIONAL SURVEYOR AND MAPPER #6415

EXIL

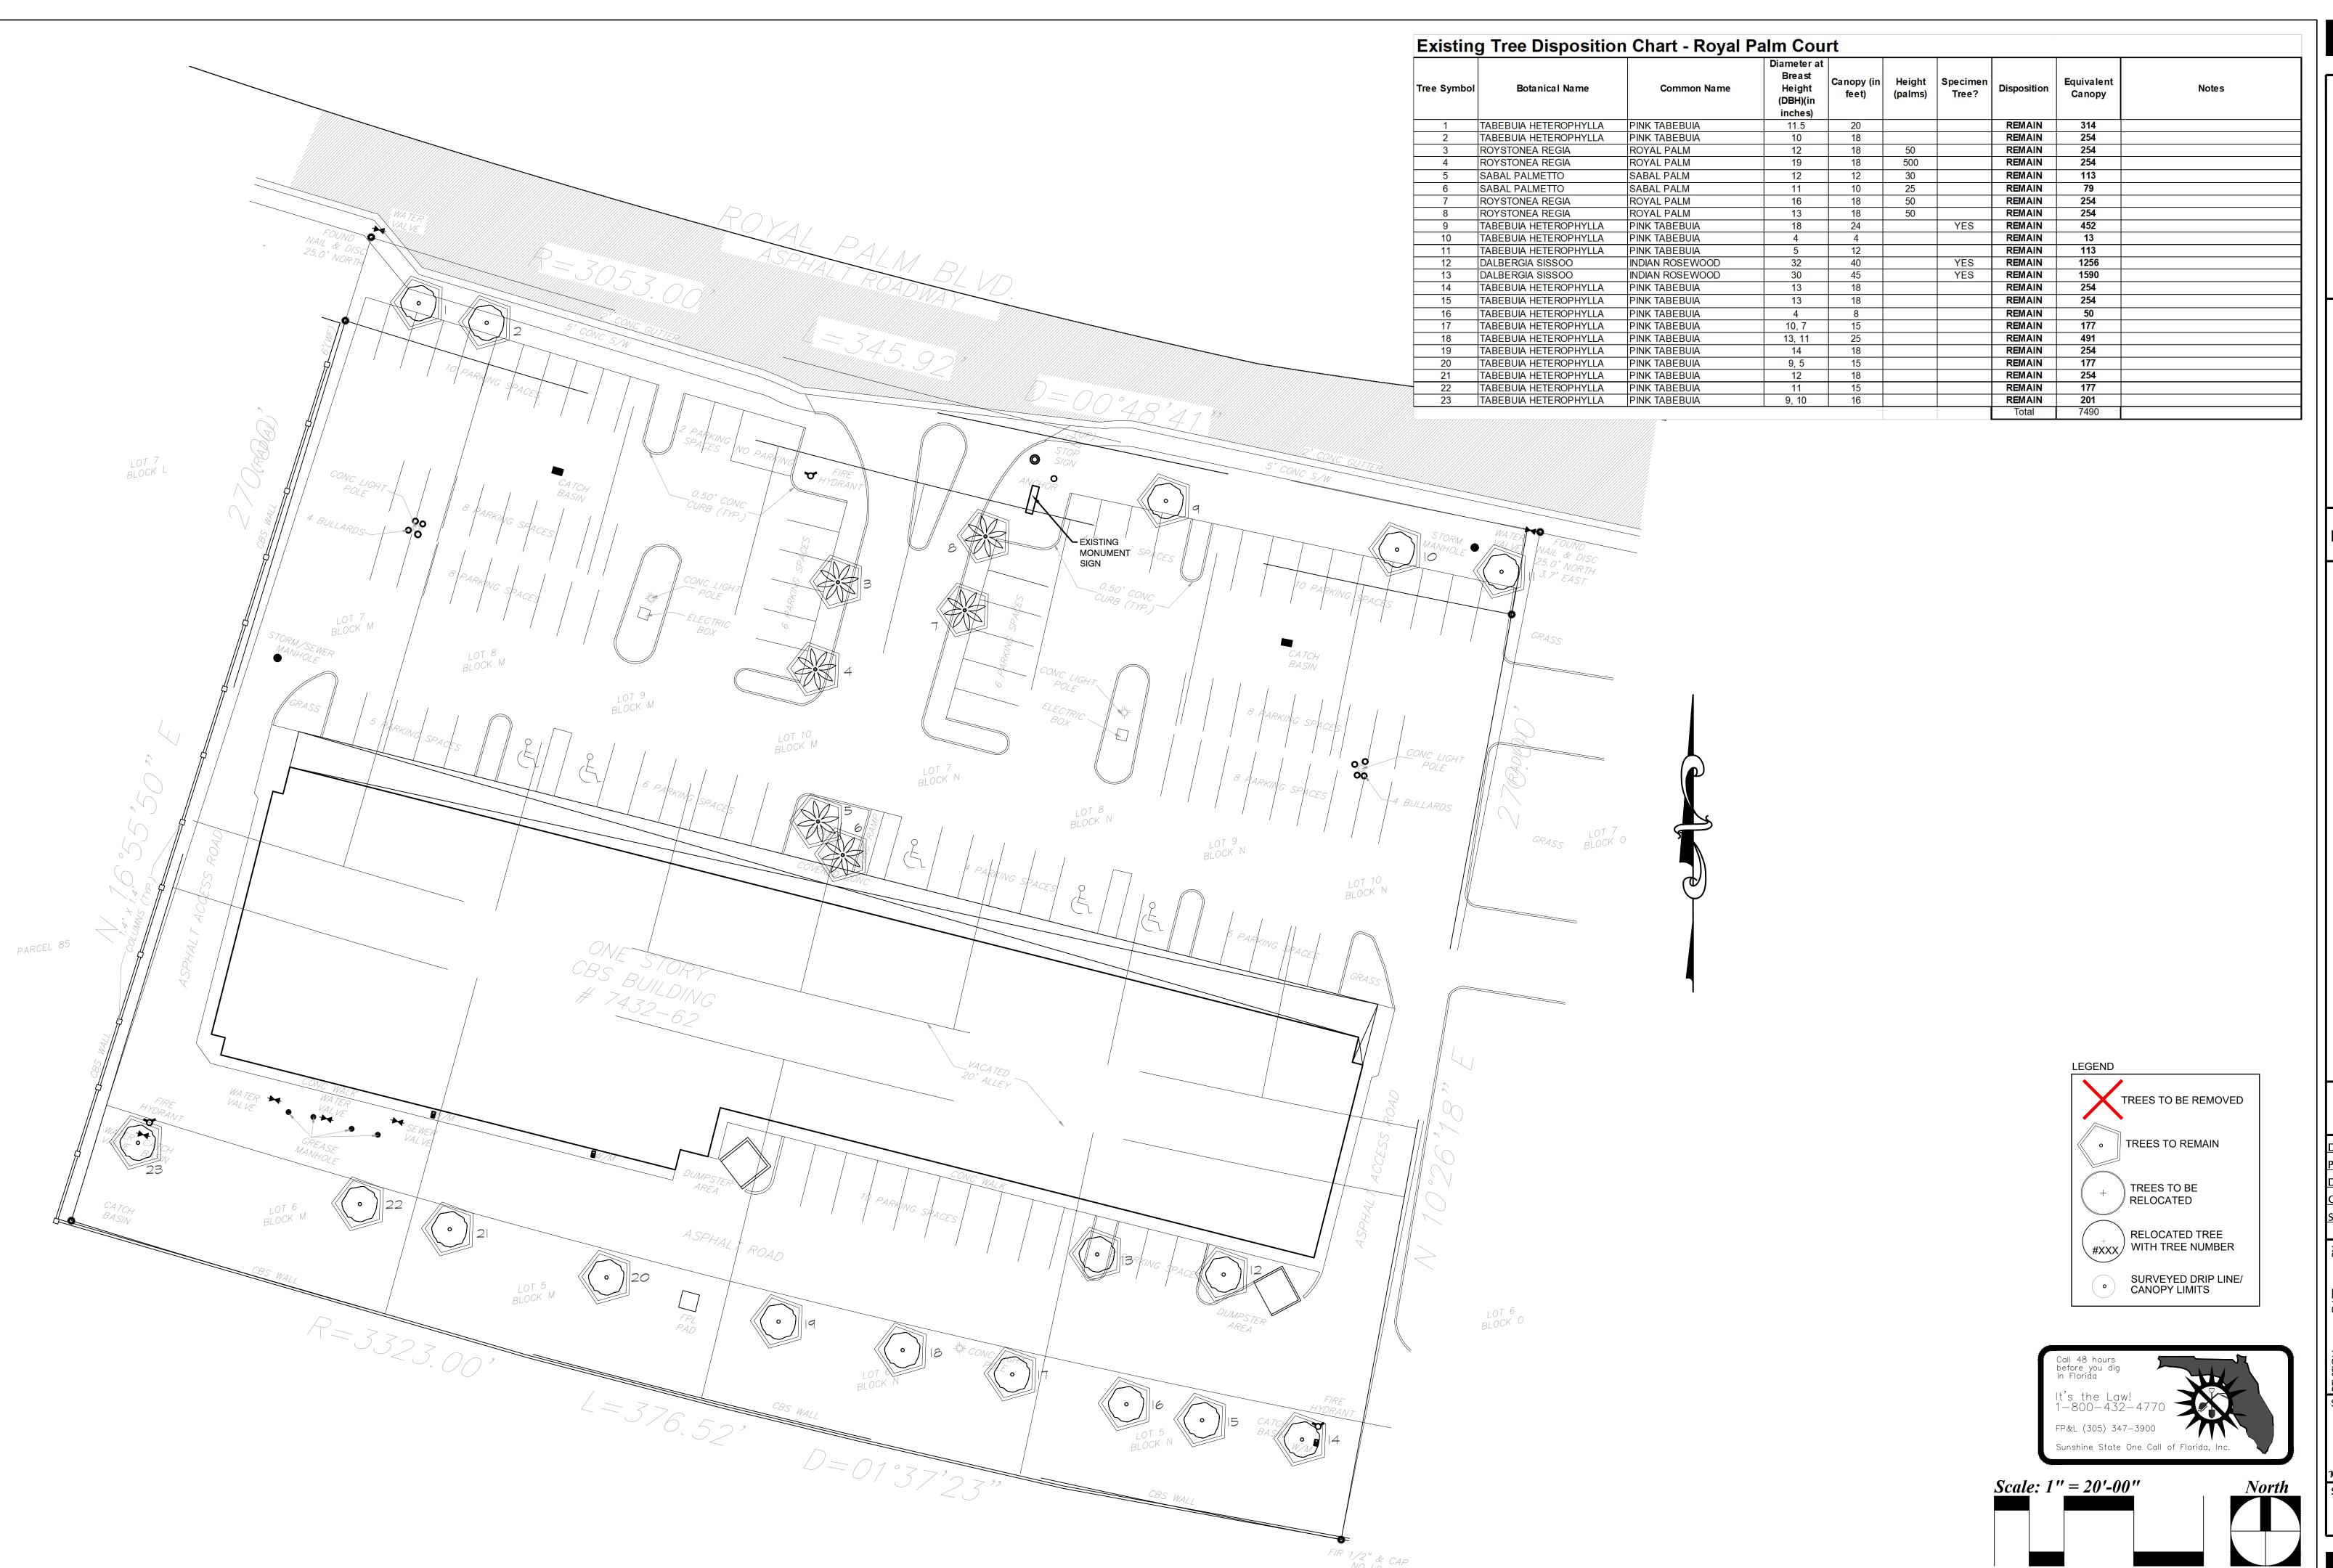

ECOLOGICAL / BNVRONMBYTAL LAND PLANNING LAND USE ANALYSIS LANDSCAPE ARCHTECTURE 888 SOUTH ANDREWS ANDLE, SUITE 303 FORT LANDROME, R. 33316 (PH) (954) 524-3722

PERMIT PLANS

ROYAL PALM COURT
Margate, Florida

TREE
DISPOSITION
PLAN
DATE: 10/22/2020

DATE: 10/22/2020
PROJECT #: 2022
DRAWN BY: HY
CHECKED BY: JH

SCALE: 1″=20′

SEVISION: DATE: I


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SHEET NUMBER:

LA-1





PERMIT PLANS

PAI **ROYAL**

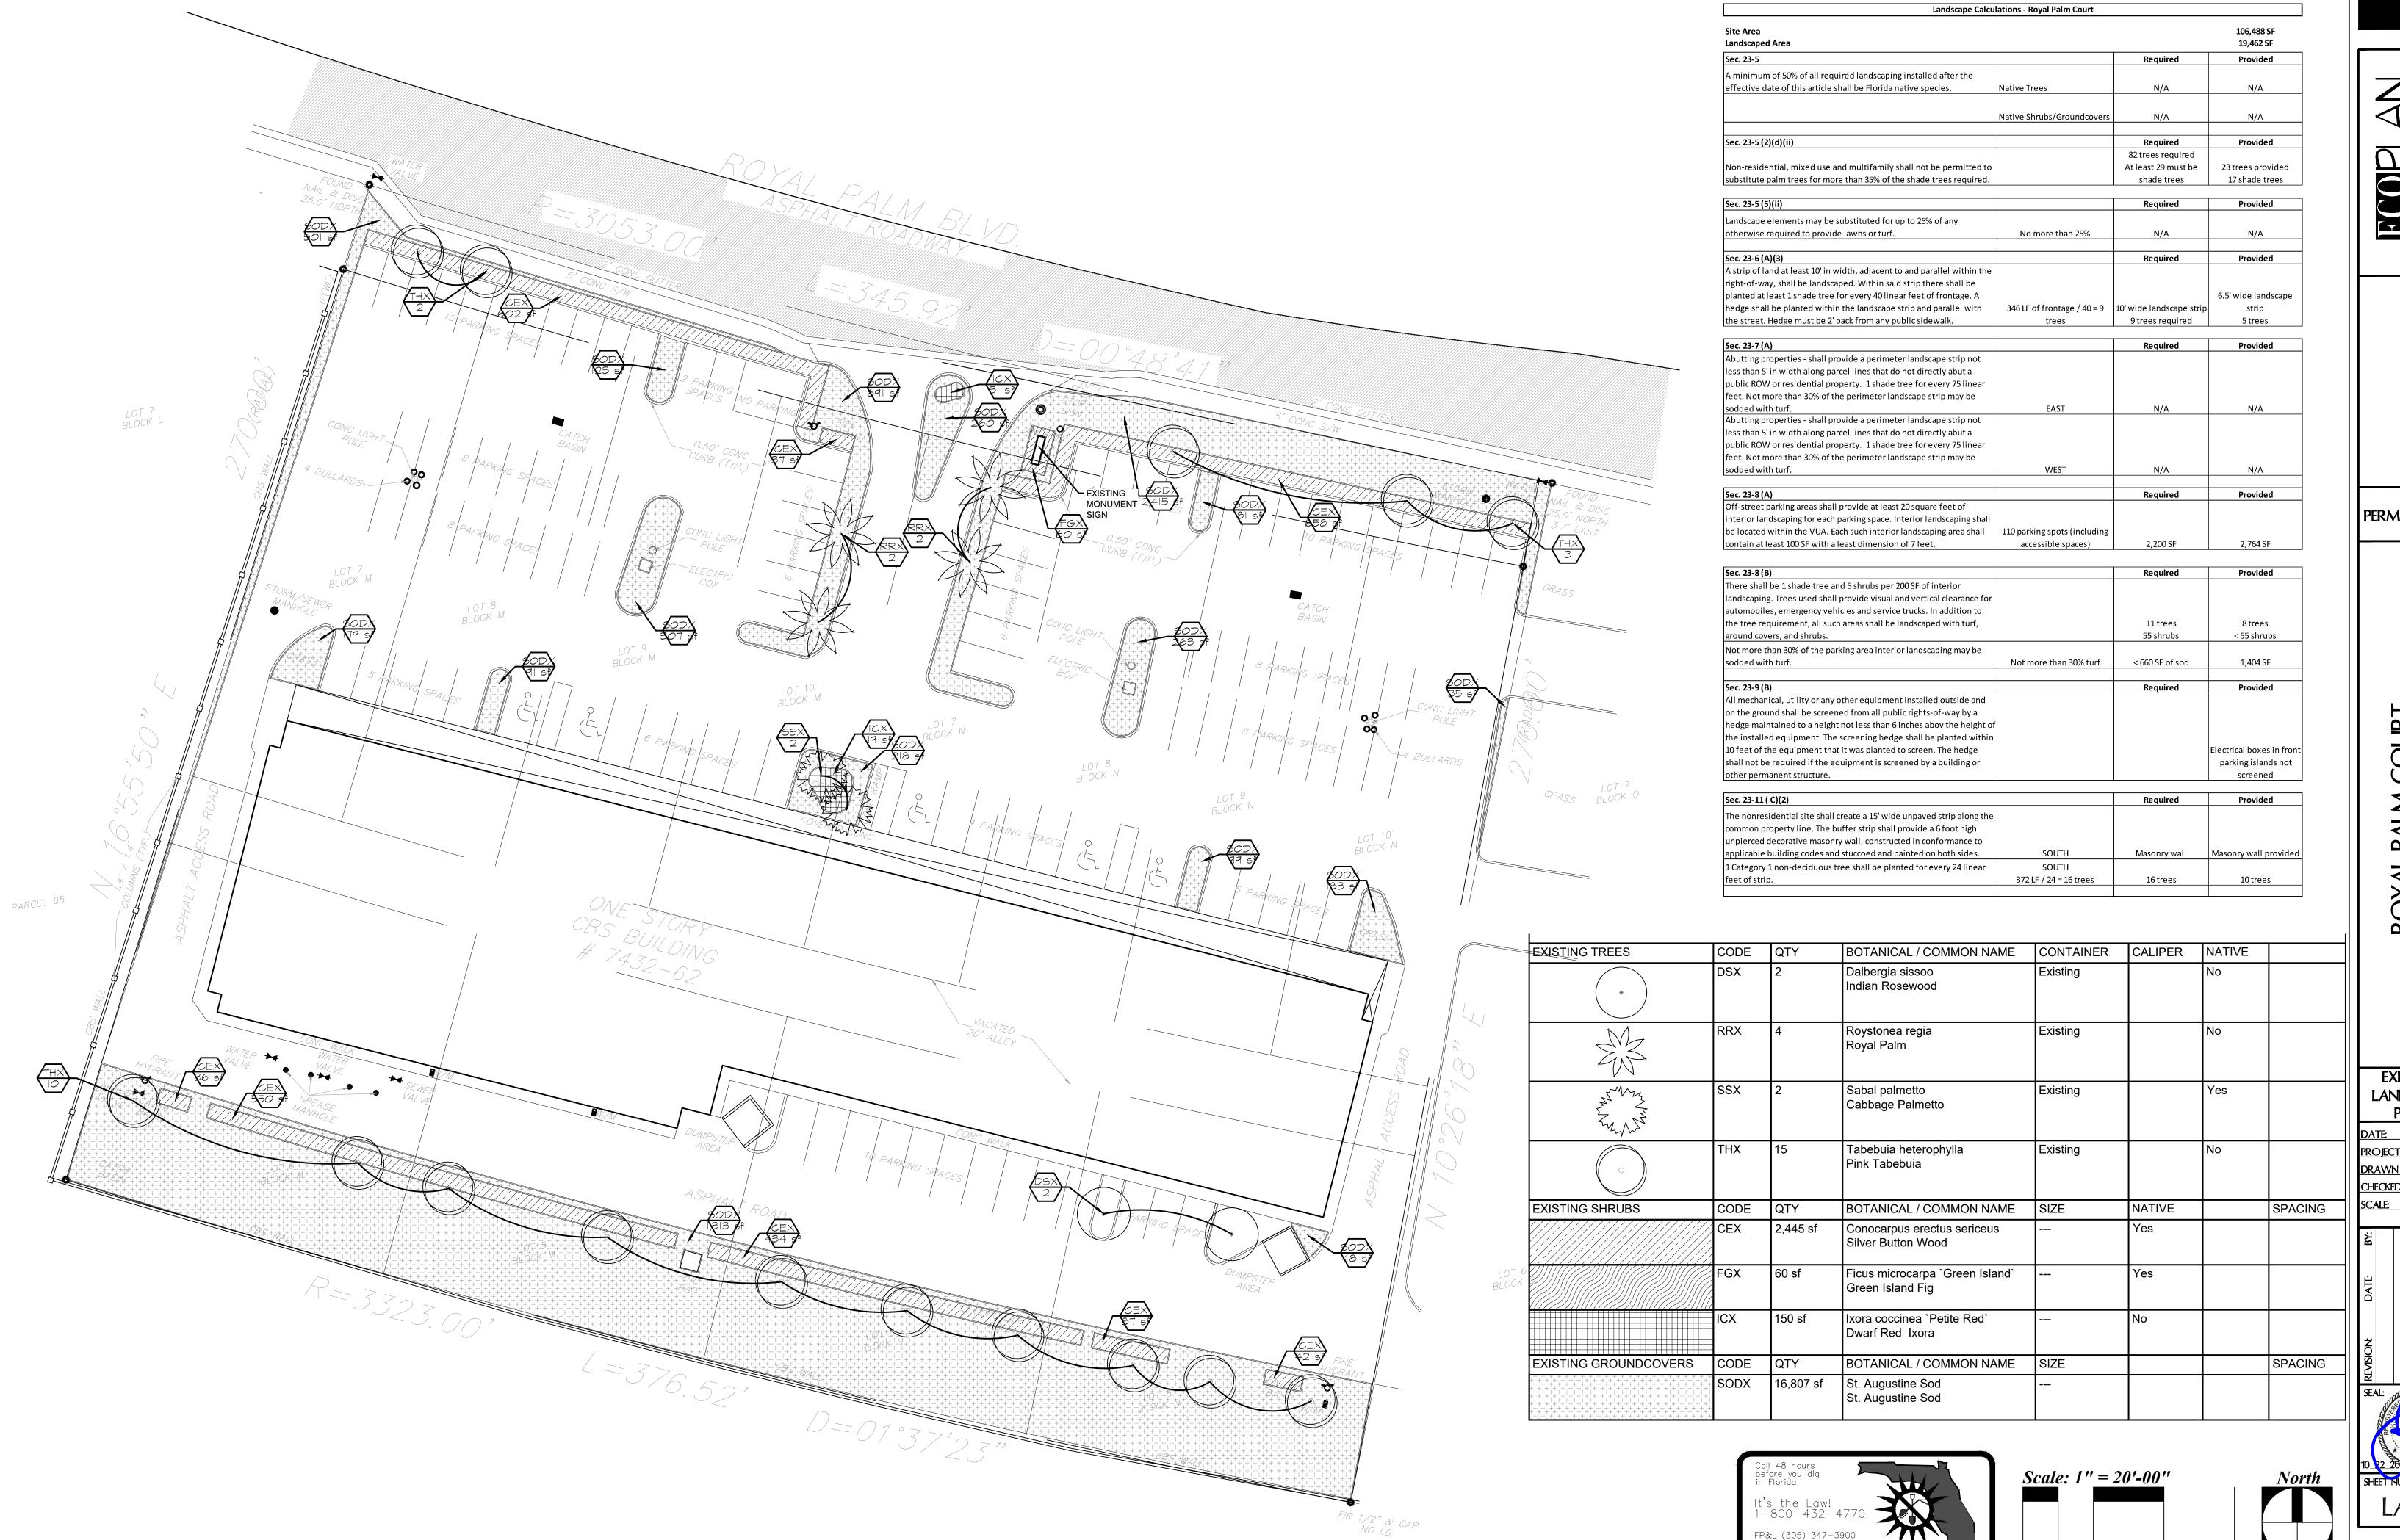EXISTING LANDSCAPE PLAN


DATE: 10/22/202 PROJECT #: 2022 DRAWN BY: HY CHECKED BY: JH

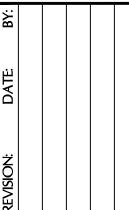

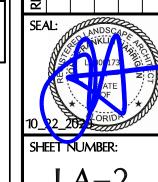

LA-2

Sunshine State One Call of Florida, Inc.

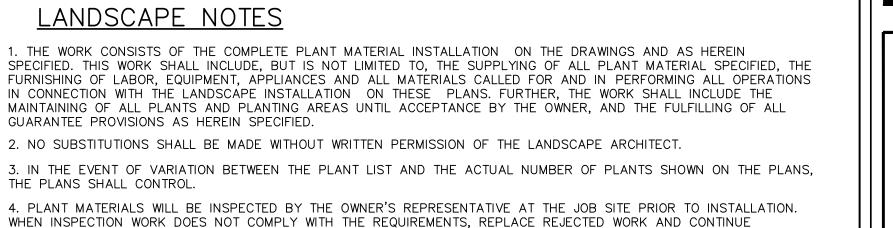

5. ALL MATERIALS AND EQUIPMENT SHALL BE INSTALLED IN A NEAT AND WORKMANLIKE MANNER. THE OWNER OR HIS REPRESENTATIVE RESERVES THE RIGHT TO DIRECT THE REMOVAL AND REPLACEMENT OF ANY ITEMS WHICH, IN HIS OPINION, DO NOT PRESENT AN ORDERLY AND REASONABLE NEAT OR WORKMANLIKE APPEARANCE, PROVIDED SUCH ITEMS CAN BE PROPERLY INSTALLED IN AN ORDERLY WAY BY TYPICAL INSTALLATION METHODS.

SPECIFIED MAINTENANCE UNTIL REINSPECTED AND FOUND TO BE ACCEPTABLE. REMOVE REJECTED PLANTS AND MATERIALS

6. ALL PLANTING BEDS SHALL BE MULCHED WITH A MINIMUM OF 2" CLEAN MULCH (NO RED OR CYPRESS MULCH) AND PLANTED ACCORDING TO PROPER HORTICULTURAL TECHNIQUES.

7. ALL TREES 2m TALL OR LARGER SHALL BE STAKED AND GUYED WITH VERTICAL 2" X 2" PINE STAKES OR 4" DIAMETER POST IN DETAILS. NO DEVIATIONS UNLESS APPROVED IN WRITING.

8. PLANTING SOIL FOR ALL PLANT MATERIALS SHALL CONSIST OF TWO (2) PARTS OF TOPSOIL WITH ONE (1) PART PEAT MOSS AND .9 kg FERTILIZER PER CUBIC METER, WELL MIXED.

9. ALL PLANT MATERIALS SHALL BE WATERED BY THE CONTRACTOR THOROUGHLY WHEN PLANTED AND DURING THE PLANTING TIME PERIOD UP TO FINAL ACCEPTANCE BY OWNER.

10. PROVIDE NEW TOPSOIL FOR TURF IN ALL SODDED AND SEEDED AREAS. TOPSOIL SHALL BE FERTILE, BLACK IN COLOR, FRIABLE, NATURAL LOAM, SURFACE SOIL, REASONABLY FREE OF SUBSOIL, CLAY LUMPS, BRUSH, WEEDS AND OTHER LITTER. AND FREE OF ROOTS, STUMPS, STONES LARGER THAN 3 cm IN ANY DIMENSION, AND OTHER EXTRANEOUS OR TOXIC MATTER HARMFUL TO SOD GROWTH. OBTAIN TOPSOIL ONLY FROM NATURALLY, WELL DRAINED SITES WHERE TOPSOIL OCCURS IN A DEPTH OF NOT LESS THAN 10 cm. DO NOT OBTAIN FROM BOGS OR MARSHES. THE CONTRACTOR SHALL PROVIDE A SOILS TEST REPORT SHOWING PH AND NUTRIENTS; - PH SHALL BE 5.5 TO 6.0. IF NOT THEN USE THE APPROPRIATE SOIL AMENDMENTS TO REACH 5.5 TO 6.0.

11. CONTRACTOR TO VERIFY ALL EXISTING UNDERGROUND UTILITIES PRIOR TO ANY DIGGING.

FROM THE PLANTING SITE WITHIN 48 HOURS AND REPLACE WITH ACCEPTABLE MATERIALS.

12. THE CONTRACTOR SHALL NOTIFY THE LANDSCAPE ARCHITECT OF ANY CONFLICT OR DISCREPANCY IN PLANS PRIOR TO PERFORMING ANY WORK IN THE AFFECTED AREA.

13. CONTRACTOR SHALL CLEAN UP AND REMOVE FROM THE PREMISES ALL SURPLUS AND DISCARDED MATERIALS AND RUBBISH FROM HIS CONSTRUCTION.

14. ALL SHRUBS, GROUNDCOVERS, AND SOD SHALL BE GUARANTEED FROM NINETY (90) DAYS AFTER FINAL ACCEPTANCE BY OWNER. ALL TREES SHALL BE GUARANTEED FOR ONE (1) YEAR AFTER FINAL ACCEPTANCE BY OWNER.

15. FINAL INSPECTION WILL NOT TAKE PLACE UNTIL ALL MATERIALS ARE PLANTED/INSTALLED CORRECTLY. CONTRACTOR WILL REQUEST A FINAL INSPECTION BY WRITTEN LETTER TO OWNER. 16. UPON NOTICE OF FINAL ACCEPTANCE, THE OWNER WILL ASSUME MAINTENANCE AND THE GUARANTEE/WARRANTY PERIOD BEGINS.

17. ALL SODDED AREAS SHALL BE HAND WATERED UNTIL TURF IS ESTABLISHED.

18. CONTRACTOR TO NOTIFY/VERIFY WITH LANDSCAPE ARCHITECT, THE AVAILABILITY (QUANTITY & QUALITY PRESCRIBED IN THE DRAWINGS) OF ALL PLANT MATERIAL SPECIFIED AT THE TIME OF BID.

19. CONTRACTOR TO SUBMIT TO LANDSCAPE ARCHITECT PROOF THAT MATERIALS HAVE BEEN SECURED 60 DAYS PRIOR TO SCHEDULED INSTALLATION. IF SUBSTITUTIONS ARE REQUIRED, LANDSCAPE ARCHITECT WILL RE-SPECIFY AND CONFIRM NEWLY SPECIFIED MATERIALS ARE AVAILABLE (QUALITY & QUANTITY PRESCRIBED IN THE DRAWINGS) CONTRACTOR TO SUBMIT TO LANDSCAPE ARCHITECT PROOF THAT NEWLY SPECIFIED MATERIALS HAVE BEEN SECURED 45 DAYS PRIOR TO

20. ALL PLANT MATERIAL SCHEDULED FOR INSTALLATION WILL BE INSPECTED AND PHOTOGRAPHED BY LANDSCAPE ARCHITECT 30 DAYS PRIOR TO SCHEDULED INSTALLATION. CONTRACTOR WILL BE RESPONSIBLE FOR MAINTAINING THE CONDITION OF ALL PLANT MATERIAL FROM THE TIME OF INSPECTION BY THE LANDSCAPE ARCHITECT TO THE TIME OF INSTALLATION. IF CONDITION OF PLANT MATERIAL (SIZE, QUALITY & HEALTH) IS REDUCED FROM THE TIME OF INSPECTION, THAT PLANT MATERIAL WILL BE REJECTED.


21. CONTRACTOR INSTALLING THE PLANT MATERIAL AT THE SITE WILL BE RESPONSIBLE FOR MAINTAINING THE CONDITION AND HEALTH OF THE MATERIAL (AS DOCUMENTED IN THE PHOTOGRAPHS AT THE TIME OF INSPECTION) FROM THE TIME OF INSTALLATION TO THE TIME OF TURNING OVER THE PROJECT TO THE OWNER OR OPERATOR. IF THE CONTRACTOR FAILS TO MAINTAIN THE MATERIAL AS SPECIFIED, THAT PLANT MATERIAL WILL BE REJECTED

22. ALL LANDSCAPE AREAS MUST BE IRRIGATED FROM A NON-POTABLE WATER SOURCE.


23. IRRIGATION SHALL HAVE AT LEAST A 50% OVERLAP.

24. LANDSCAPED AREAS TO BE MAINTAINED TO EDGE OF PAVEMENT IN RIGHT-OF-WAY.



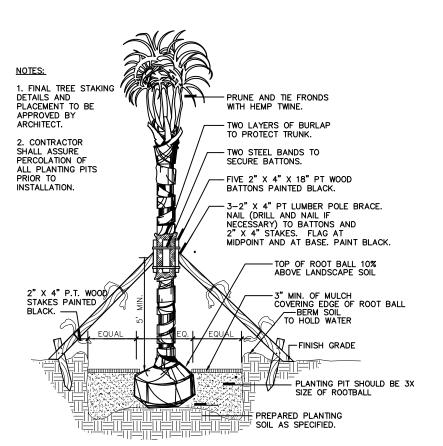



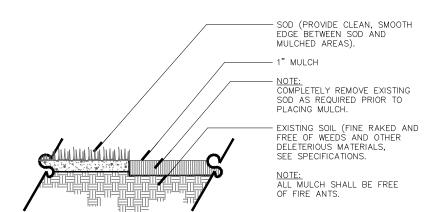

NUIL. NI SHRUBS AND CROUNDCOVER MASSES TO USE TRIANGULAR SPACING EXCEPT WHERE NOTED REFER TO PLANT LIST FOR - CURB OR EDGE OF PAVEMENT.

GRASS / MULCH EDGE DETAIL

SCALE= NTS

—— 3" MINIMUM OF MULCH

GROUNDCOVER BED.

---- SOIL BERM TO HOLD WATER

SPECIFIED FOR GROUND-COVER BED.

(SEE GRADING PLAN)

PREPARED PLANTING SOIL

NOTE:

1. FINAL TREE STAKING TO BE INSTALLED AS PER CITY OF PLANTATION REQUIREMENTS.

ROPE TIED TO EACH WOOD

PENETRATE ROOT BALL. 2" MINIMUM OF MULCH

(SEE GRADING PLAN)

- SOIL BERM TO HOLD WATER

SEE SPECIFICATIONS FOR

ROOT BALL REQUIREMENTS PLANTING PIT SHOULD BE 3X SIZE OF ROOTBALL

- PREPARED PLANTING SOIL

ORNAMENTAL TREE DETAIL

—•FIVE 2" X 4" X 18" WOOD

-3-2" X 4" LUMBER POLE BRACE. NAIL (DRILL AND NAIL IF NECESSARY) TO BATTONS AND 2" X 4" STAKES. FLAG AT MIDPOINT AND AT BASE.

- BERM SOIL TO HOLD WATER

PALMATE PALM PLANTING DETAIL

PALMS SIMILAR W/ BOOTS AND SKIRTS INTACT.

2. SEE PLANS AND SPECS. FOR PALMS W/BOOTS TO REMAIN ON TRUNK.

3. FINAL TREE STAKING

DETAILS AND
PLACEMENT TO BE

APPROVED BY

4. CONTRACTOR

PRIOR TO INSTALLATION.

SHALL ASSURE PERCOLATION OF ALL PLANTING PITS

THREE-2" X 4" X 6'-6" STAKES

PITS PRIOR TO INSTALLATION

AS SPECIFIED. NOTE: WHEN GROUNDCOVERS AND SHRUBS ARE

USED IN MASSES, THE ENTIRE BED IS TO BE EXCAVATED TO RECEIVE

PLANTING SOIL MIXTURE AND PLANT

NSHRUB AND GROUNDCOVER LAYOUT

SCALE= NTS


NOTE: CONTRACTOR SHALL ASSURE PERCOLATION OF ALL PLANTING PIT BIODEGRADABLE ROPE TIED T EACH TREE AND SUPPORTED IN THE GROUND WITH 3 1"X2"X12" WOOD STAKES BURIED SO TOP IS 1" BELOW — 3" MINIMUM OF MULCH - 2" X 4" X 3/8" STAKES PLANTING PIT SHOULD BE 3X SIZE OF ROOTBALL FE SPECIFICATIONS FOR ROOT BALL REQUIREMENTS). - PREPARED PLANTING

GROUNDCOVER PLANTING

SCALE= NTS


SCALE= NTS

TREE PLANTING DETAIL SECTION

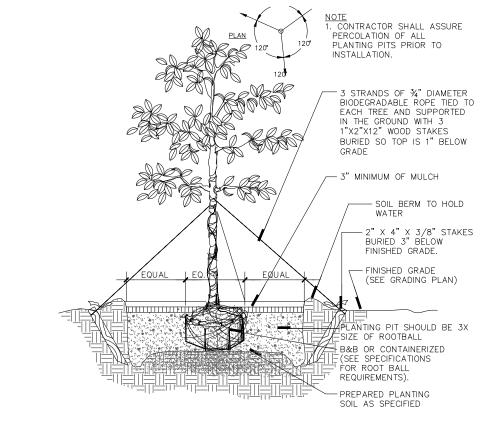

TREE PLANTING DETAIL SECTION



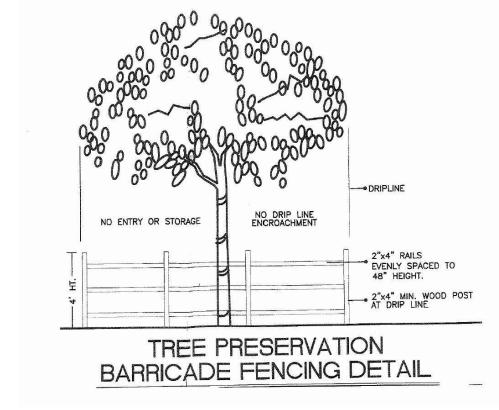

TREE PROTECTION FENCE SCALE= NTS SECTION

RELOCATING PALM NOTES:


- 2-3 WEEKS BEFORE RELOCATION, PRUNE ROOT BALL APPROX. 18" ON EACH SIDE OF TRUNK. IF POSSIBLE, PRUNE "SAMPLE TREE" TO TEST IF 18" IS ACCURATE FOR ROOT PRUNING. IF ACCURATE, YOU WILL BE CUTTING A GOOD AMOUNT OF ROOTS.

- 2-3 WEEKS BEFORE RELOCATION, APPLY MIXTURE OF LIQUID FUNGICIDE AND INSECTICIDE TO BALL. IRRIGATE WELL.

- THE DAY BEFORE, IRRIGATE TREE WELL. TRIM 2' OFF TIPS OF FRONDS AND TIE BACK FRONDS TO PREVENT ROT

RELOCATING CANOPY TREE NOTES:

- 12 WEEKS (MINIMUM) BEFORE RELOCATION, PRUNE ROOT BALL. ROOT PRUNING SIZE AND EXTENT TO BE DETERMINED BY CERTIFIED ARBORIST

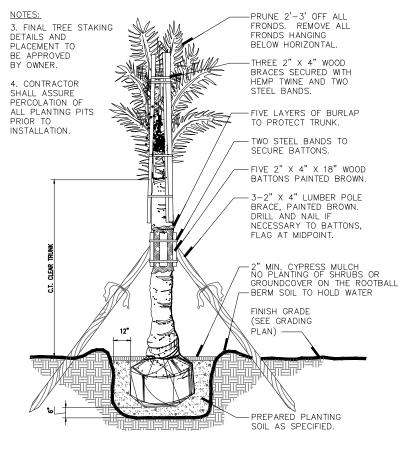

Barrier shall run length of planter edge. MINIMUM 8" COVER OVER TOP OF BARRIER. SET BARRIER A MINIMUM OF 4" BELOW THE FINISHED GRADE. BARRIER SHALL EXTEND 7.5' FROM THE (ALTERNATIVE ROOT BARRIER MAY BE UTILIZED WITH APPROVAL OF LANDSCAPE ARCHITECT)

1. Shrub and groundcover hatch are diagrammatic in nature.

When installing material, do not plant on top of the rootball.

where new planting is proposed.

2. Remove all road rock from planting areas, including islands

3. Install root barrier between relocated trees and paved area.

SCALE= NTS

ROOT BARRIER SCALE= NTS



PERMIT PLANS

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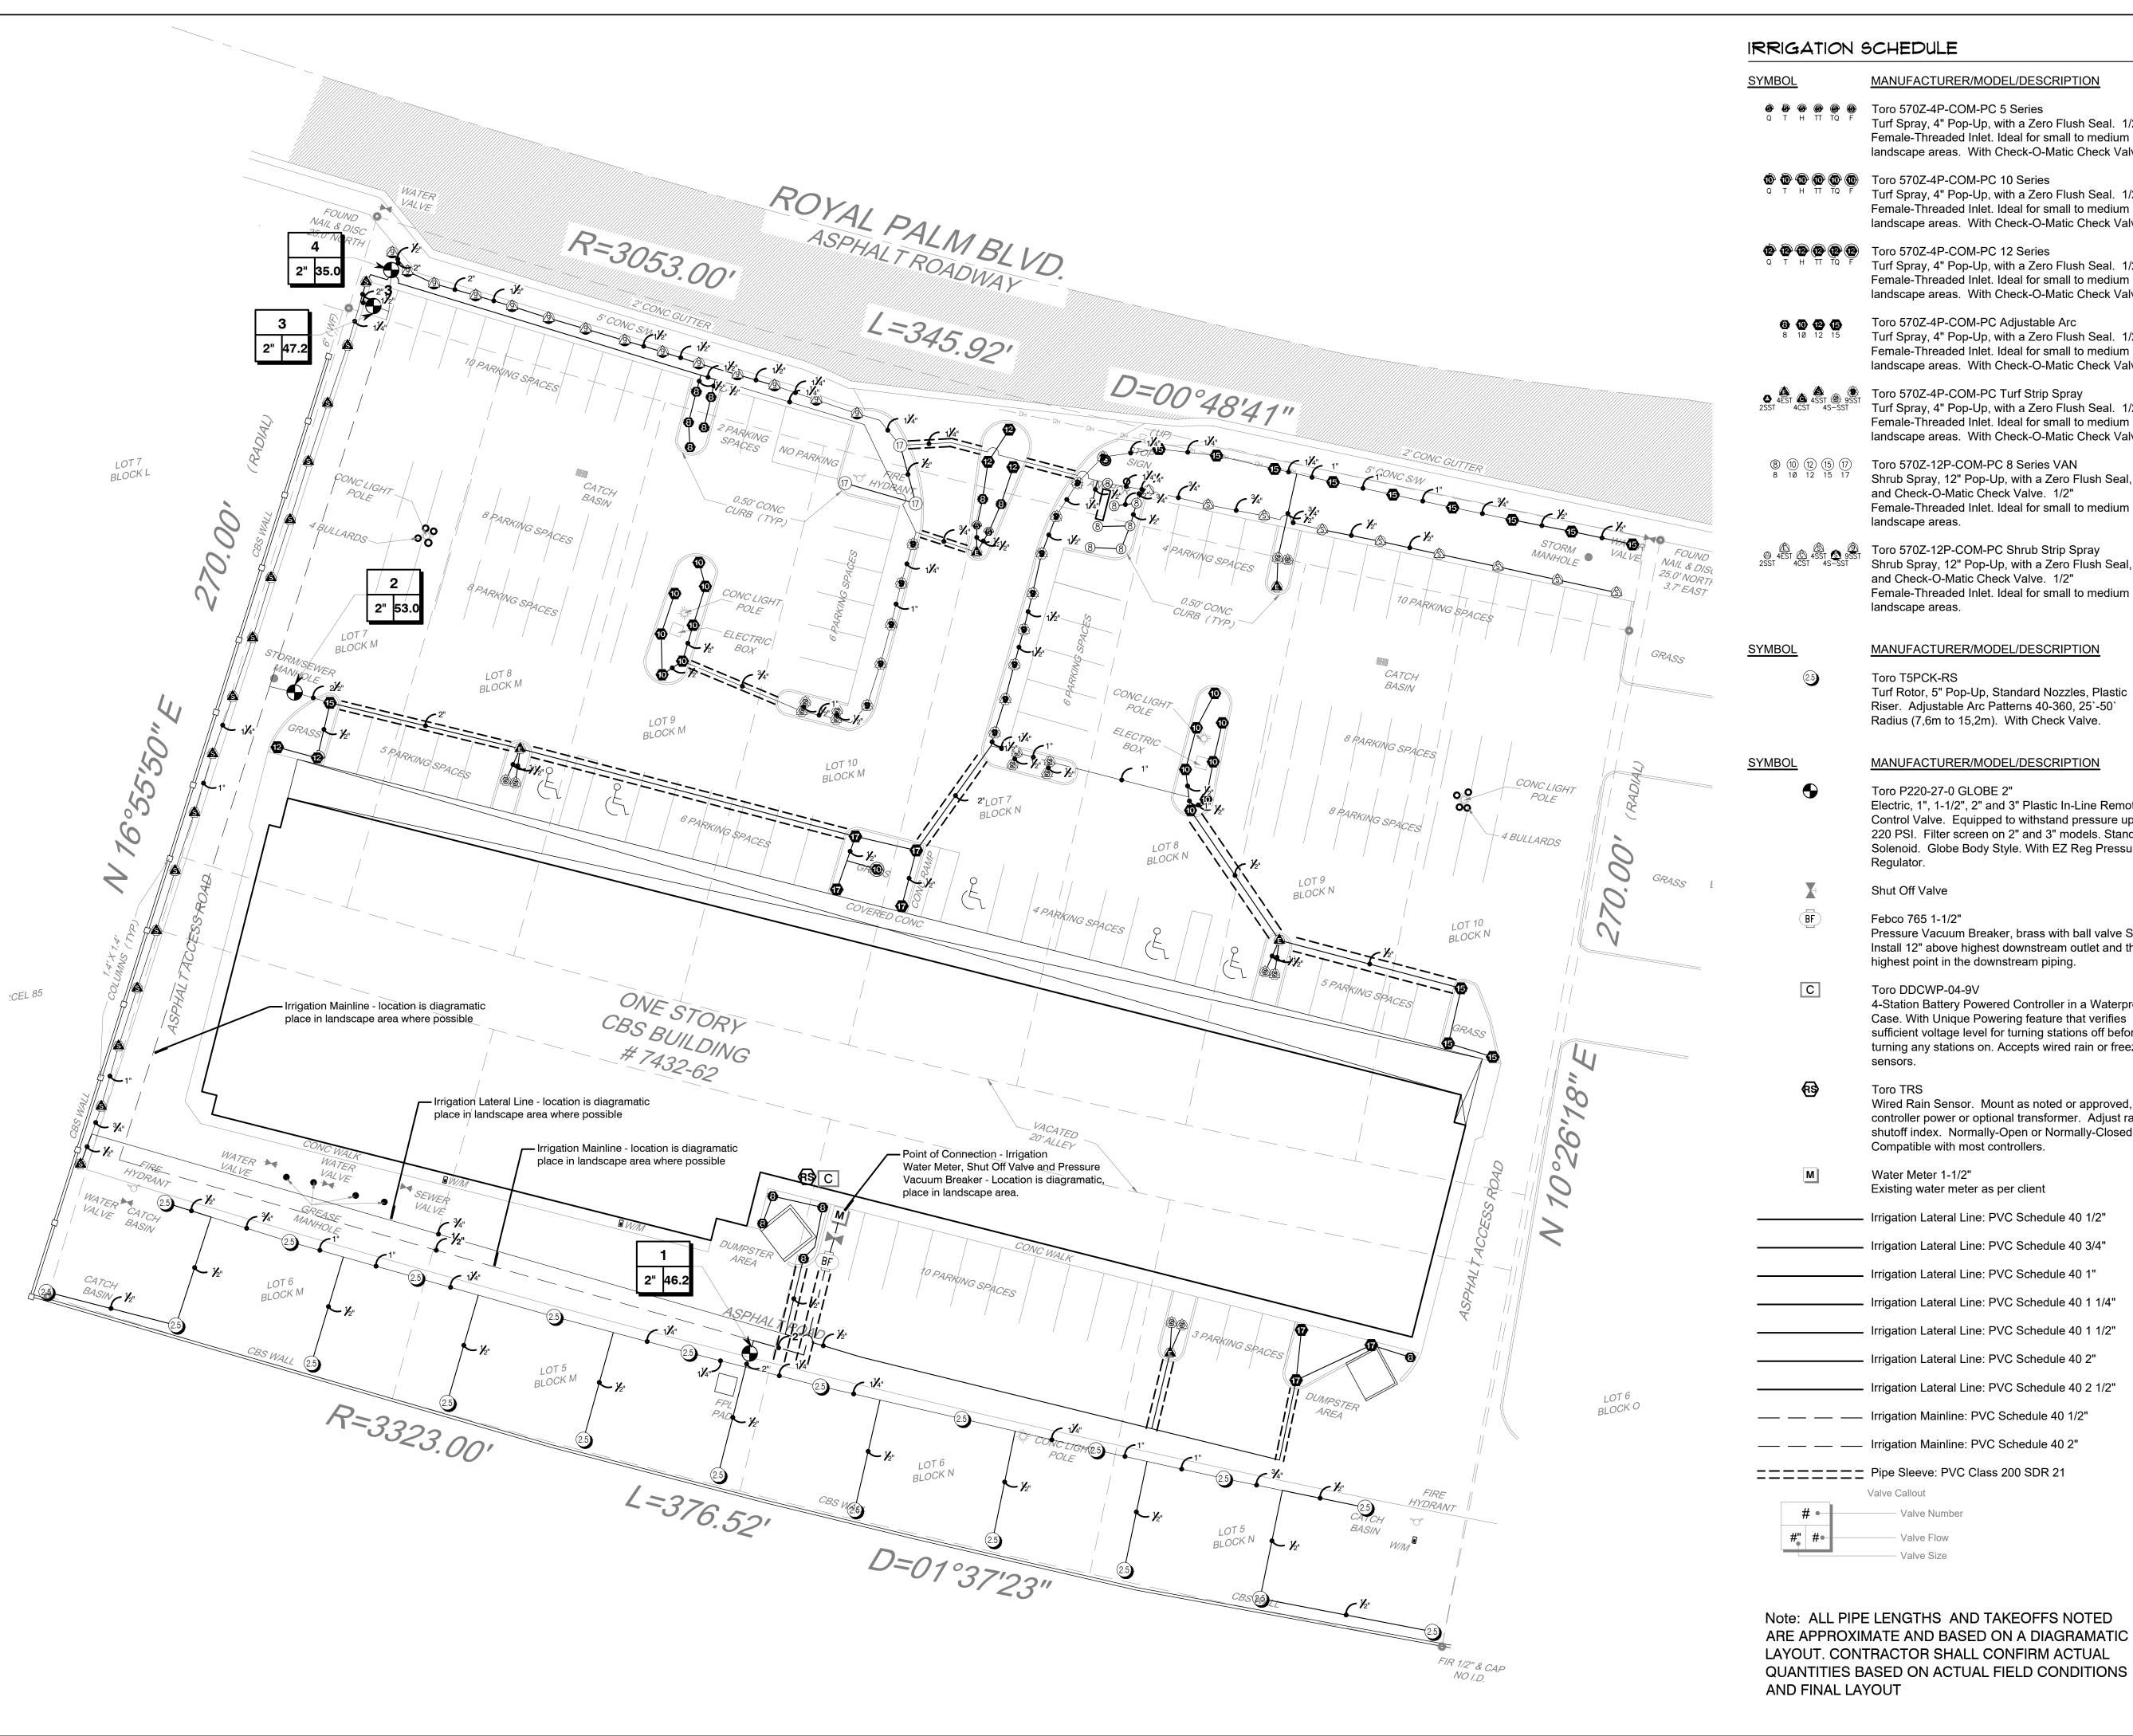
PLANTING DETAILS


DATE: 10/22/202 PROJECT #: 2022 DRAWN BY: HY CHECKED BY: JH

1″=20′

SHEET NUMBER:

LA-3



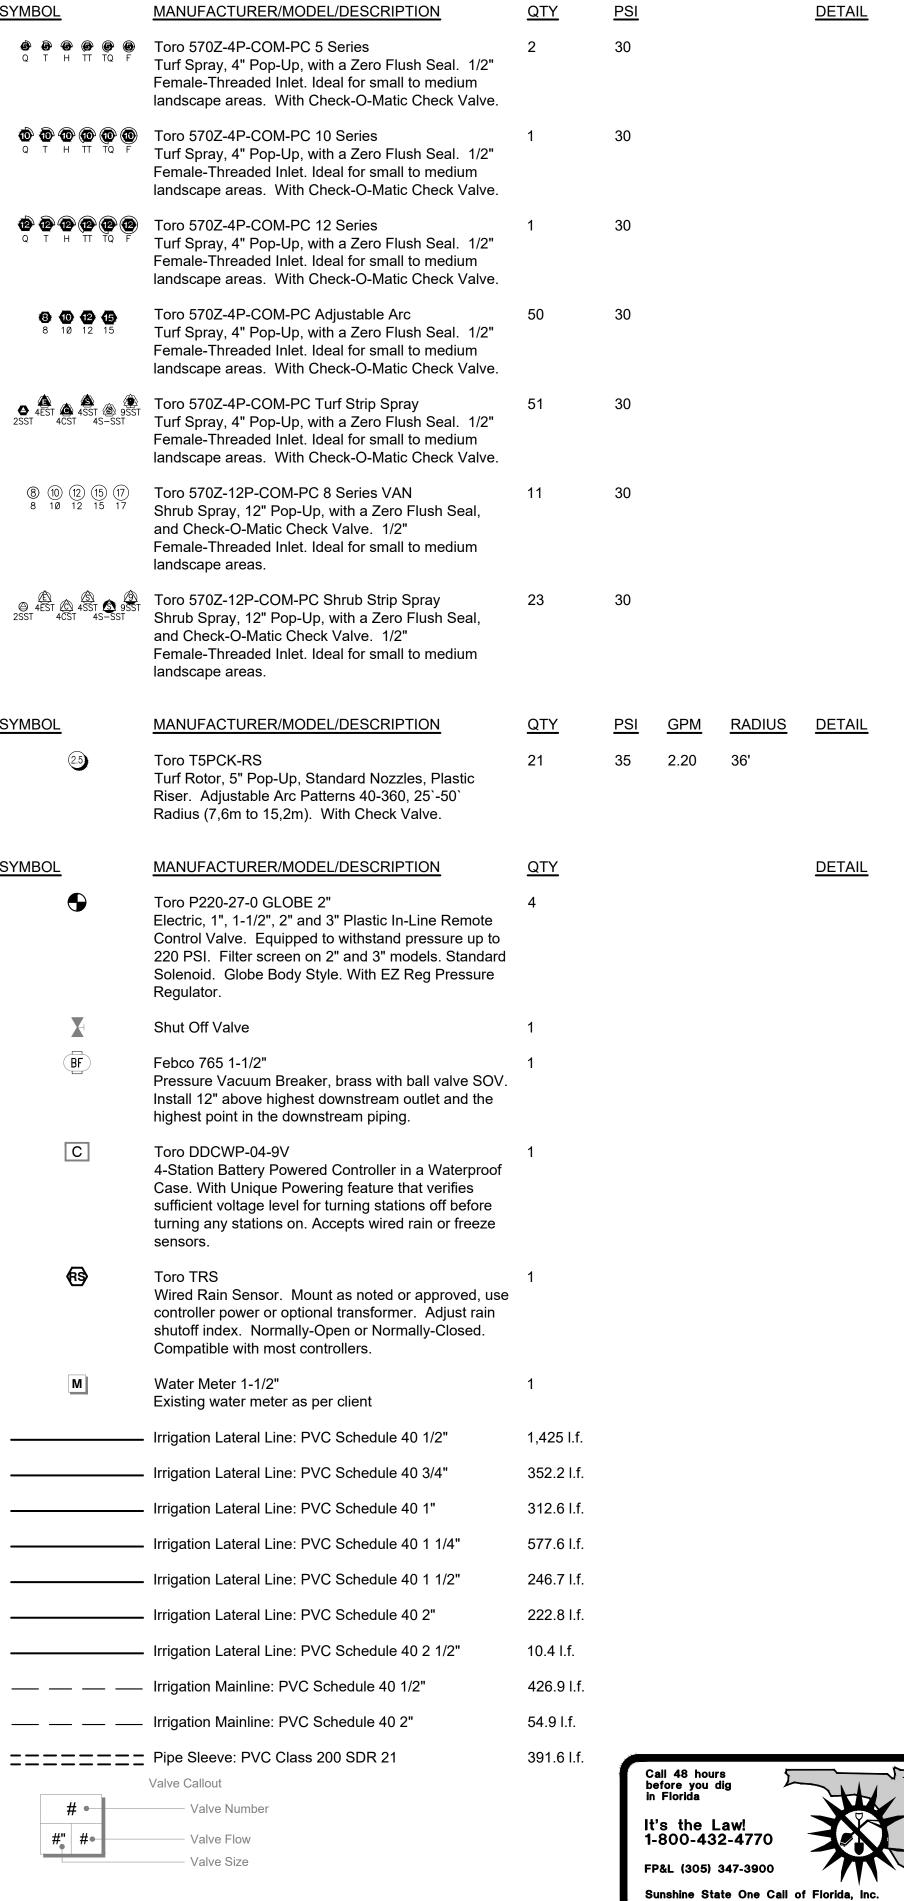

Scale: 1" = 20'-00"

ECOLOGICAL / BANK

PERMIT PLANS


IRRIGATION PLAN


DATE: 6/11/2021 PROJECT #: 2022 DRAWN BY: MH CHECKED BY: JH SCALE: 1"=20'


SEAL:

North


SHEET NUMBER: IR-1

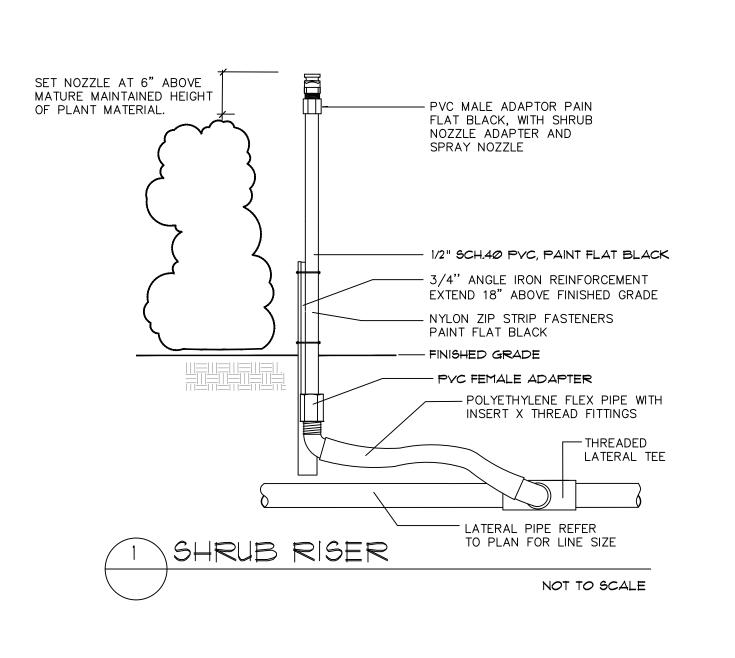


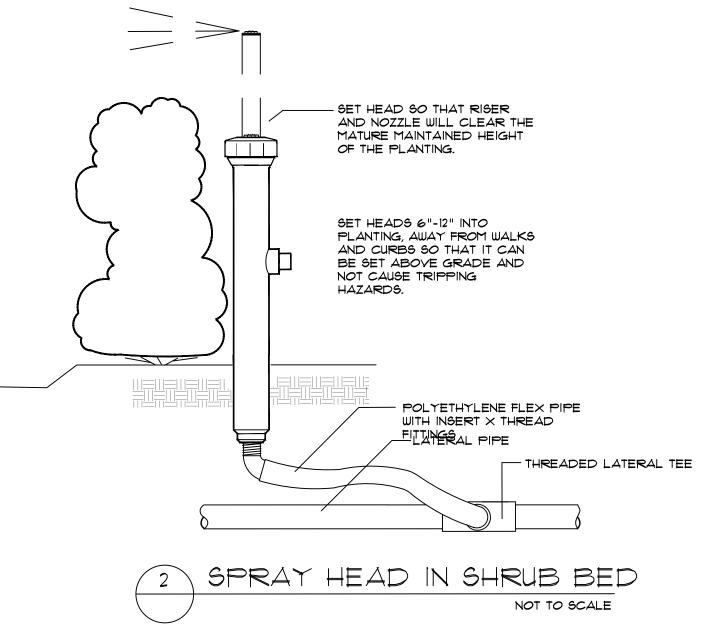


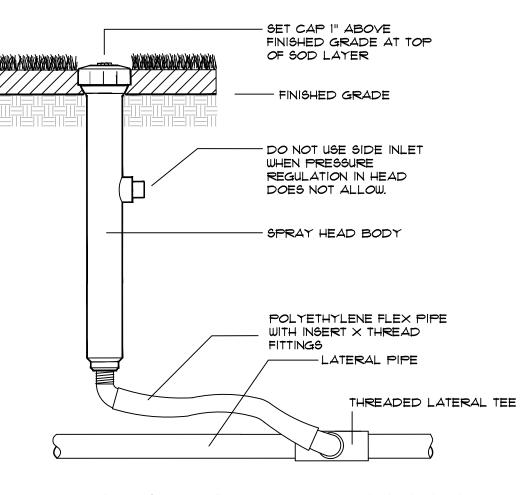

3 POP UP SPRAY BODY IN TURE

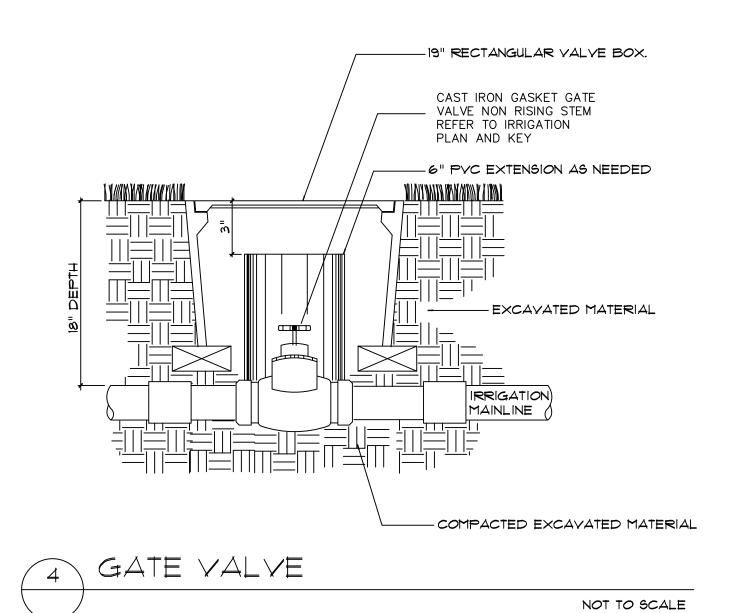

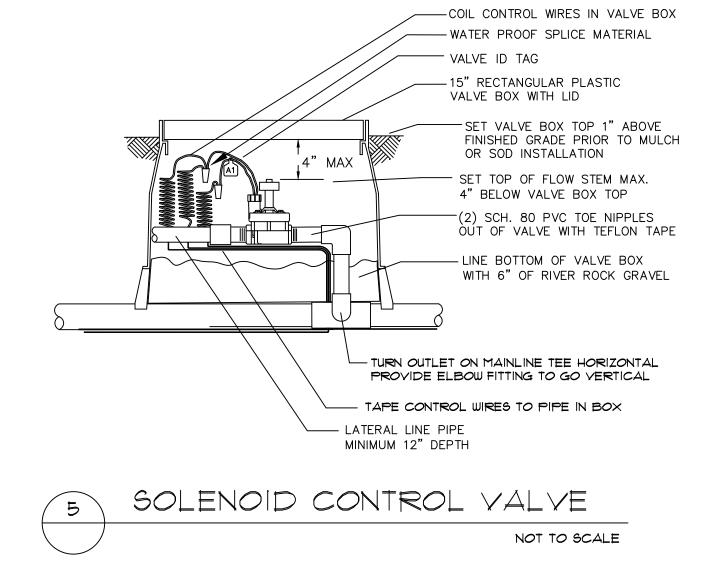

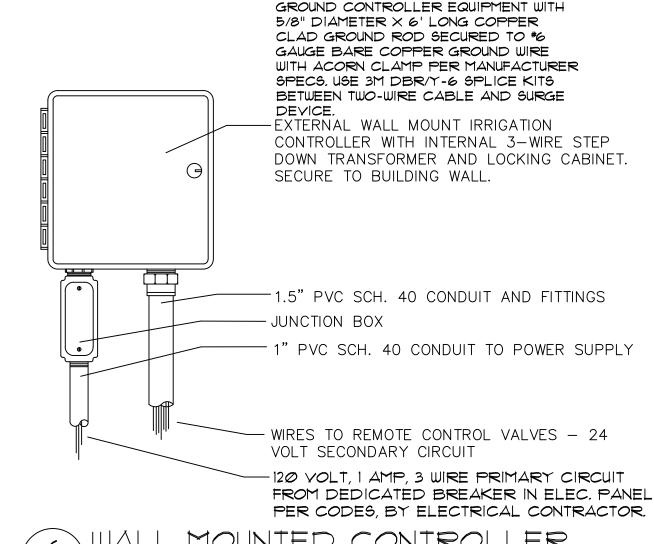

6 WALL MOUNTED CONTROLLER
NOT TO SCALE


IRRIGATION NOTES


- I.) SOME PIPE LINES ARE DRAWN OFF SET FOR CLARITY. INSTALL ALL IRRIGATION LINES IN LANDSCAPED AREAS.
- 2.) REFER TO THE LANDSCAPE PLANS WHEN TRENCHING TO AVOID TREE ROOT BALLS TO INSTALL HEADS AT APPROPRIATE LOCATIONS.
- 3.) ADJUST ALL NOZZLES TO REDUCE OVERTHROW ON PAVING \$
 WALLS. THROTTLE ALL IRRIGATION CONTROL VALVES AS REQUIRED
 TO PREVENT FOGGING. SET CONTROLLER RUN TIMES TO MATCH PLANT
 WATER NEEDS AND SOIL CONDITIONS.
- 4.) INSTALL RISERS 18" FROM WALLS OR BUILDINGS, AND 24" FROM PAVED SURFACES. PAINT ALL RISERS AND SUPPORTS FLAT BLACK.
- 5.) INSTALL POP-UP HEADS 18" FROM WALLS, 6" FROM WALKS, DECKS AND CURBS, 6 FEET FROM CURBLESS ROADS, AND 12" FROM THE END OF PARKING SPACES.
- 6.) SET TOP OF POP-UP HEAD CAPS I" ABOVE FINISHED GRADE PRIOR TO SOD OR MULCH INSTALLATION.
- 7.) REFER TO UTILITY PLANS PRIOR TO TRENCHING. THE IRRIGATION INSTALLER SHALL BE RESPONSIBLE FOR THE REPAIR OF ANY DAMAGE TO UTILITIES CAUSED BY THEIR WORK DURING THE PROJECT.
- 8.) ALL WORK SHALL BE GUARANTEED FOR ONE YEAR FROM THE DATE OF FINAL ACCEPTANCE AGAINST ALL DEFECTS IN EQUIPMENT AND WORKMANSHIP.
- 9.) ELECTRIC POWER SUPPLY FOR THE IRRIGATION CONTROLLER SHALL BE BROUGHT TO A JUNCTION BOX AT THE CONTROLLER LOCATION BY THE BUILDING ELECTRICAL CONTRACTOR. IRRIGATION INSTALLER TO PROVIDE ELECTRICAL PERMITS AND LICENSED ELECTRICIAN TO CONNECT THE IRRIGATION CONTROLLER EQUIPMENT TO THE POWER SUPPLY IG.) IRRIGATION WATER CONNECTIONS AND SYSTEM CONSTRUCTION
- SHALL COMPLY WITH THE REQUIREMENTS OF LOCAL CODES FOR IRRIGATION INSTALLATION AND CONNECTIONS TO THE WATER SUPPLY.

 II.) IRRIGATION INSTALLER TO ACQUIRE ALL PERMITS AND UTILIZE ALL
- 12.) SIXTY (60) PSI MINIMUM STATIC WATER PRESSURE IS REQUIRED FOR THE EFFICIENT OPERATION OF THE IRRIGATION SYSTEM AS DESIGNED. VERIFY THE MINIMUM STATIC WATER PRESSURE IS AVAILABLE AT THE PROJECT SITE PRIOR TO BEGINNING THE IRRIGATION INSTALLATION. NOTIFY THE LANDSCAPE ARCHITECT IN WRITING IF THE MINIMUM STATIC WATER PRESSURE OR WATER VOLUME IS NOT AVAILABLE.


SAFETY PRECAUTIONS REQUIRED TO WORK IN ROW OF ROADWAY

- 13.) AT THE END OF PARKING SPACES PLACE HEADS IN LINE WITH PARKING STRIPES OR 2.5 FEET FROM BACK OF WHEELSTOP. (TYPICAL)
- 14.) PRIOR TO STARTING THE WORKS INSPECT THE SITE AND LOCATE ALL EXISTING IRRIGATION PIPES, WIRES AND EQUIPMENT. PROVIDE LABOR AND MATERIALS TO REPAIR ANY DAMAGED EXISTING IRRIGATION. PROVIDE "LIFELINE" PIPES AND WIRES TO KEEP ADJACENT IRRIGATION ZONES OPERATIONAL THROUGHT THE WORKS.
- 15.) THE IRRIGATION MAINLINE IS DRAWN OFFSET FOR GRAPHIC CLARITY. DO NOT SCALE THE MAINLINE FROM THE DRAWING FOR INSTALLATION. LAYOUT THE IRRIGATION MAINLINE ROUTE IN THE FIELD TO AVOID PROPOSED AND EXISTING TREE ROOT ZONES AND UTILITIES. ALL PIPE SHALL BE INSTALLED WITHIN LANDSCAPE AREAS UNLESS INDICATED OTHERWISE THROUGH SLEEVES.
- I6.) CONTRACTOR SHALL FAMILIARIZE THEMSELVES WITH THE EXISTING IRRIGATION SYSTEM THROUGH AS-BUILTS AND SITE INSPECTION TO ENSURE THAT EXISTING SYSTEM IS RETROFITTED AS PART OF THE NEW DESIGN AND THAT ALL EXISTING IRRIGATION TO REMAIN SHALL REMAIN OPERATIONAL. THE SYSTEM IS DESIGNED SO NO WATER SHALL EXCEED 5 FEET PER SECOND VELOCITY THROUGH PIPE. NOTIFY THE LANDSCAPE ARCHITECT IMMEDIATELY IF EXISTING SYSTEM IS UNDERSIZED TO ACCOMODATE THE NEW DESIGN CHARACTERISTICS.

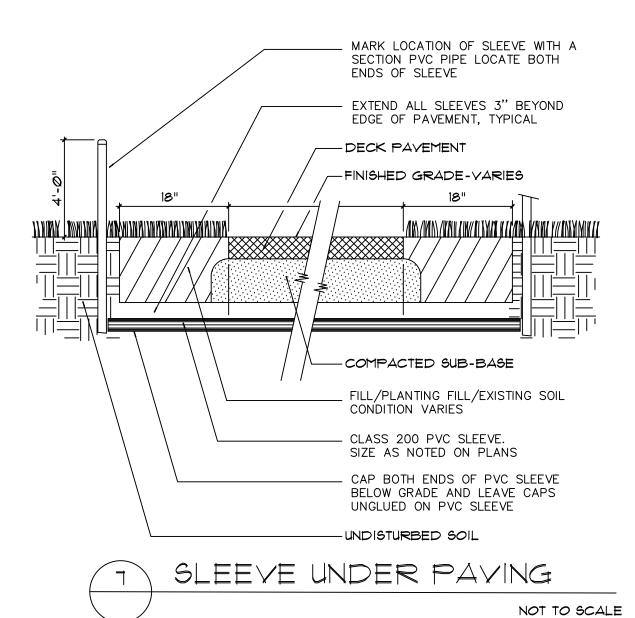


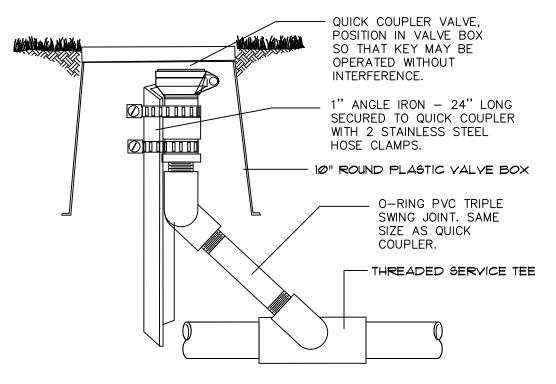



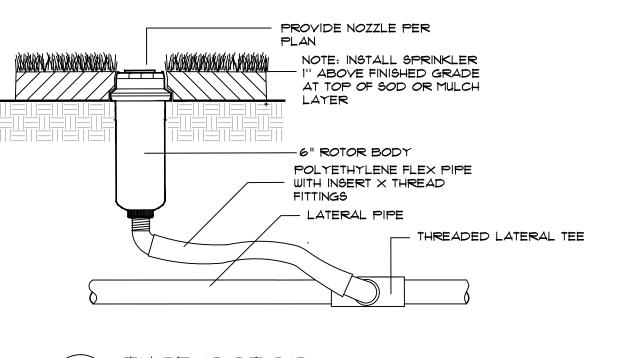



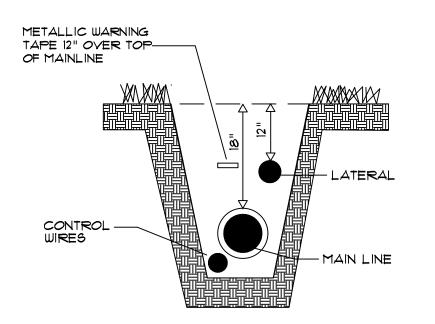

TYPICAL TRENCHING

NOT TO SCALE



ECOLOGICAL / BIVIRONMBNTAL LAND PLANNIC
LAND USE ANALYSIS LANDSCAPE ARCHTECTURE
888 SOUTH ANDREWS AVRUE, SUITE 303
FORT LANDROME, R. 33316
FPH (954) 524-372

PERMIT PLANS

/AL PALM COURT

PLANTING DETAILS

 DATE:
 6/11/2021

 PROJECT #:
 2022

 DRAWN BY:
 MH

 CHECKED BY:
 JH

 SCALE:
 1″=20′

ASION: DATE: BY:

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SHEET NUMBER: IR-2